Appendix E: Urban Design and Landscape Concept



PUBLIC REALM PRINCIPLES



CLEAR & INTUITUVE

I know where I'm going.

A generous and clear groundplane with an enhanced sense of arrival.

Strengthen east/west connectivity

Clear connections from beyond the precinct.



SAFE & WELCOMING

I feel safe. I can stay or just pass through at night or day.

Clear sightlines and lighting to enhance feelings of safety.



TREES & SHADE

Create a sense of human scale and enclosure.

Provide shade, shelter and thermal comfort.



MULTI-FUNCTIONAL

Flexibility of the public realm to allow for a number of different uses & functions.



CULTURALLY & SOCIALLY INCLUSIVE

Spaces that promote social, cultural and knowledge exchange.

KEY THEMES



OUTDOORISH

Brooks Country Feel Simple Experiencing Seasons

The Byford station precinct contributes a country feel to the town centre. The hills and brooks can be experienced everywhere with each season creating its own spectacle. Spaces and buildings remind people of the natural landscape and rural farms while accommodating the urban convenience of a town centre. Life happens preferably outside and spaces provide for that. Even hikers and horses can be seen in town.



GROWING

Buzz of the old and new Exploring and developing Youthful & Fresh Grounded

The Byford Station precinct is a place of becoming, its a place of settling in a settled environment. Old and new go together hand-in-hand. The place feels comfortable and safe. It is youthful and forward looking while remembering the past; the orchards, the brickworks and country.



INFORMAL


Open and Friendly Relaxed Peaceful Playful

Complementing the other two themes, the Byford station precinct feels informal, open and relaxed. It is a place breathing a slow pace even when people might be rushing through to catch their train. The place is functional and organised, but without looking rigid and constricting. It is playful, fluent and friendly.

BYFORD PRECINCT ZONES




LANDSCAPE MASTERPLAN - DAY 1

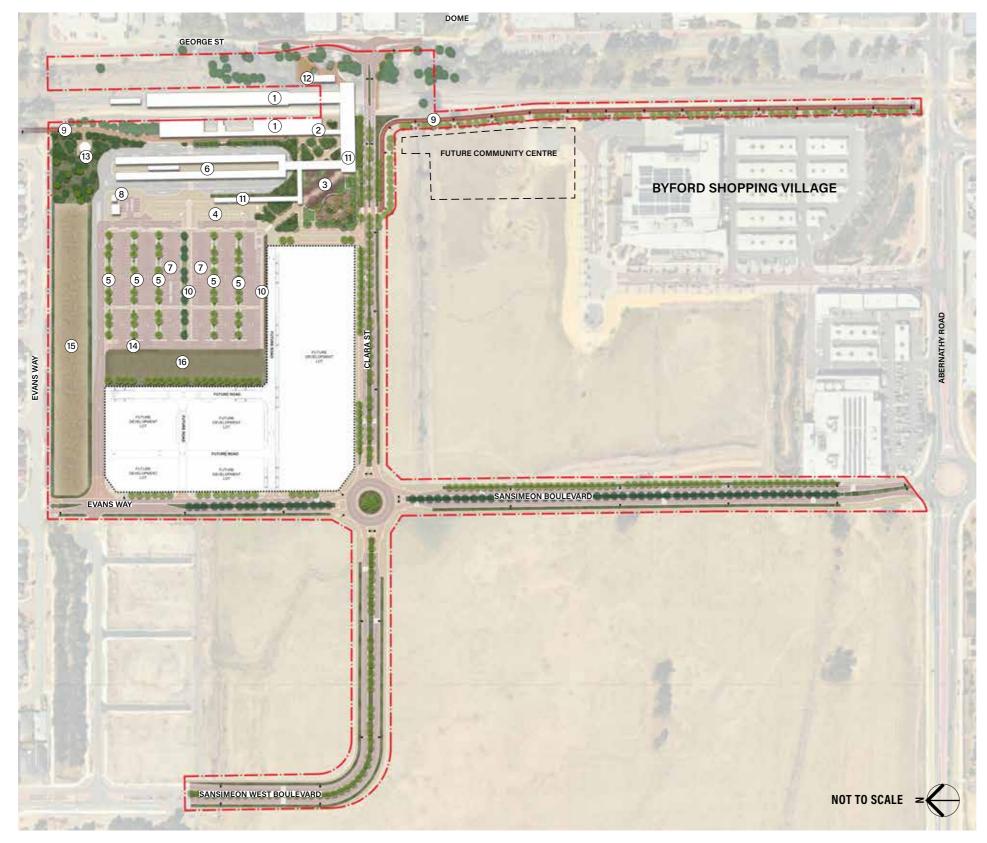

LEGEND

- 1 Train Station
- ② Kiosk
- (3) Public Precinct
- 4 Kiss & Ride
- (5) WSUD
- (6) Bus Terminal
- Public Parking
- (8) Staff Parking
- 9 Principal Shared Path
- 10 Pedestrian Pathway
- (11) Shelters
- 12 Bicycle Shelter
- (13) Irrigation Tank
- (14) Access Road
- (15) Multi-Use Corridor
- (6) Revegetation


LANDSCAPE MASTERPLAN - DAY 1 - PUBLIC PRECINCT

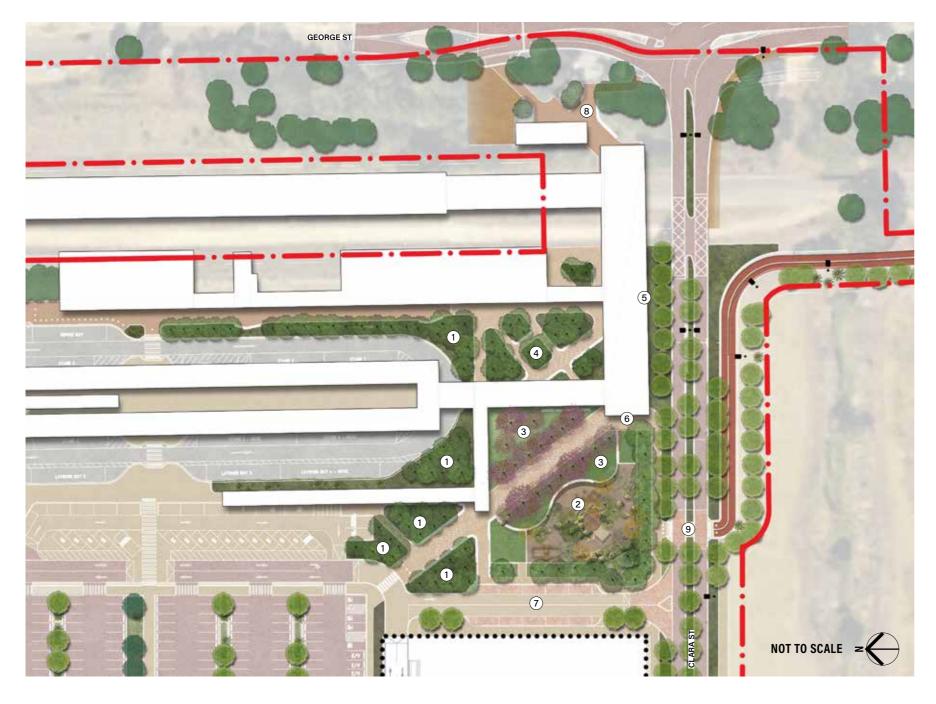

LEGEND

- 1 Welcome Gardens
- 2 Play Space
- 3 The Green
- (4) Bush Plaza
- 5 Bike Racks
- 6 Cafe cart opportunity
- 7 Plaza St including power & water
- George St Entry
- 9 Clara St Crossing


LANDSCAPE MASTERPLAN - ULTIMATE

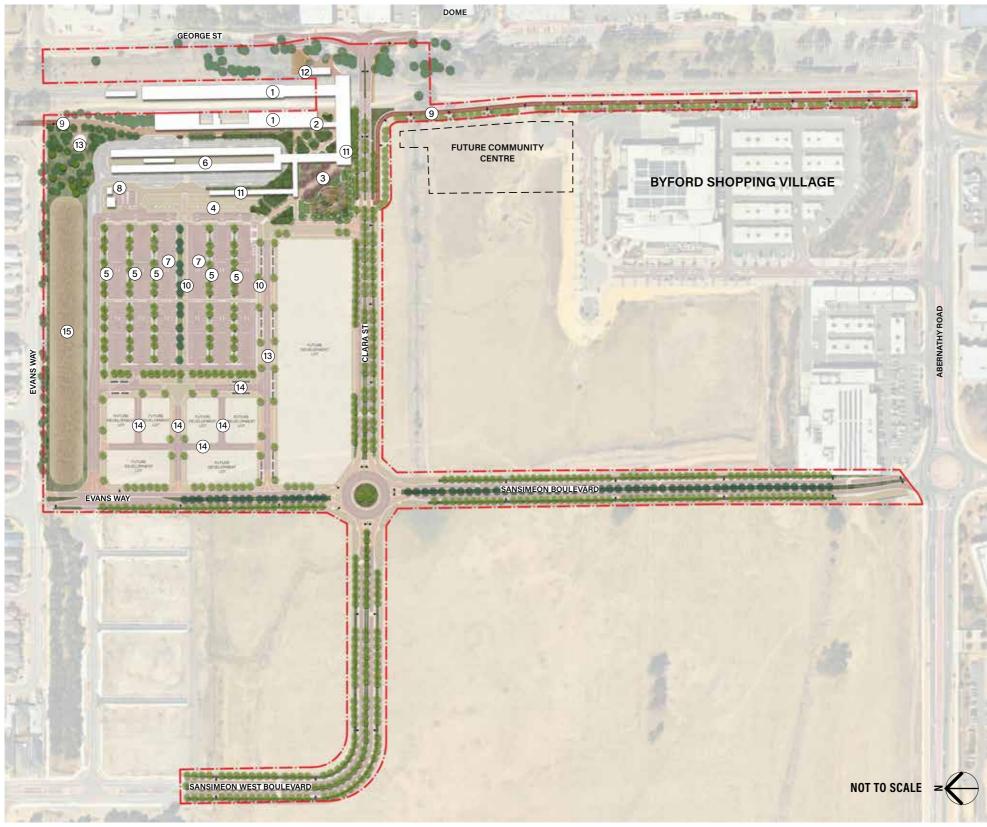

LEGEND

- 1 Train Station
- 2 Kiosk
- (3) Public Precinct
- 4 Kiss & Ride
- (5) WSUD
- (6) Bus Terminal
- (7) Public Parking
- (8) Staff Parking
- (9) Principal Shared Path
- 10 Pedestrian Pathway
- 11) Shelters
- 12) Bicycle Shelter
 - (3) Irrigation Tank
 - (14) Future Roads
 - (15) Multi-Use Corridor


LANDSCAPE MASTERPLAN - ULTIMATE - PUBLIC PRECINCT

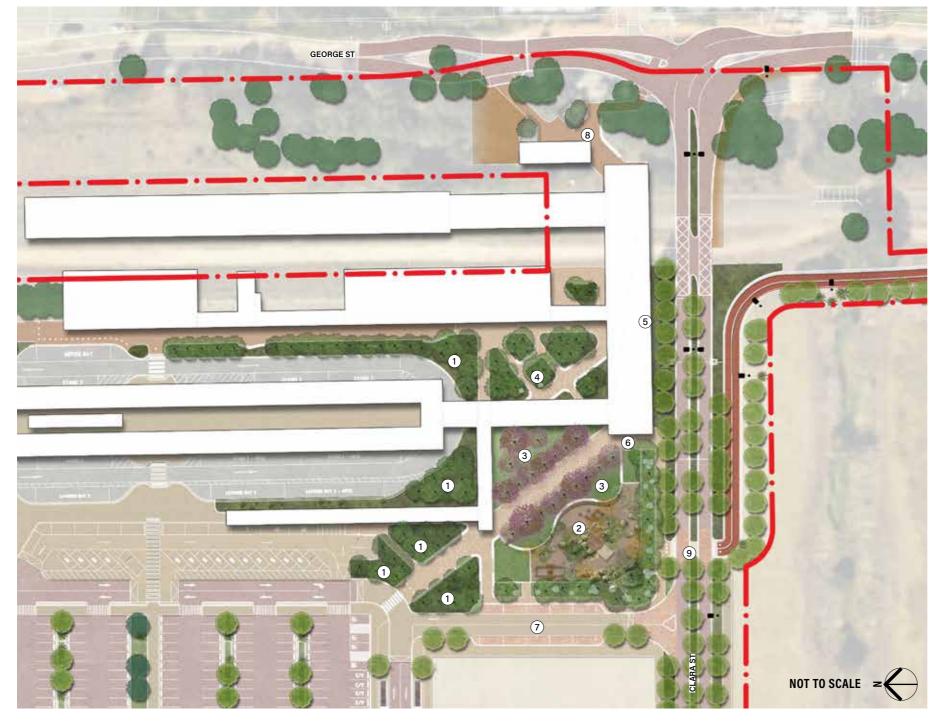


LEGEND

- (1) Welcome Gardens
- 2 Play Space
- 3 The Green
- 4 Bush Plaza
- (5) Bike Racks
- 6 Cafe cart opportunity
- Plaza St including power & water
- 8 George St Entry
- Clara St Crossing

INVESTMENT DIAGRAM

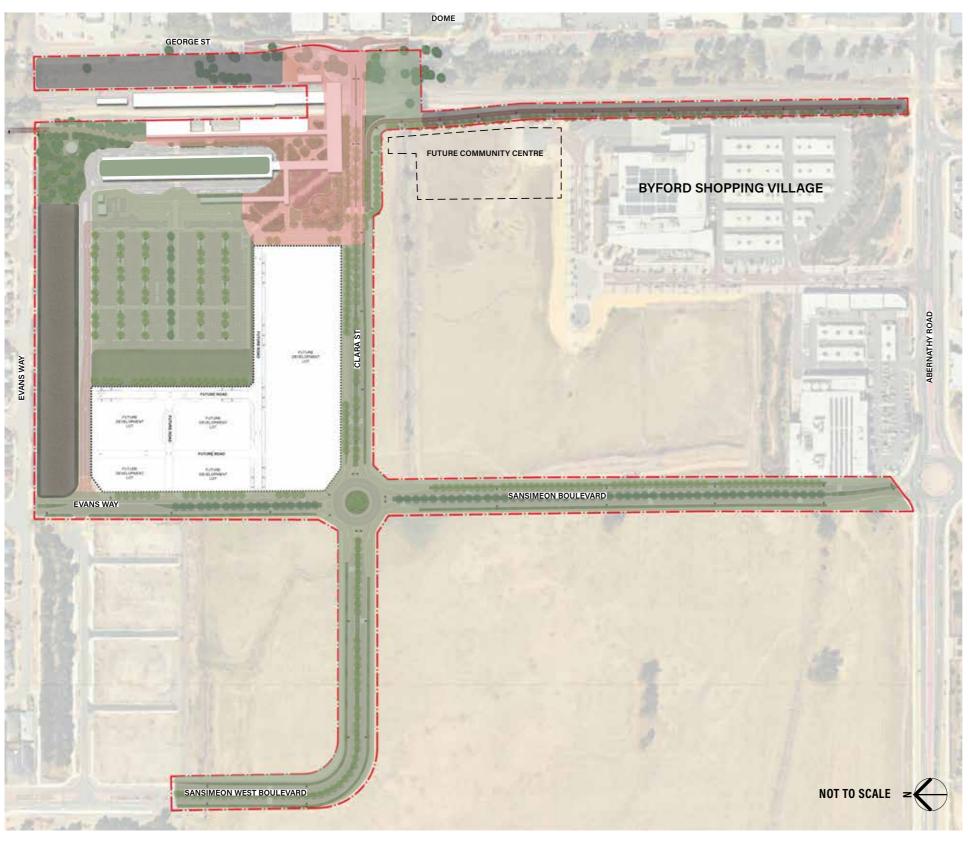

LEGEND

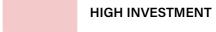





_____ EXTENT OF WORKS

TREE RETENTION

A canopy mapping exercise was undertaken in March 2023 to develop baseline canopy data. The existing canopy pre-development is:

- ~ 9,501 M² OF CANOPY
- ~ 8.22% CANOPY COVERAGE WITHIN DEVELOPMENT ENVELOPE


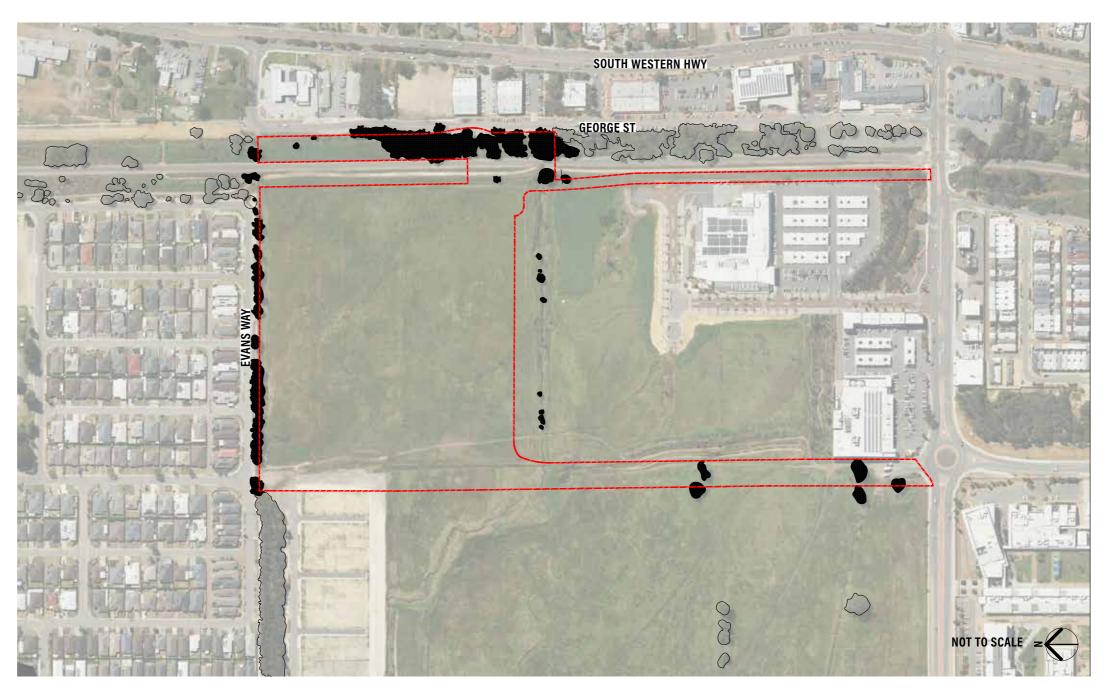




FIGURE 1. EXISTING BASELINE CANOPY WITHIN THE DEVELOPMENT ENVELOPE - MARCH 2023

PROJECTED CANOPY YEAR 10

- ~ 33,718M² PROJECTED CANOPY
- ~ 29.17% PROJECTED CANOPY

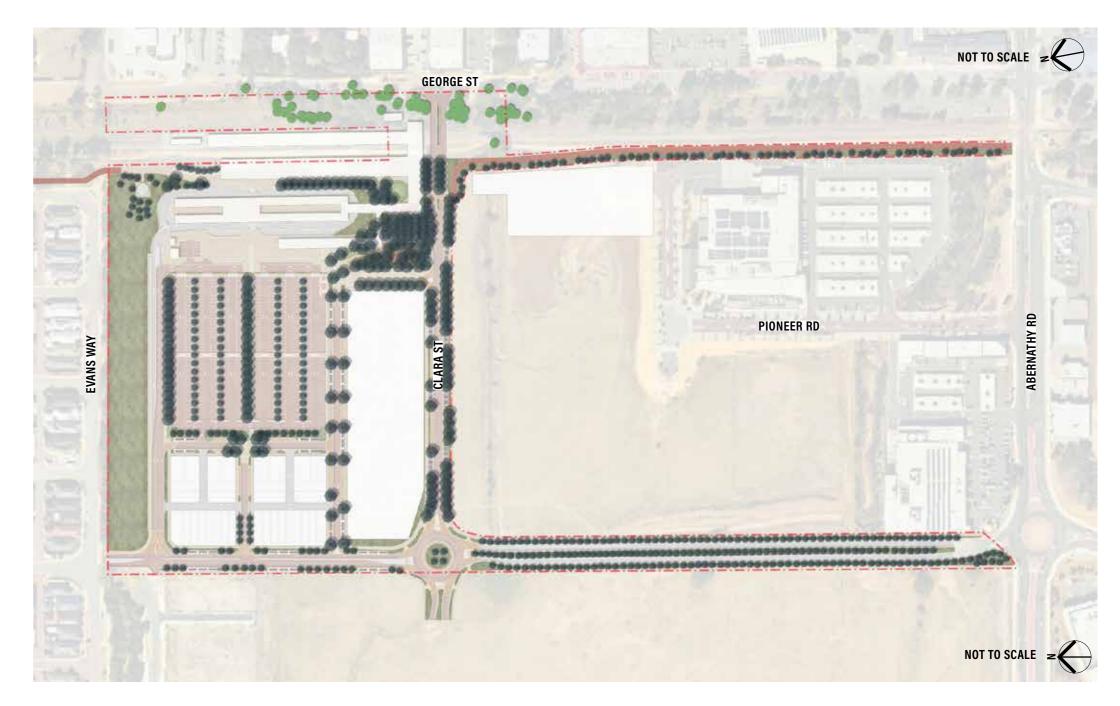

KEY

DEVELOPMENT ENVELOPE




EXISTING TREE CANOPY



PROPOSED TREES

FIGURE 2. LIKELY CANOPY PROJECTION YEAR 10 - MARCH 2023

SECTIONAL STUDY

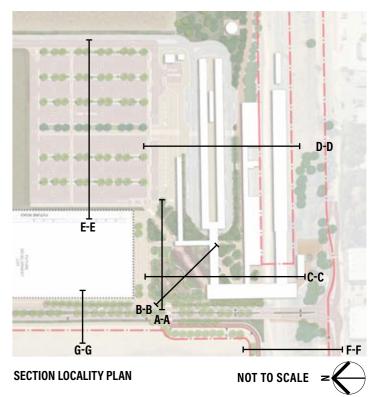



SECTION A-A



SECTION B-B



SECTION C-C



SECTION D-D



SECTION E-E




SECTION F-F



SECTION G-G

BUSH PLAZA

Tall, clear trunked trees to provide shade, shelter Clear sightlines.
Simple and uncluttered space
Approx 600m2
Low walled seating elements
Safe & well lit

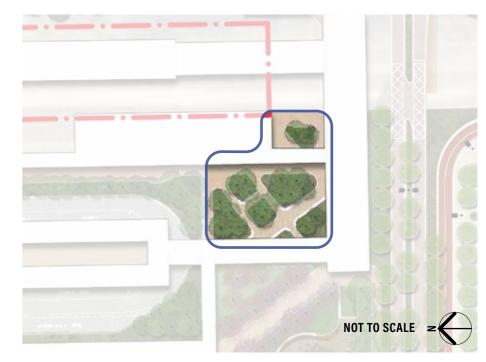



PLAZA ST - FUNCTION & USE

Plaza St provides a simple, flexible space for markets, food trucks, and events.

Opportunity for 10+ food trucks.


~Close down PLaza St

Lighting, power and water integrated



THE GREEN

Turf can be used for activation and events
Deciduous trees located on north side provide
shade and shelter in summer and sun in winter
Low seating walls provides an occupiable edge,
Sloped turf area
Double row of trees along Clara St

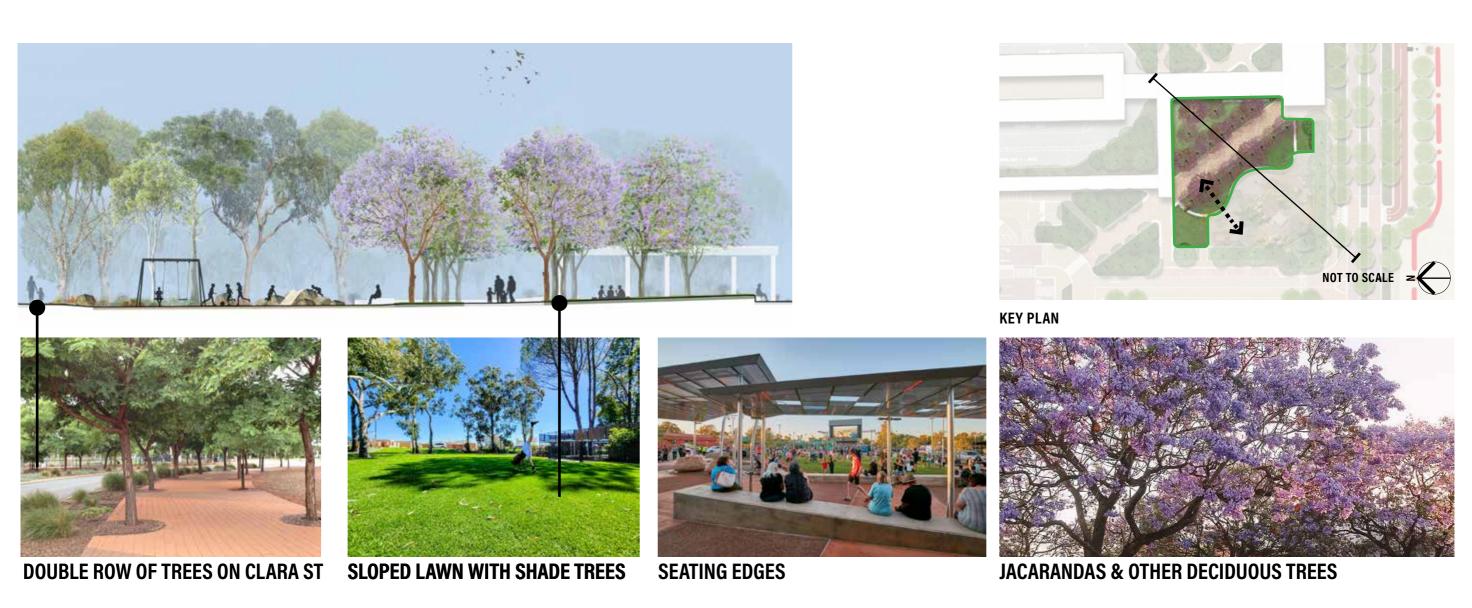

THE PLAY SPACE


A nature playground, with seating walls and shade trees.

Multipurpose elements celebrate local materials and serve as meeting places or play
Celebrates the local fauna & flora







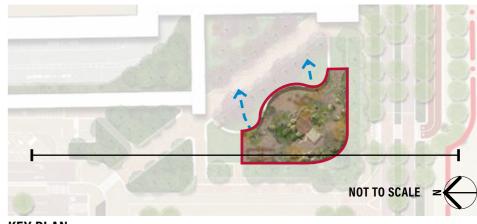

COLOURS & TEXTURES

SUBTLE ART & STORY TELLING OPPORTUNITIES

SEATING

KEY PLAN











CELEBRATE WATER IN LANDSCAPE MISTERS/SENSORY


RAKALI

NATURE PLAY

SUBIACO THEATURE PLAY SPACE

CIRCULATION & SEATING

Clear, generous, shaded and safe pathways, access for food trucks and vehicles with regular places of rest and respite.

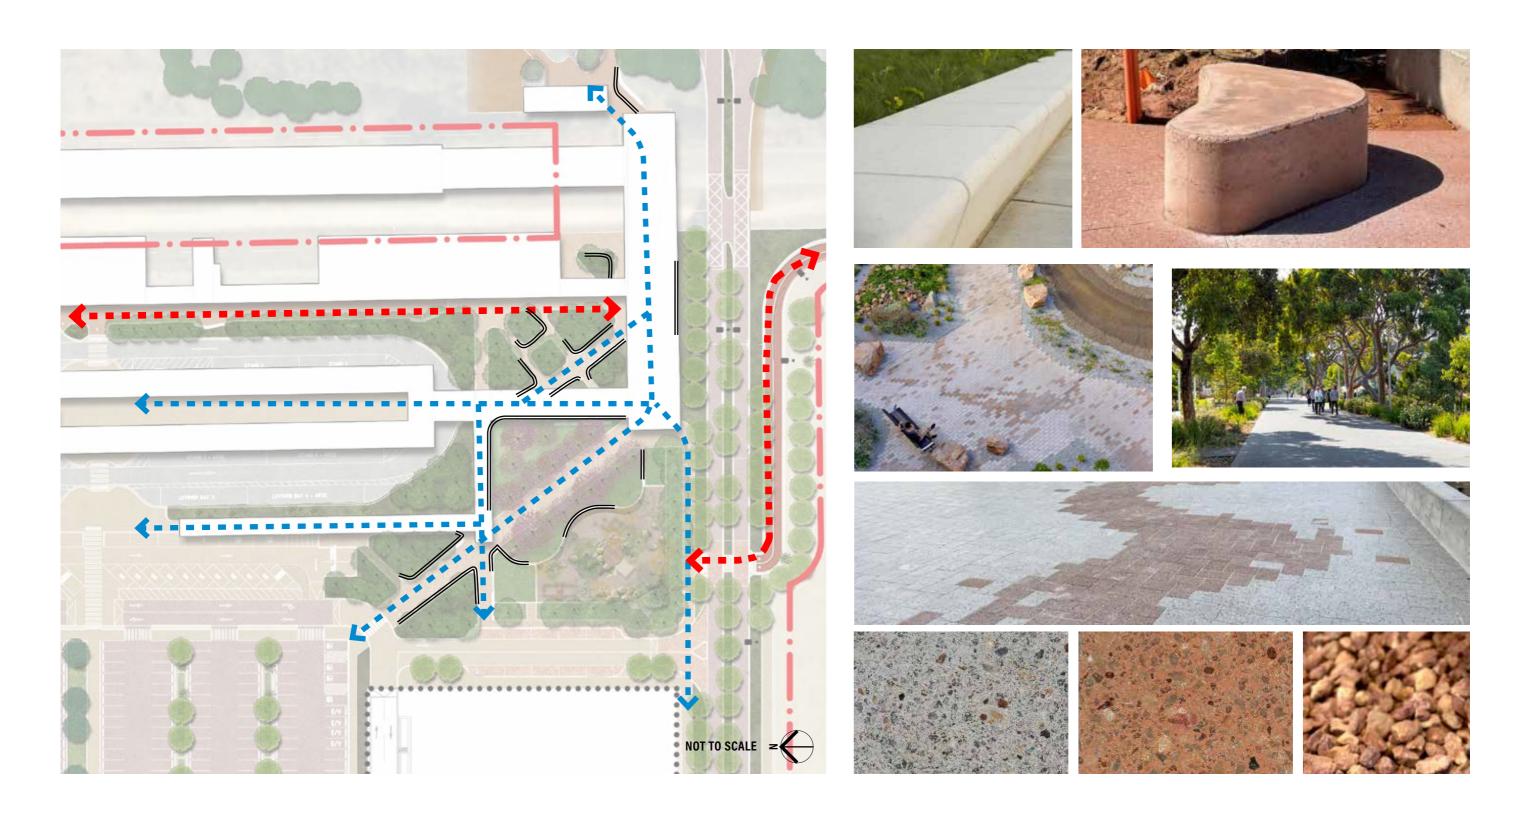

PLANTING

Extensive tree planting will provide a +30% tree canopy for the precinct.

~ 200 mature transplanted Balga providing visual impact from day one.

SUITABILITY FOR SPACE & FUNCTION ESPECIALLY SIGHT-LINES & SAFETY



2 LONG LASTING & LOW MAINTENANCE




3 PREFERENCE FOR NATIVE AND ENDEMIC



AESTHETICS AND SENSE OF PLACE



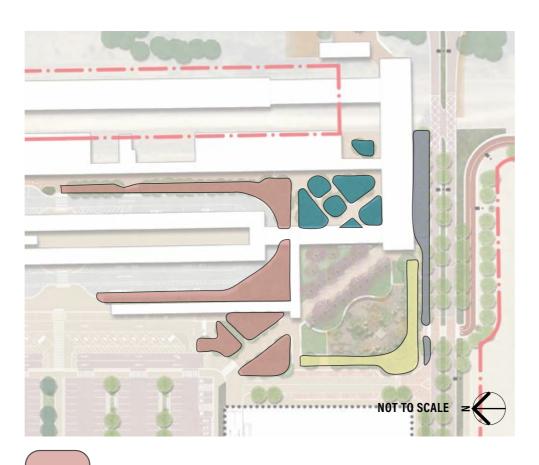





























MATERIAL SELECTIONS


Materials that builds on byfords landscape character and reinforces wayfinding and sense of place.



TREE SELECTION PRINCIPLES

The following principles for street tree selection and placement within the Precinct


Prioritise clear trunked tree species to offer clear sightlines. Ensure trees are located at a suitable distance from crossovers and street intersections.

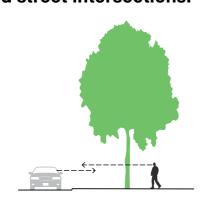

Planting a diversity of tree families, genus, and species will provide visual and seasonal interest, and resilience from pest and disease.



Select tree species to ensure selections are in scale and harmony with the existing streetscape and its functions, intersections.

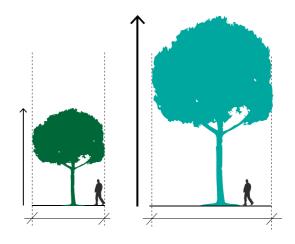


LARGE CANOPIED TREES
Preferencing taller, broad canopied tree species to maximise shade and cooling benefits.



CLOSE SPACING

Planting trees with a close spacing to provide a quick increase in canopy cover and a continuous and connected canopy cover.

Trees planted closely will develop more upright forms, and be less susceptible to wind damage and heat stress.

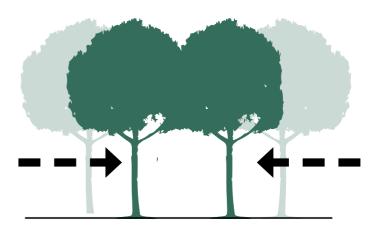




BYFORD RAIL EXTENSION

BYFORD STATION PRECINCT LANDSCAPE WORKS

METCONNX DRAWING No.	PTA DRAWING No.	DRAWING TITLE LINE 1	DRAWING TITLE LINE 2	DRAWING TITLE LINE 3	REVISIO
R30-UDL-DWG-LA-330-00001	11-A-109-LA0011	BYFORD STATION PRECINCT	LANDSCAPE	COVER SHEET	B.01
R30-UDL-DWG-LA-330-00002	11-A-109-LA0012	BYFORD STATION PRECINCT	LANDSCAPE	LEGEND & NOTES	B.01
R30-UDL-DWG-LA-330-00010	11-A-109-LA0014	BYFORD STATION PRECINCT	LANDSCAPE	SCHEDULES SHEET 01	B.01
30-UDL-DWG-LA-330-00011	11-A-109-LA0015	BYFORD STATION PRECINCT	LANDSCAPE	SCHEDULES SHEET 02	A.01
30-UDL-DWG-LA-330-00021	11-A-109-LA0017	BYFORD STATION PRECINCT	LANDSCAPE	SHEET LAYOUT PLAN	B.01
30-UDL-DWG-LA-330-00100	11-A-109-LA0018	BYFORD STATION PRECINCT	LANDSCAPE	TREE RETENTION PLAN - SHEET 01	B.01
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B.01 10.07.23 ISSUE FOR IDD-IDC

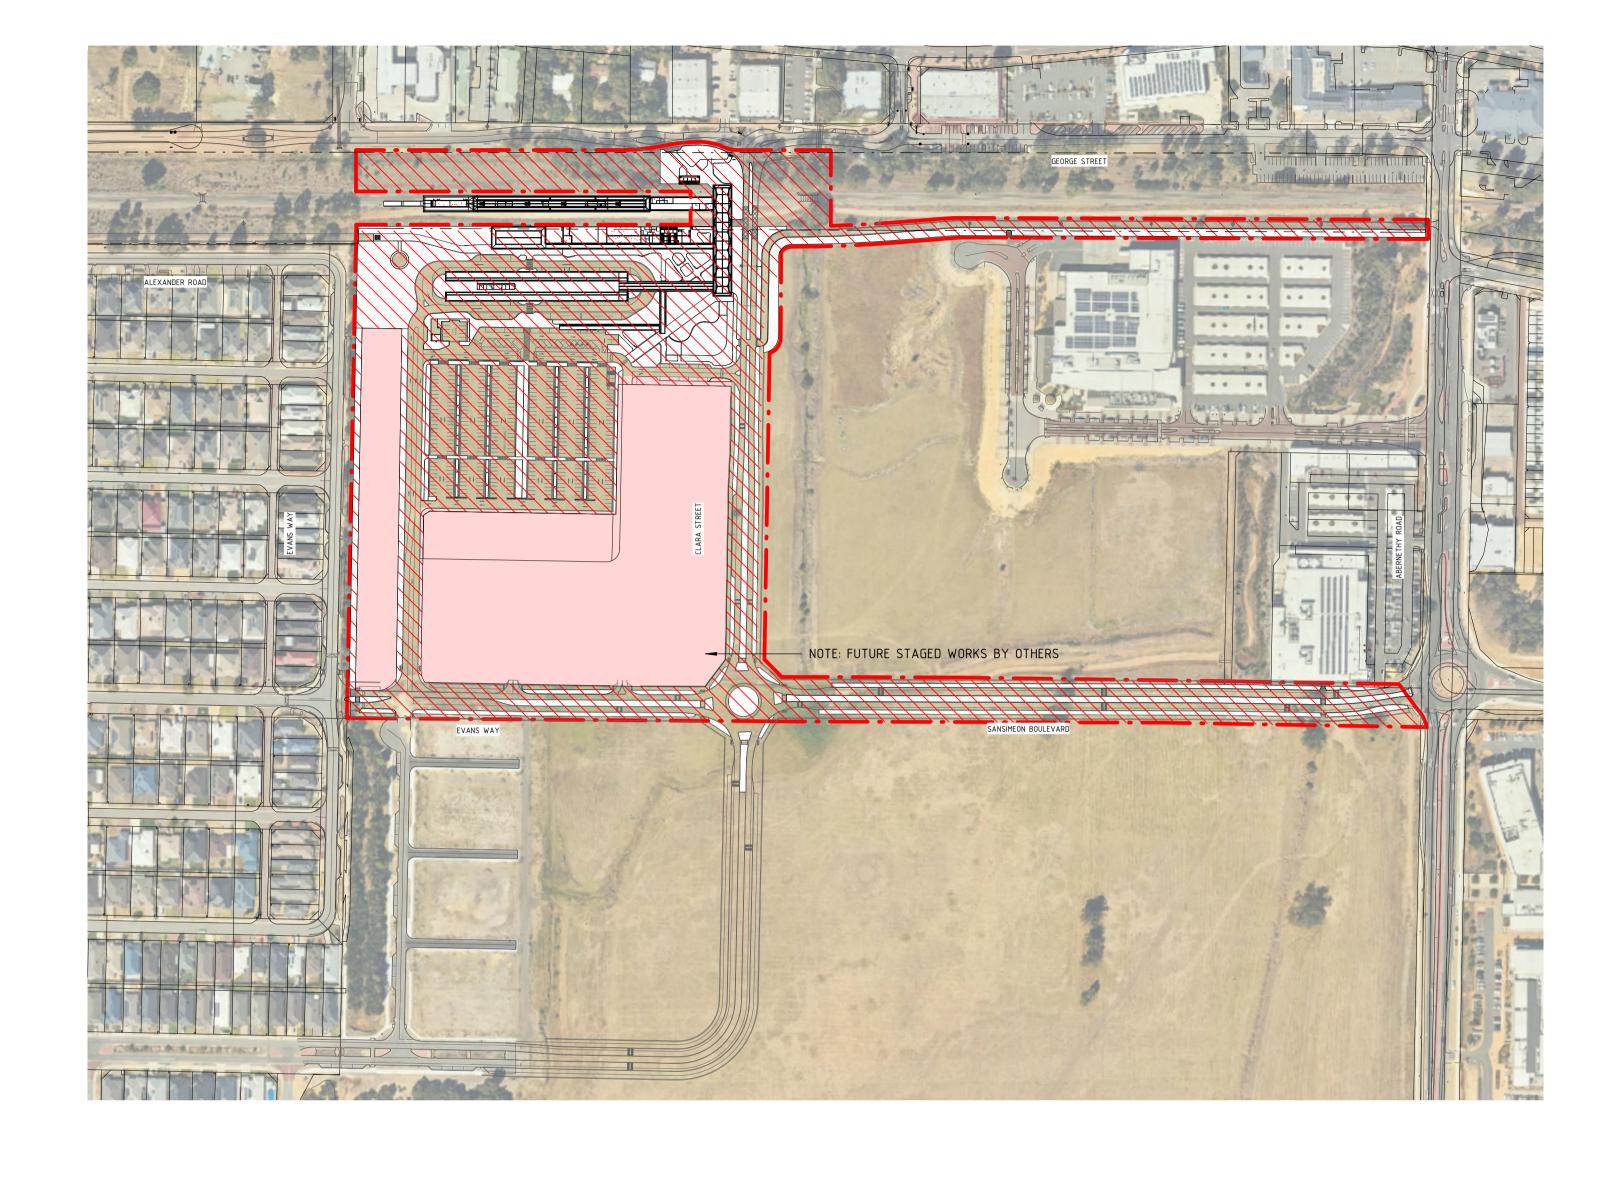A 12.10.22 ISSUE FOR RD

CH YD MH JD

A 12.10.22 ISSUE FOR RD

CH YD MH AE

REV DATE

ORIG SIZE

O 10 20 30 40 50

AT ORIGINAL PLOT SIZE

AT ORIGINAL PLOT SIZE

O a third party nor be used for any unauthorised purpose.

Contractor No: R30-UDL-DWG-LA-330-00001 Rev: B.01



REFERENCES	SCALE		DESIGNED	C.Holdsworth	Γ
R30-MET-XRF-CI-300-00001	1 : 2500			C.HOLUSWOITH	
R30-MET-XRF-CI-300-00002 R30-MET-XRF-CI-300-00003			DRAWN	Y.Demissie	
XR01CI_CLARA_GEORGE_DESIGN_PCG2020			CHECKED	M.Harris	
	DATUM		4 D D D O V E D	т.папті	
	HORIZONTAL:	PCG2020	APPROVED	J.Davis	
	VERTICAL:	AHD71			

DETAILED DESIGN

Government of Western Australia
BYFORD RAIL EXTENSION

BYFORD STATION PRECINCT
LANDSCAPE
COVER SHEET

PTA Drawing No: 11-A-109-LA0011


Rev: B.01


NOT FOR CONSTRUCTION

PRINT IN COLOUR


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LEGEND




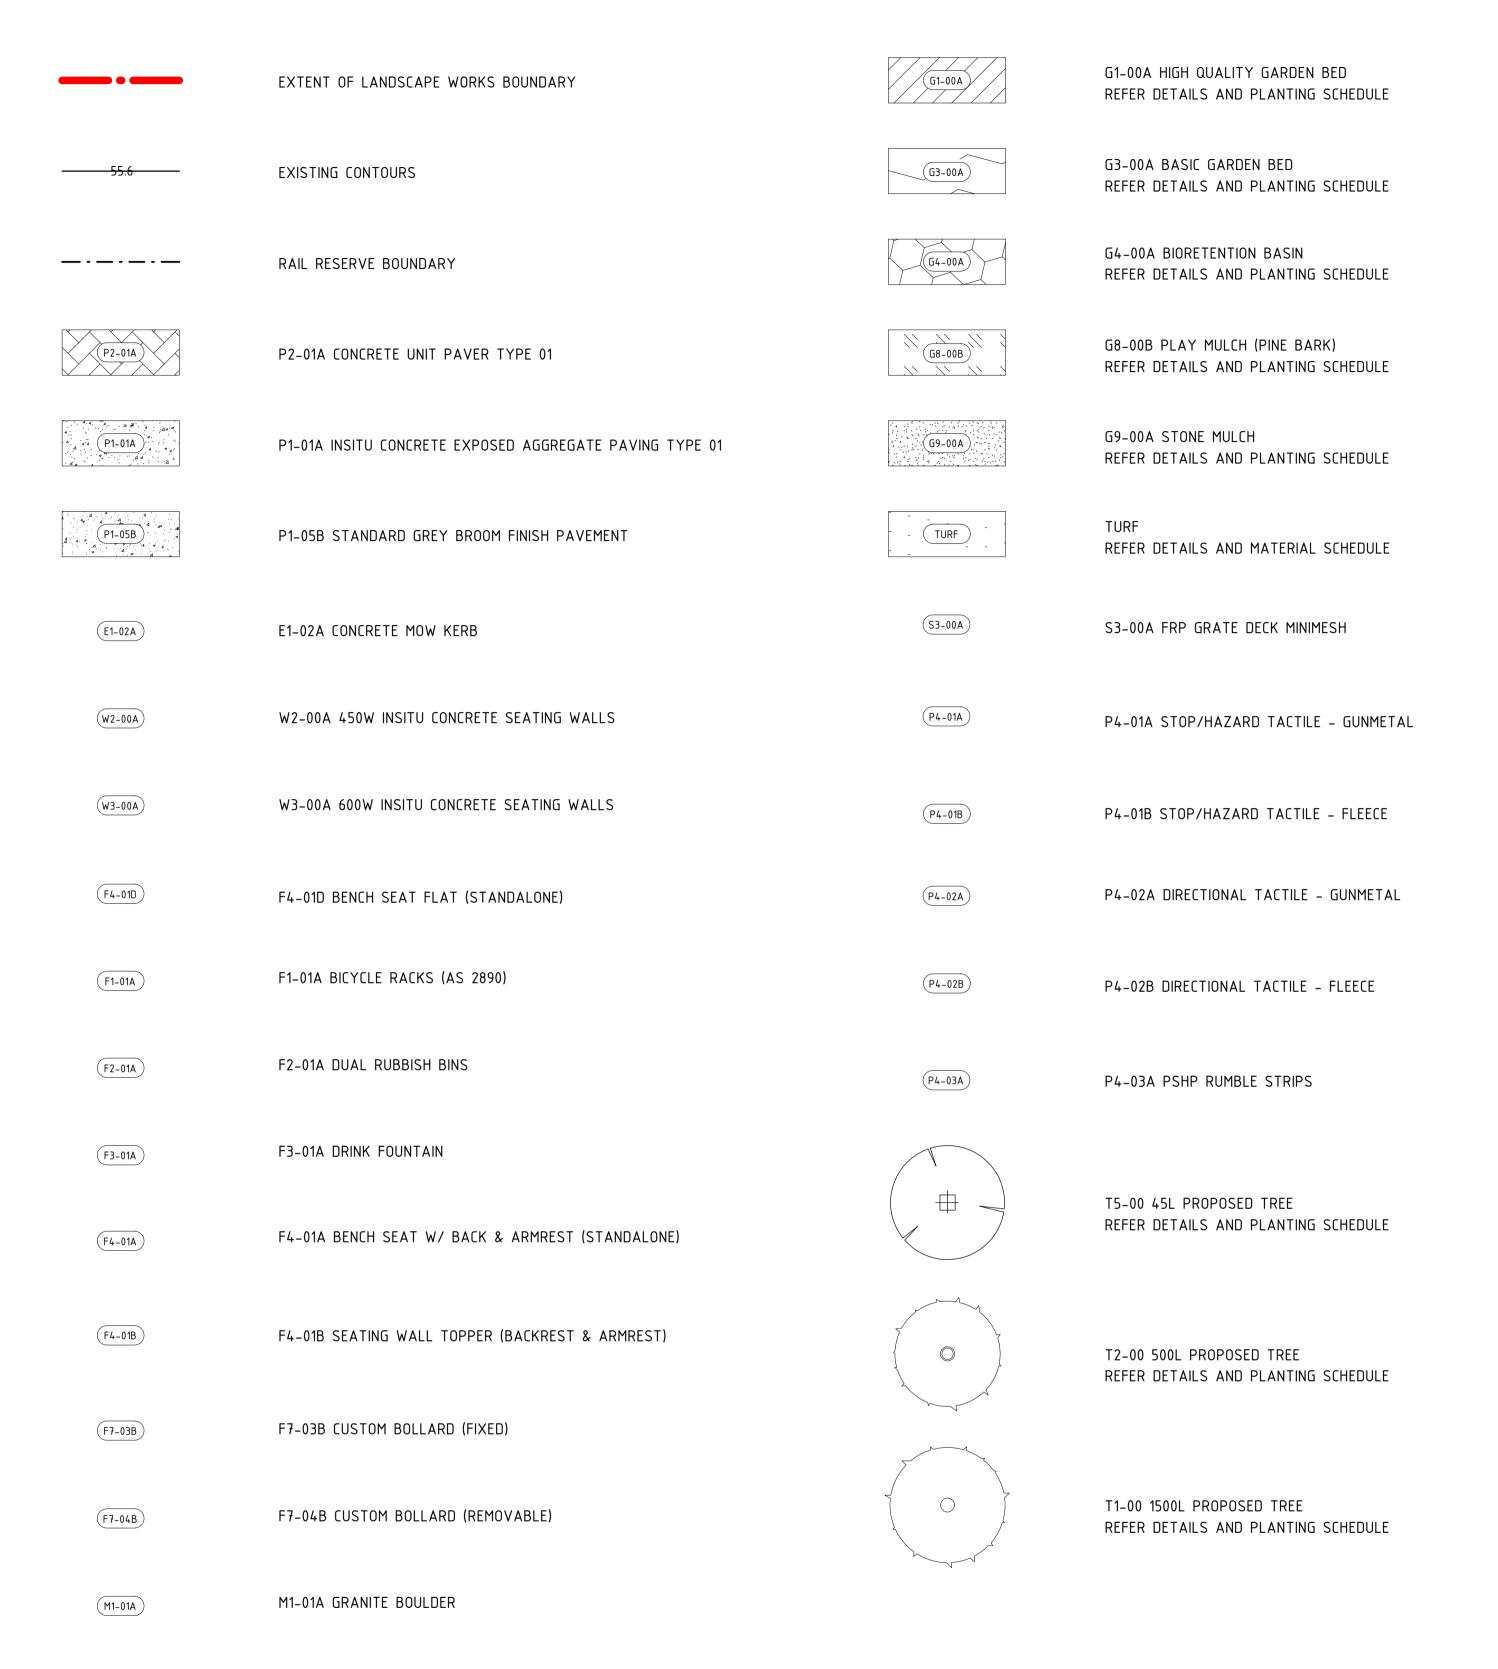

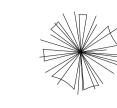T7-01 GRASS TREE TRANSPLANT

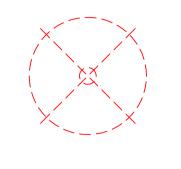

EXISTING TREE TO BE REMOVED.

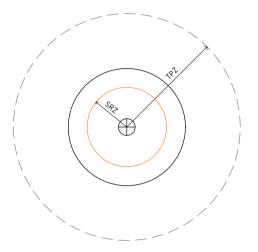

REFERENCES

EXISTING TREE TO BE RETAINED AND PROTECTED WITH STRUCTURAL ROOT ZONE (SRZ) & TREE PROTECTION ZONE (TPZ) TO AS. 4970

CH YD MH JD
CH YD MH AE
DSN DRN CHK APP
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to a third party nor be used for any unauthorised purpose. | Contractor No: R30-UDL-DWG-LA-330-00002 | Rev. B.01



SCALE		DESIGNED	C.Holdsworth	ſ
		DRAWN	Y.Demissie	ŀ
DATUM		CHECKED	M.Harris	
HORIZONTAL:	PCG2020	APPROVED	J.Davis	
VERTICAL:	AHD71	DATE	10.07.23	

	DETAILED DESIGN				
1	Government of Western Australia Public Transport Authority	BYFORD RAIL EX	TENSION		
	BYFORD STATION PRECINCT				
	LANDSCAPE				
	LEGEND & NOTES				
	PTA Drawing No: 11-A-109	-LA0012	Rev: B.01		

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CAD DRAWING PATHNAME Autodesk Docs://BRE BYFORD RAIL EXTENSION/R30-UDL-MDL-LA-330-00001.rvt

AT ORIGINAL PLOT SIZE

0 10 20 30 40 50

AMENDMENT

B.01 10.07.23 ISSUE FOR IDD-IDC

A 12.10.22 ISSUE FOR RD

REV DATE

ORIG SIZE

WALL SCHEDULE				
Type Mark	Description	Count		
W2-00A	Seating Wall - 450mm	55		

	FLOOR SCHEDULE					
Type Mark	Description	Агеа	Count			
P1-01A	In-situ / Coloured, Exposed-Aggregate Concrete - Type 1	4517 m ²	1.			
P1-05B	Standard Broom Finish Grey Concrete	1632 m ²	33			
P2-01A	Concrete / Engineered Stone Unit Pavement – Type 1	2713 m ²	6			
P4-03A	Thermoplastic raised marking material – Rumble Strips	3 m ²	1			
Grand total: 44		8866 m²	•			

FURNITURE SCHEDULE					
Type Mark	Description	Count			
F7-04B	Arbour Structure	6			
F4-01A	Bench Seat	1			
F2-01A	Bin Enclosure	6			
F1-01A	Dero Surface Mounted Bike Rack – Hoop as Specified	10			
F3-01A	Drink Fountain with Dog Bowl	2			
F4-01B	Seating Wall Topper – Bench Seat	7			
F7-03B	Stainless Steel Bollards – Fixed	27			

Type Mark	Description	Size	Count
Type Hark	Везеприон	3120	Codin
T1-09	Corymbia calophylla	1500L	4
T1–10	Eucalyptus accedens	1500L	3
T1-22	Eucalyptus leucoxylon	1500L	1
T1-34	Eucalyptus torquata	1500L	7
T1-37	Eucalyptus wandoo	1500L	4
T1-40	Jacaranda mimosifolia	1500L	9
T1-57	Quercus robur	1500L	3
T1-62	Ulmus parvifolia	1500L	7
T1-64	Eucalyptus victrix	1500L	9
T1–65	Eucalyptus lane-poolei	1500L	4
T2-04	Eucalyptus sideroxylon	500L	23
T2-09	Corymbia calophylla	500L	26
T2-19	Corymbia maculata	500L	6
T2-22	Eucalyptus leucoxylon	500L	24
T2-29	Eucalyptus rudis	500L	29
T2-34	Eucalyptus torquata	500L	15
T2-37	Eucalyptus wandoo	500L	15
T2-44	Melaleuca leucadendra	500L	4
T2-46	Melaleuca quinquinervia	500L	5
T2-49	Agonis flexuosa	500L	3
T2-50	Melaleuca viridiflora	500L	1
T2-64	Eucalyptus victrix	500L	7
T5-04	Eucalyptus sideroxylon	45L	46
T5-10	Eucalyptus accedens	45L	5
T5-14	Eucalyptus erythrocorys	45L	19
T5–17	Eucalyptus gomphocephala	45L	7
T5–19	Corymbia maculata	45L	19
T5-22	Eucalyptus leucoxylon	45L	40
T5-25	Eucalyptus marginata	45L	8
T5-29	Eucalyptus rudis	45L	24
T5-34	Eucalyptus torquata	45L	3
T5-37	Eucalyptus wandoo	45L	18
T5-44	Melaleuca leucadendra	45L	13
T5-46	Melaleuca quinquinervia	45L	39
T5-47	Melaleuca rhaphiophylla	45L	23
T5-50	Melaleuca viridiflora	45L	13
T7-01	Xanthorrhoea preissii		200

G1-00A	High Quality Irrigated Amenity Planting
G1-00B	High Quality Irrigated Amenity Planting
G1-00C	High Quality Irrigated Amenity Planting
G1-00D	High Quality Irrigated Amenity Planting
G1-00E	High Quality Irrigated Amenity Planting
G3-00A	Basic Non-Irrigated Amenity Planting
G4-00A	Non-Irrigated Swales and Basin
G4-00B	Non-Irrigated Swales and Basin
G4-00C	Non-Irrigated Swales and Basin
G4-00D	Non-Irrigated Swales and Basin
G4-00E	Non-Irrigated Swales and Basin
G8-00B	Play Mulch
G9-00A	Stone Mulch

PLANT SCHEDULE (G1-00A)					
		_	AREA	RATE (per m2)	
WELCOME	PLACE	Irrigated (Permanent)	1299sqm	4	
Code	Botanical Name	Common Name	Size	Total	
AAP	Acacia applanata	Golden Grass Wattle	140mm	472	
BAE	Beaufortia aestiva	Summer Flame	140mm	472	
BER	Bossiaea eriocarpa	Common Brown Pea	140mm	472	
CAC	Conostylis aculeata	Prickly conostylis	140mm	472	
CCA	Conostylis candicans	Cottonheads	140mm	472	
DRE	Dianella revoluta	Blue Flax Lily	140mm	472	
EGL	Eremophila glabra	Emu Bush	140mm	472	
GCR	Grivellea crithmifolia (prostrate)	Little Crith	140mm	472	
HPU	Hemiandra pungens	Snake Plant	140mm	472	
LLI	Lomandra little con	Mat Rush	140mm	472	
POC	Patersonia occidentalis	Purple Flag	140mm	472	
	•	•	<u> </u>	5196	

PLANT MIX SCHEDULE

Area Count

365 m² 399 m² 4498 m² 4841 m² 1870 m² 5073 m² 2581 m² 2654 m² 575 m² 1057 m² 25717 m²

PLANT SCHEDULE (G1-00B)					
		AREA	RATE (per m2)		
PLAZA 1		Irrigated (Permanent)	266sqm	4	
Code	Botanical Name	Common Name	Size	Total	
AAP	Acacia applanata	Golden Grass Wattle	140mm	89	
AHU	Anigozanthos humilis	Catspaw	140mm	89	
AGR	Aotus gracillima		140mm	89	
BSQ	Beaufortia squarrosa	Sand Bottlebrush	140mm	89	
BER	Bossiaea eriocarpa	Common Brown Pea	140mm	89	
BOR	Bossiaea ornata	Broad Leaved Brown Pea	140mm	89	
ССО	Chorizema cordatum	Heat Leafed Flamed Leaf	140mm	89	
GOB	Grevillea obtusifolia	Leaved Grevillea	140mm	89	
HSC	Hibbertia scandens	Snake Vine	140mm	89	
KPR	Kennedia prostrata	Running Postman	140mm	89	
LF0	Lechenaultia formosa	Red Lechenaultia	140mm	89	
LLO	Lechenaultia lola		140mm	89	

PLANT SCHEDULE (G1-00C)						
		AREA	RATE (per m2)			
PLAZA 2		Irrigated (Permanent)	251sqm	4		
Code	Botanical Name	Common Name	Size	Total		
ASC	Agrostocrinum scabrum	Blue Grass Lily	140mm	143		
AVI	Anigozanthos viridis	Green Kangaroo Paw	140mm	143		
BIBERIDI	Brachyscome iberidifolia	Swan River Daisy	140mm	143		
ВСО	Burchardia congesta	Milkmaids	140mm	143		
DTE	Dampiera teres	Terete-leaved Dampiera	140mm	143		
DRE	Dianella revoluta	Blue Flax Lily	140mm	143		
HPU	Hemiandra pungens	Snake Plant	140mm	143		
LBI	Lechenaultia biloba	Blue Lechenaultia	140mm	143		
LAN	Lobelia anceps	Angled Lobelia	140mm	143		
LLI	Lomandra little con	Mat Rush	140mm	143		
OLA	Orthrosanthus laxus	Morning Iris	140mm	143		
DLI	Dampiera linearis	Common Damperia	140mm	143		

PLANT SCHEDULE (G1-00D)						
			AREA	RATE (per m2)		
PLAY SP	ACE	Irrigated (Permanent)	365sqm	4		
Code	Botanical Name	Common Name	Size	Total		
AAP	Acacia applanata	Golden Grass Wattle	140mm	81		
BNI	Banksia nivea	Honeypot Dryandra	140mm	81		
CHI	Calothamnus hirsutus	Low Woolly Bush	140mm	81		
DLI	Dampieria linearis	Western Blue	140mm	81		
DRE	Dianella revoluta	Blue Flax Lily	140mm	81		
GOB	Grevollea obtusifolia	Leaved Grivella	140mm	81		
HSC	Hibbertia scandens	Snake Vine	140mm	81		
TMU	Thysanotus multiflorus	Fringe Lily	140mm	81		
DCI	Darwinia Citrodora	Lemon Scented Darwinia	140mm	81		
MIN	Melelueca incana	Grey Honey Myrtle	140mm	81		
CVI	Carpobrotus virescens	Coastal Pigface	140mm	81		
MPA	Myoporum parvifolium	Boobialla	140mm	81		

PLANT SCHEDULE (G1-00E)						
			AREA	RATE (per m2)		
SHADE		Irrigated (Permanent)	399sqm	3		
Code	Botanical Name	Common Name	Size	Total		
ALA	Acacia lasiocarpa, (prostrate)	Panjang	50mm Tube	200		
CCO	Chorizema cordata	Heart Leafed Flamed Leaf	50mm Tube	200		
GOB	Grevillea obtusifolia (prostrate)	Leaved Grevillea	140mm	200		
HSC	Hibbertia scandens	Guinea Flower	140mm	200		
MIN	Melaleuca incana	Grey honeymyrtle	50mm Tube	200		
LLI	Lomandra little con	Mat Rush	140mm	200		
BRE	Banksia repens	Creeping Banksia	140mm	200		

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REFERENCES	SCALE		DESIGNED	C.Holdsworth
			DRAWN	Y.Demissie
	DATUM		CHECKED	M.Harris
	HORIZONTAL:		APPROVED	J.Davis
	VERTICAL:	AHD71	DATE	10.07.23

Government of Western Australia
Public Transport Authority BYFORD RAIL EXTENSION BYFORD STATION PRECINCT LANDSCAPE SCHEDULES SHEET 01 PTA Drawing No: 11-A-109-LA0014 Rev: B.01

PLANT SCHEDULE (G3-00A)							
AREA RATE (per m2)							
SWALE MI	IX	Irrigated (Temporary)	5075sqm	8			
Code	Botanical Name	Common Name	Size	Total			
AEL	Austrostipa elegantissima	Feather Spear Grass	140mm	4060			
BJU	Baumea juncea	Bare Twig Rush	140mm	4060			
BAR	Baumea articulata	Jointed Rush	140mm	4060			
FNO	Ficinia nodosa	Knotted Club Rush	140mm	4060			
LCA	Lepidosperma calcicola	Coastal Sedge	140mm	4060			
MIN	Melaleuca incana	Grey Honeymyrtle	140mm	4060			

24360

19364

PLANT SCHEDULE (G4-00A)						
			AREA	RATE (per m2)		
REVEGETA	TION 1	Non-Irrigated	4841sqm	4		
Code	Botanical Name	Common Name	Size	Total		
APU	Acacia pulchella	Prickly Moses	50mm Tube	1210		
CAC	Conostylis aculeata	Prickly Conostylis	50mm Tube	1210		
EGL	Eremophila glabra	Emu Bush	50mm Tube	1210		
POC	Patersonia occidentalis	Purple Flag	50mm Tube	1210		
GTH	Grevillea thelemanniana (prostrate)	Spider Net Grevillea	50mm Tube	1210		
HPU	Hemiandra pungens	Snake Bush	50mm Tube	1210		
SIN	Scholtzia involucrata	Spiked Scholtzia	50mm Tube	1210		
BER	Bossiaea eriocarpa	Common Brown Pea	50mm Tube	1210		
AGL	Acacia glaucoptera	Flat Wattle	50mm Tube	1210		
HLI	Hakea lissocarpa	Honey Bush	50mm Tube	1210		
BIB	Brachyscome iberidifolia	Swan River Daisy	50mm Tube	1210		
VPL	Verticordia plumosa	Plumed Featherflower	50mm Tube	1210		
GCR	Grevillea crithmifolia (prostrate)	Little Crith	50mm Tube	1210		
CFR	Calytrix fraseri A.Cunn	Pink Summer Caltyrix	50mm Tube	1210		
GCA	Gastrolobium capitatum	Bacon & Eggs	50mm Tube	1210		
GQU	Grevillea quercifolia	Oak leaved Grevillea	50mm Tube	1210		

PLANT SCHEDULE (G4-00B)						
			AREA	RATE (per m2)		
REVEGETATION 2		Non-Irrigated	1870sqm	3		
Code	Botanical Name	Common Name	Size	Total		
APU	Acacia pulchella	Prickly Moses	50mm Tube	701		
CAC	Conostylis aculeata	Prickly Conostylis	50mm Tube	701		
EGL	Eremophila glabra	Emu Bush	50mm Tube	701		
POC	Patersonia occidentalis	Purple Flag	50mm Tube	701		
GTH	Grevillea thelemanniana (prostrate)	Spider Net Grevillea	50mm Tube	701		
HPU	Hemiandra pungens	Snake Bush	50mm Tube	701		
SIN	Scholtzia involucrata	Spiked Scholtzia	50mm Tube	701		
BER	Bossiaea eriocarpa	Common Brown Pea	50mm Tube	701		
AGL	Acacia glaucoptera	Flat Wattle	50mm Tube	701		
HLI	Hakea lissocarpa	Honey Bush	50mm Tube	701		
BIB	Brachyscome iberidifolia	Swan River Daisy	50mm Tube	701		
VPL	Verticordia plumosa	Plumed Featherflower	50mm Tube	701		
GCR	Grevillea crithmifolia (prostrate)	Little Crith	50mm Tube	701		
CFR	Calytrix fraseri A.Cunn	Pink Summer Caltyrix	50mm Tube	701		
GCA	Gastrolobium capitatum	Bacon & Eggs	50mm Tube	701		
GQU	Grevillea quercifolia	Oak leaved Grevillea	50mm Tube	701		

11220

PLANT SCHEDULE (G4-00C)						
			AREA	RATE (per m2)		
VERGES		Non-Irrigated	3866sqm	3		
Code	Botanical Name	Common Name	Size	Total		
ALA	Acacia lasiocarpa (prostrate)	Prostrate Wattle	50mm Tube	1933		
CAC	Conostylis aculeata	Prickly Conostylis	140mm	1933		
DPI	Darwinia pinifolia	Dwarf Dryandra	50mm Tube	1933		
DRE	Dianella revoluta	Little Rev	140mm	1933		
EGL	Eremophila glabra	Emu Bush	140mm	1933		
FNO	Ficinia nodosa	Knotted Club Rush	50mm Tube	1933		
GTH	Grevillea thelemanniana (prostrate)	Spider Net Grevillea	50mm Tube	1933		
GCR	Grevillea crithmifolia (prostrate)	Little Crith	50mm Tube	1933		
HPU	Hemiandra pungens	Snake Bush	50mm Tube	1933		

17397

PLANT SCHEDULE (G4-00D)						
			AREA	RATE (per m2)		
SWALE MI	X	Non-Irrigated	2504sqm	8		
Code	Botanical Name	Common Name	Size	Total		
AEL	Austrostipa elegantissima	Feather Spear Grass	140mm	2862		
BJU	Baumea juncea	Bare Twig Rush	140mm	2862		
BAR	Baumea articulata	Jointed Rush	140mm	2862		
FNO	Ficinia nodosa	Knotted Club Rush	140mm	2862		
LCA	Lepidosperma calcicola	Coastal Sedge	140mm	2862		
MIN	Melaleuca incana	Grey Honeymyrtle	140mm	2862		

PLANT SCHEDULE (G4-00E) RATE (per m2) AREA 2654sqm PSHP EDGES Non-Irrigated Size Total Botanical Name Common Name Grevillea thelemannian (prostrate) Spider Net Grevillea GTH 50mm Tube Emu Bush Eremophila glabra 50mm Tube Swan River Mrytle Hypocalymma robustum 50mm Tube Flax Lily Dianella revoluta 140mm Ficinia nodosa Knotted Club Rush 140mm Little Crith Grevillea crithmifolia (prostrate) 50mm Tube Conostylis aculeata Prickly Conostylis 50mm Tube Conostylis juncea Running Postman 50mm Tube Alyogyne huegelii Native Hibiscus 50mm Tube Snake Bush Hemiandra pungens 140mm Brachyscome iberidifolia Swan River Daisy 50mm Tube Calytrix fraseri A.Cunn Pink Summer Caltyrix 50mm Tube Lemon Scented Darwinia 140mm Darwinia citriodora Fire Bush 50mm Tube Daviesia physodes 50mm Tube 531 Flat Wattle Acacia glaucoptera

BYFORD RAIL EXTENSION

PRINT IN COLOUR


Rev: A.01


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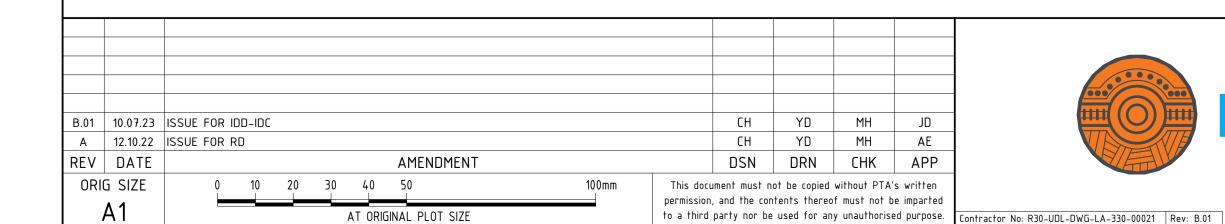


				DETAILED DESIGN
REFERENCES	SCALE	DESIGNED	C.Holdsworth	Government of Western Australia Public Transport Authority BYFORD RAIL
		DRAWN	Y.Demissie	BYFORD STATION PRECINCT
	DATUM	CHECKED	M.Harris	LANDSCAPE
	HORIZONTAL: PCG2020	APPROVED	J.Davis	SCHEDULES SHEET 02
	VERTICAL: AHD71	DATE	10.07.23	PTA Drawing No: 11-A-109-LA0015



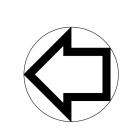

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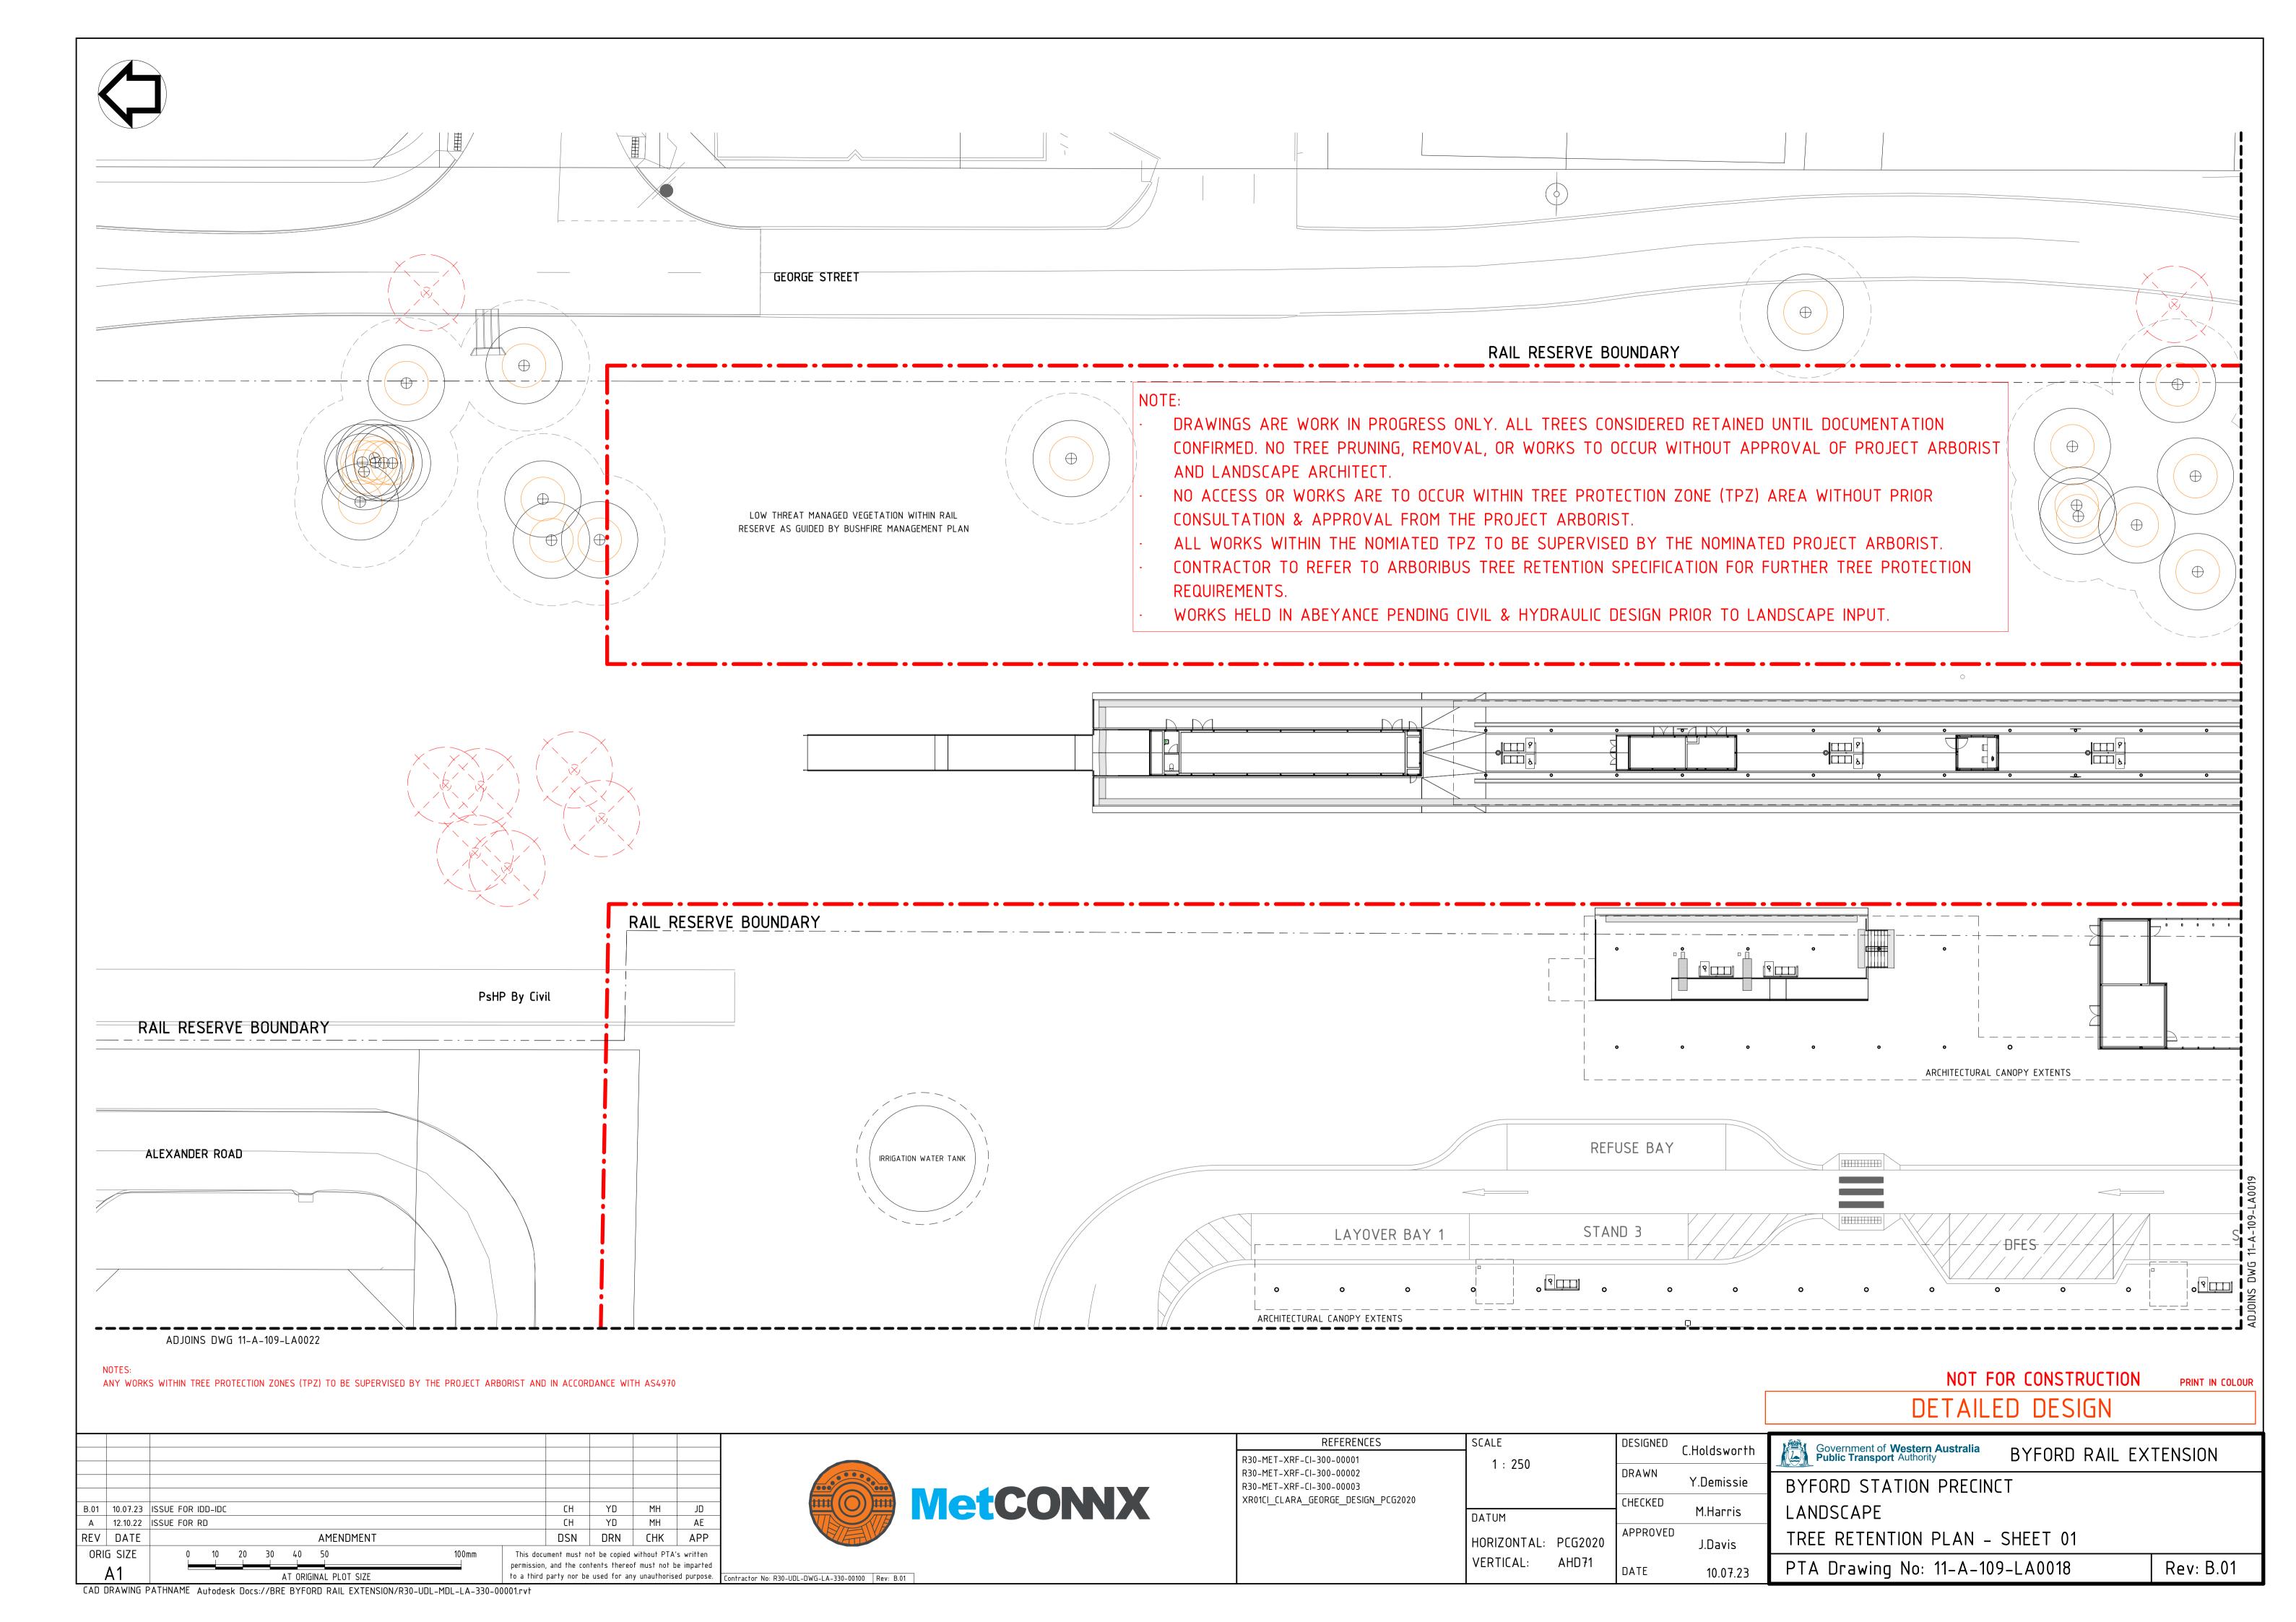


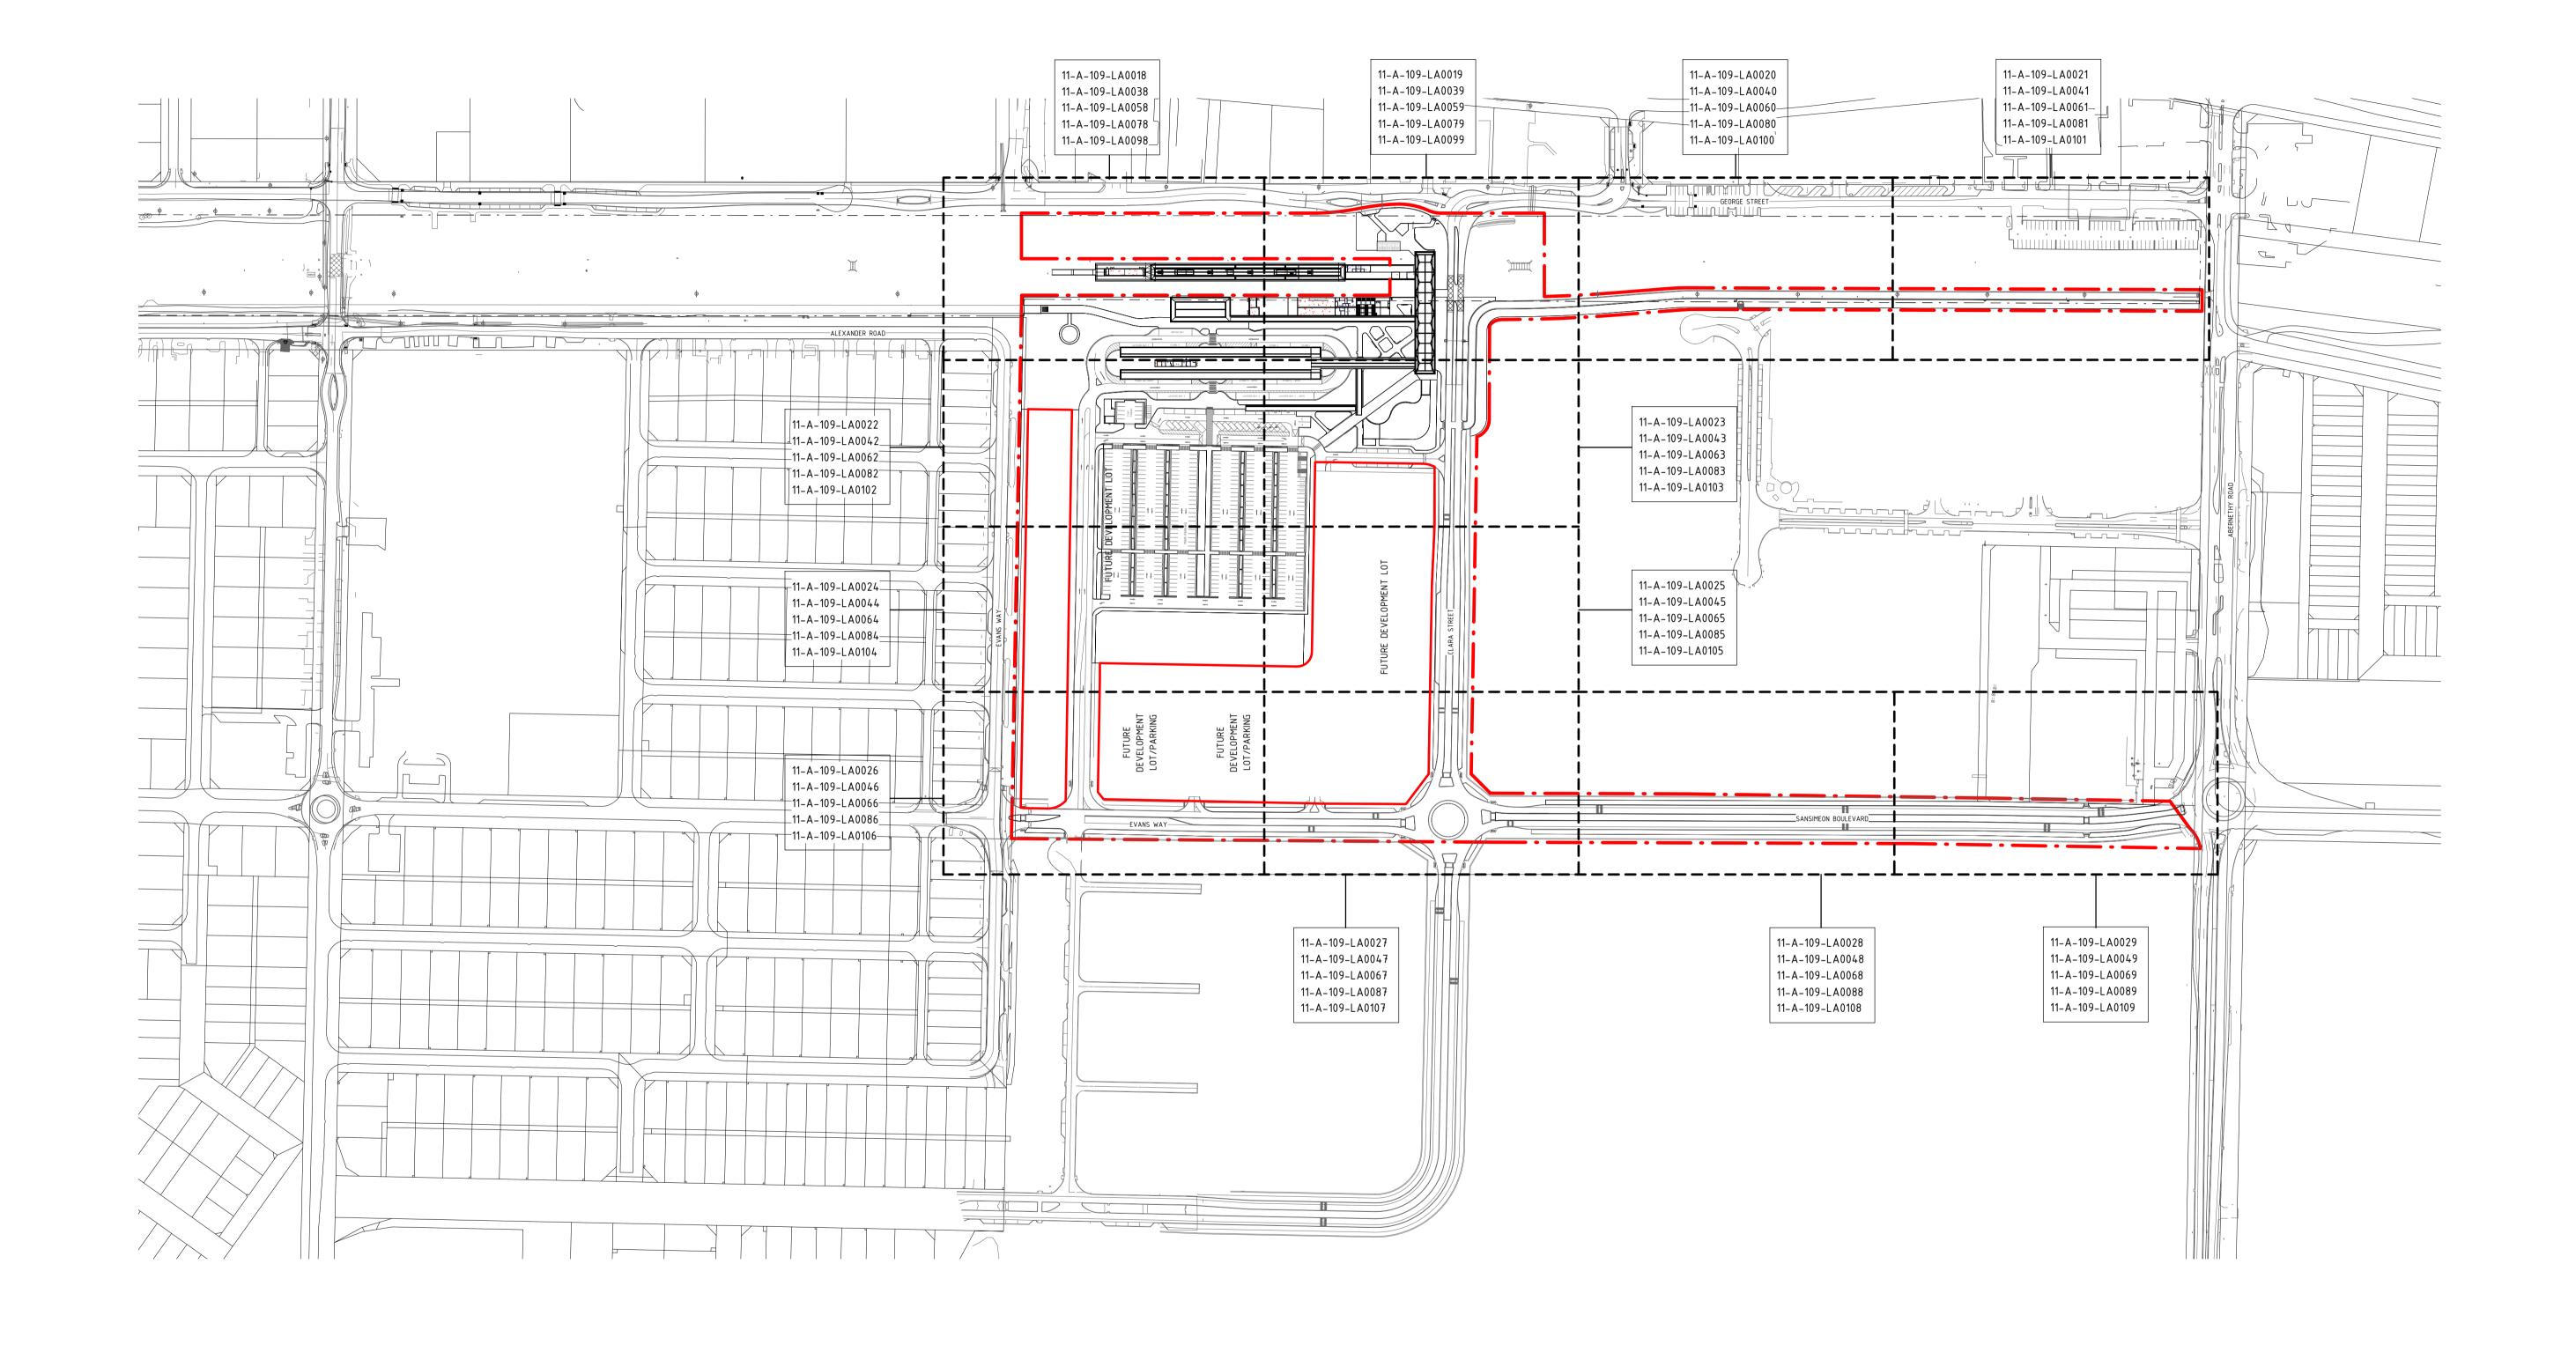
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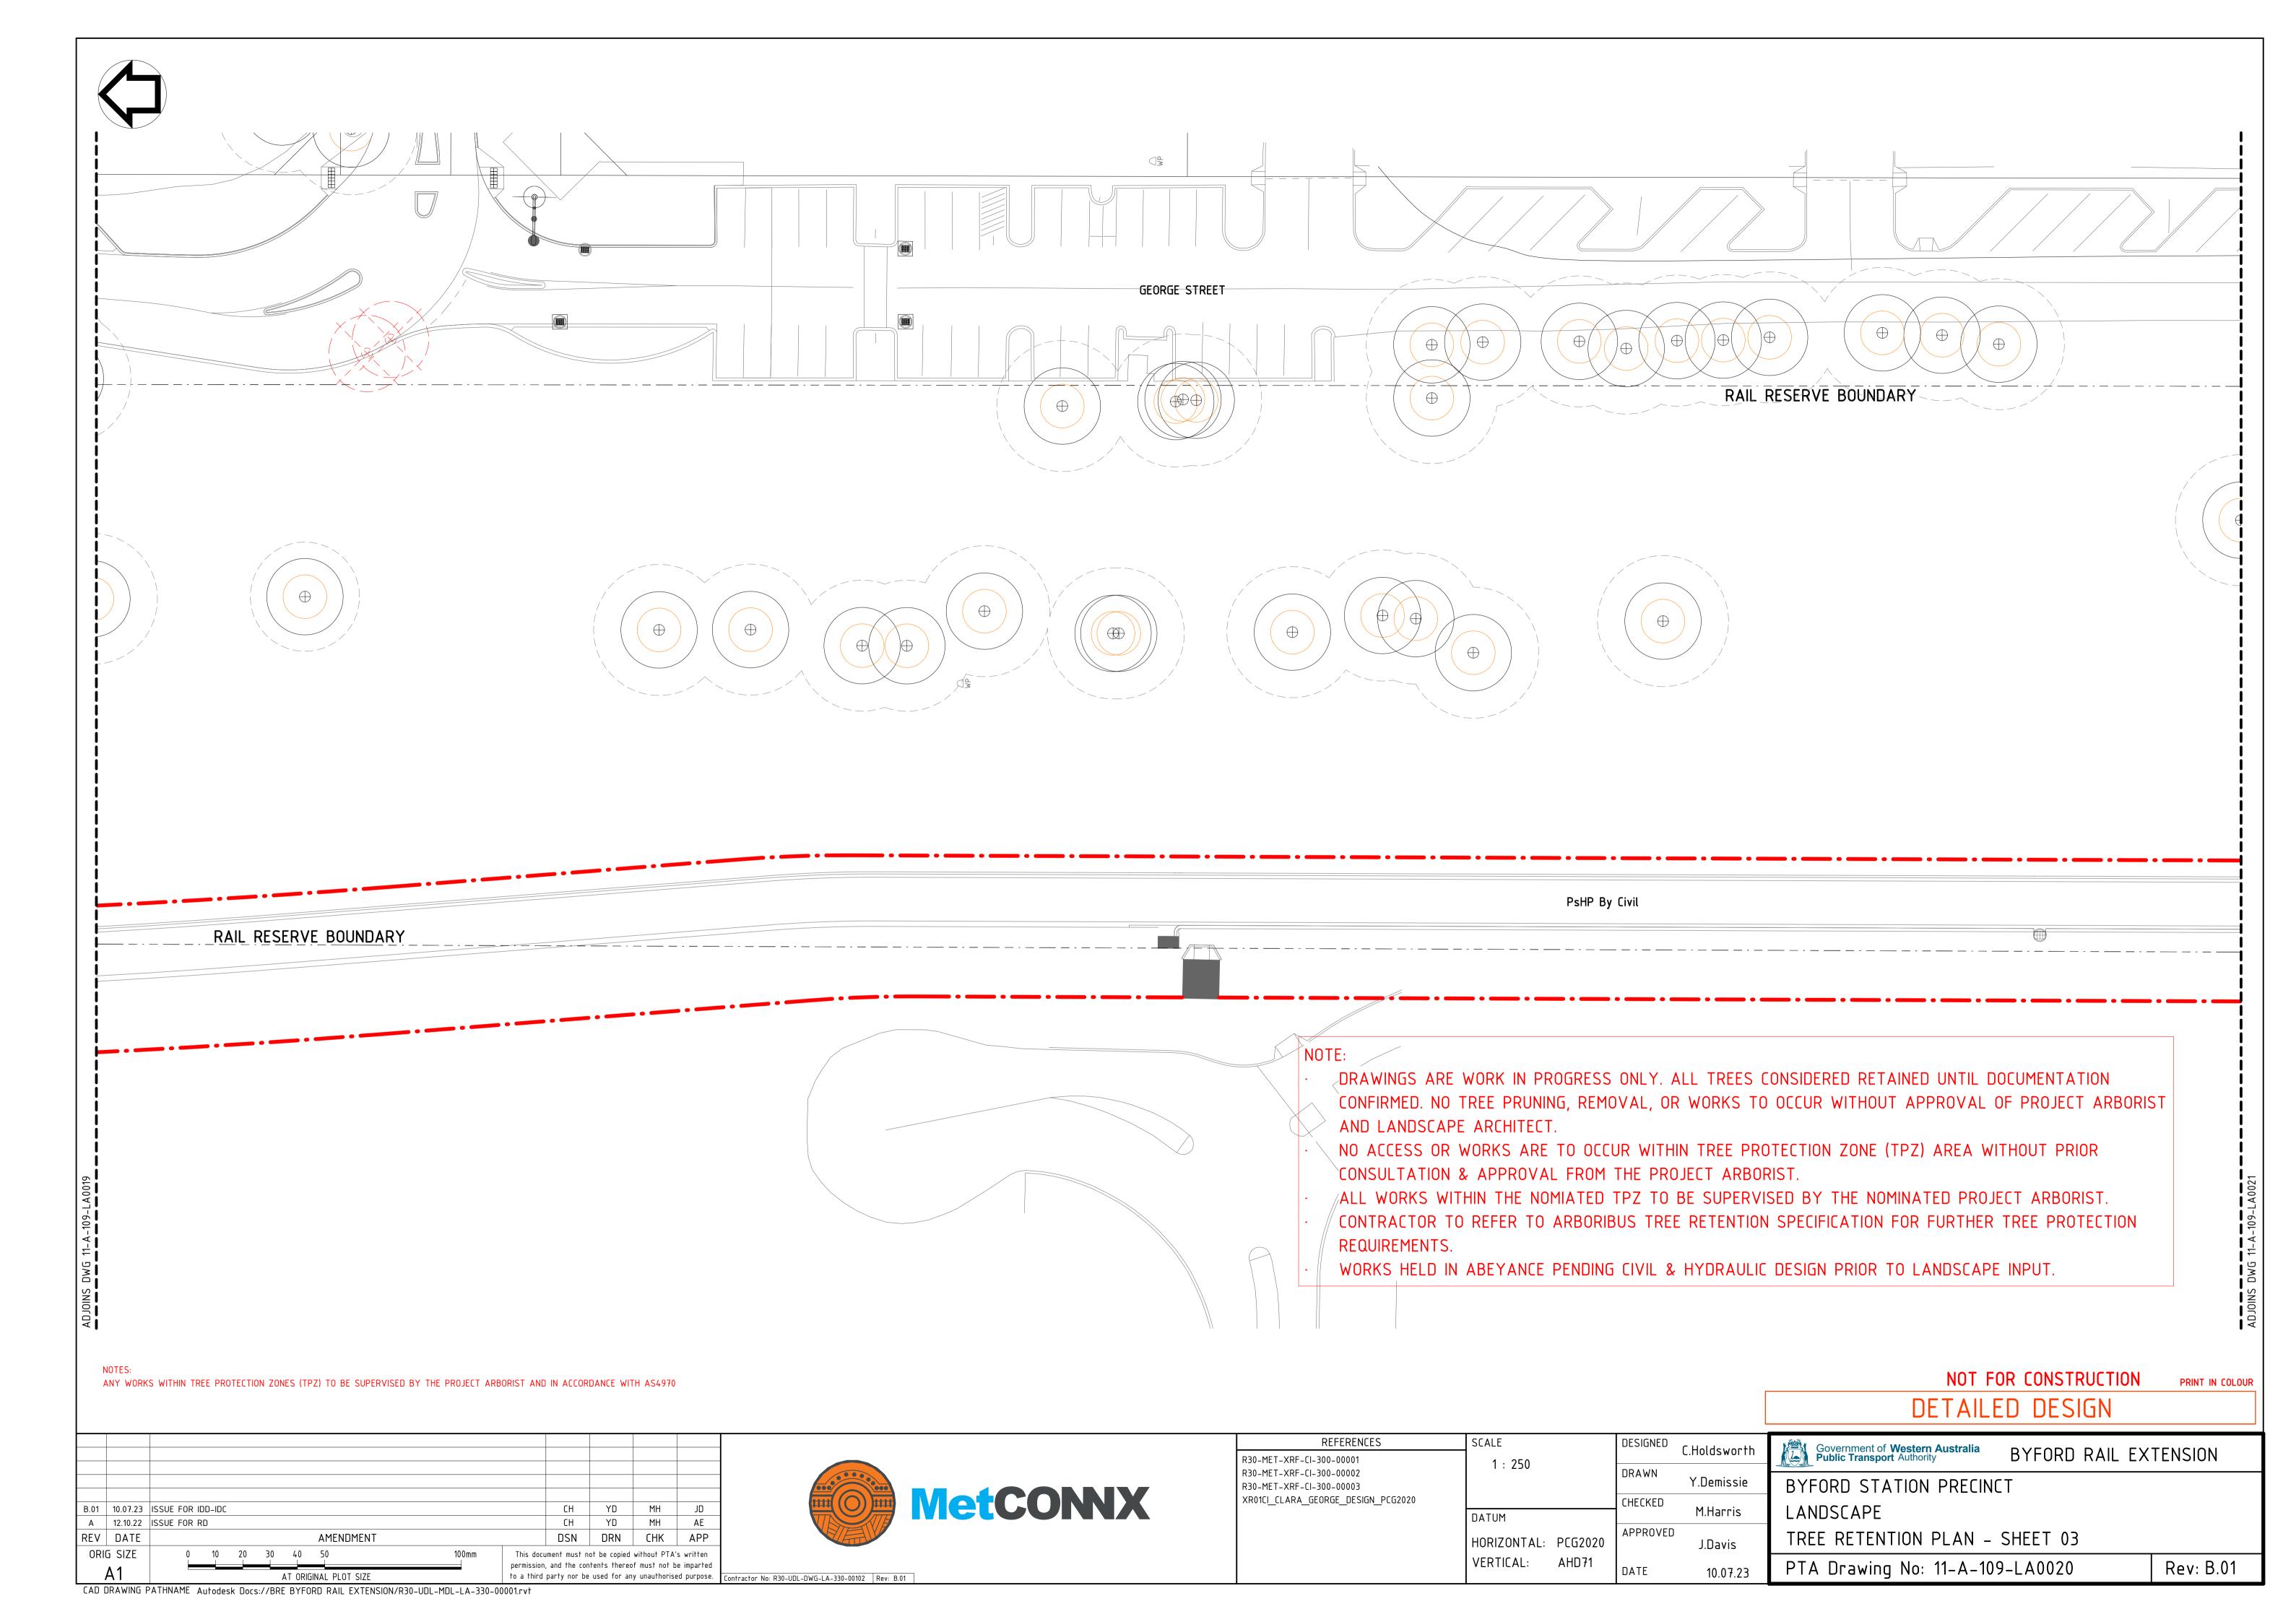



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R30-MET_XRF_CI=300-00001	1: 2000		DDAWN	C.Holdsworth	
R30-MET-XRF-CI-300-00002 R30-MET-XRF-CI-300-00003			DRAWN	Y.Demissie	F
XR01CI_CLARA_GEORGE_DESIGN_PCG2020	DATUM		CHECKED	M.Harris	
		DCC2020	APPROVED		(
	HORIZONTAL: VERTICAL:	AHD71		J.Davis	
	VERTICAL:	AHDTI	DATE	10.07.23	


Government of Western Australia Public Transport Authority	BYFORD RAIL EX	TENSION
BYFORD STATION PRECING	T	
LANDSCAPE		
SHEET LAYOUT PLAN		
PTA Drawing No: 11-A-109	9-LA0017	Rev: B.01







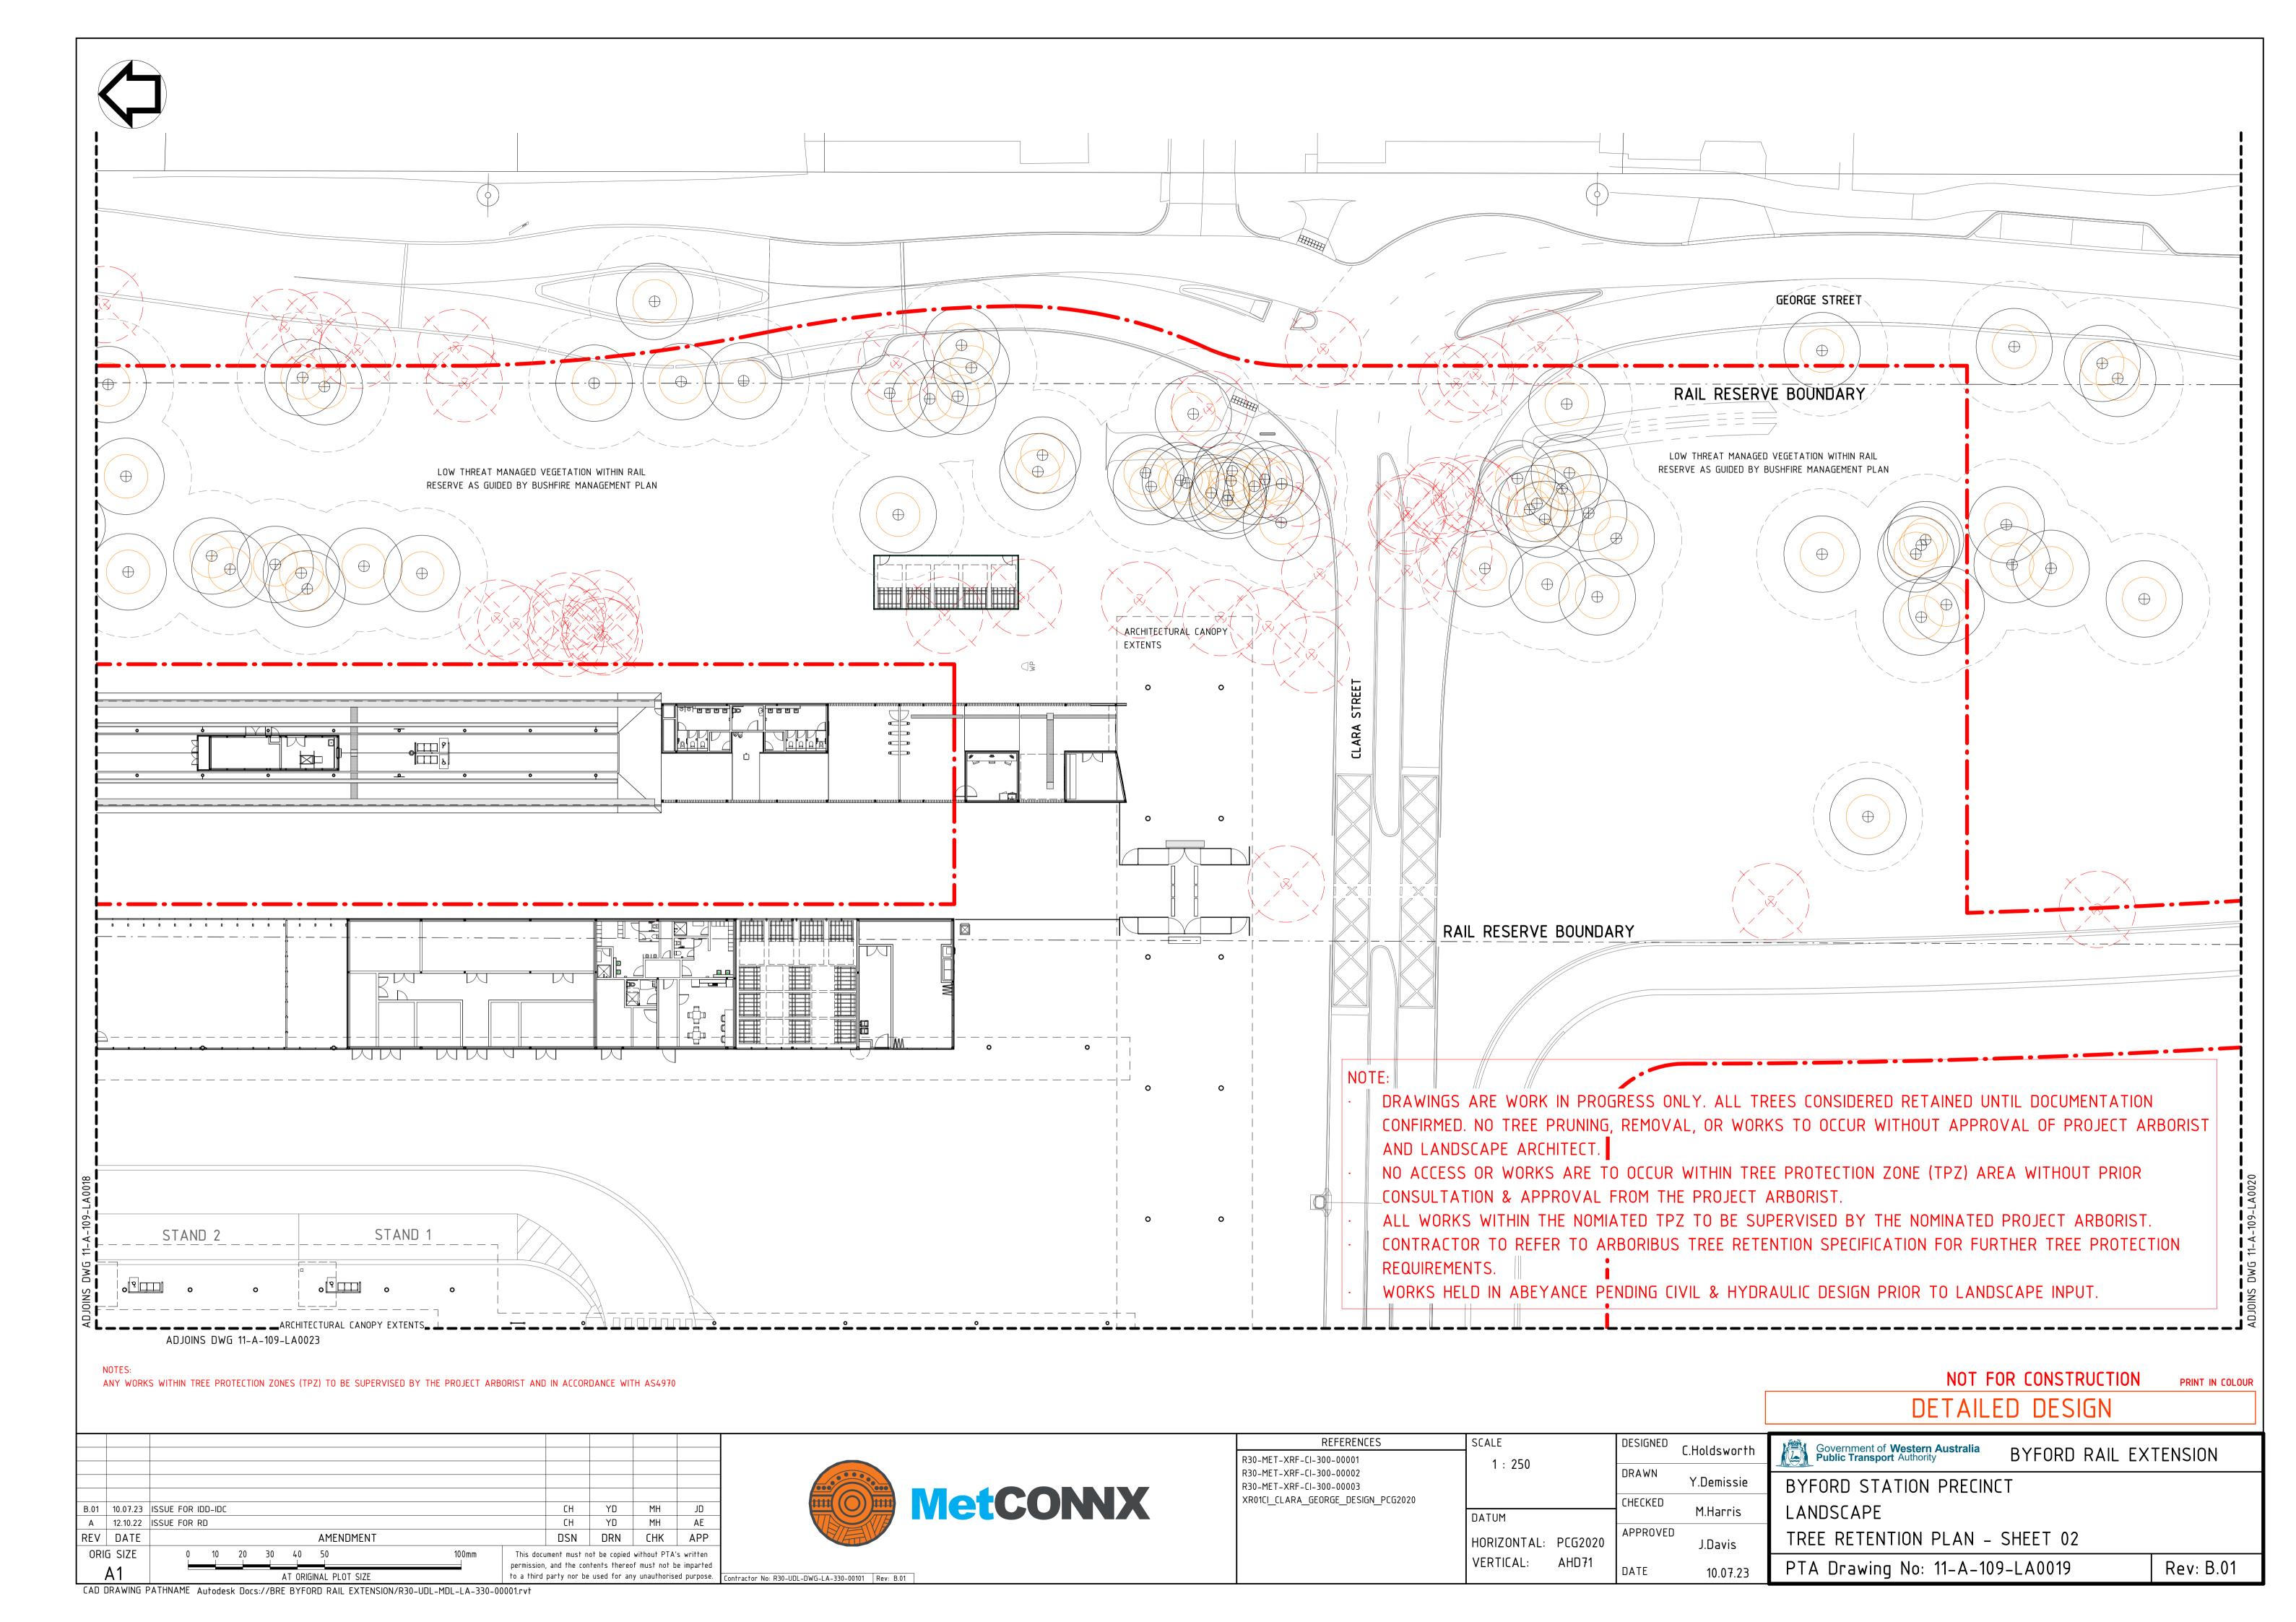


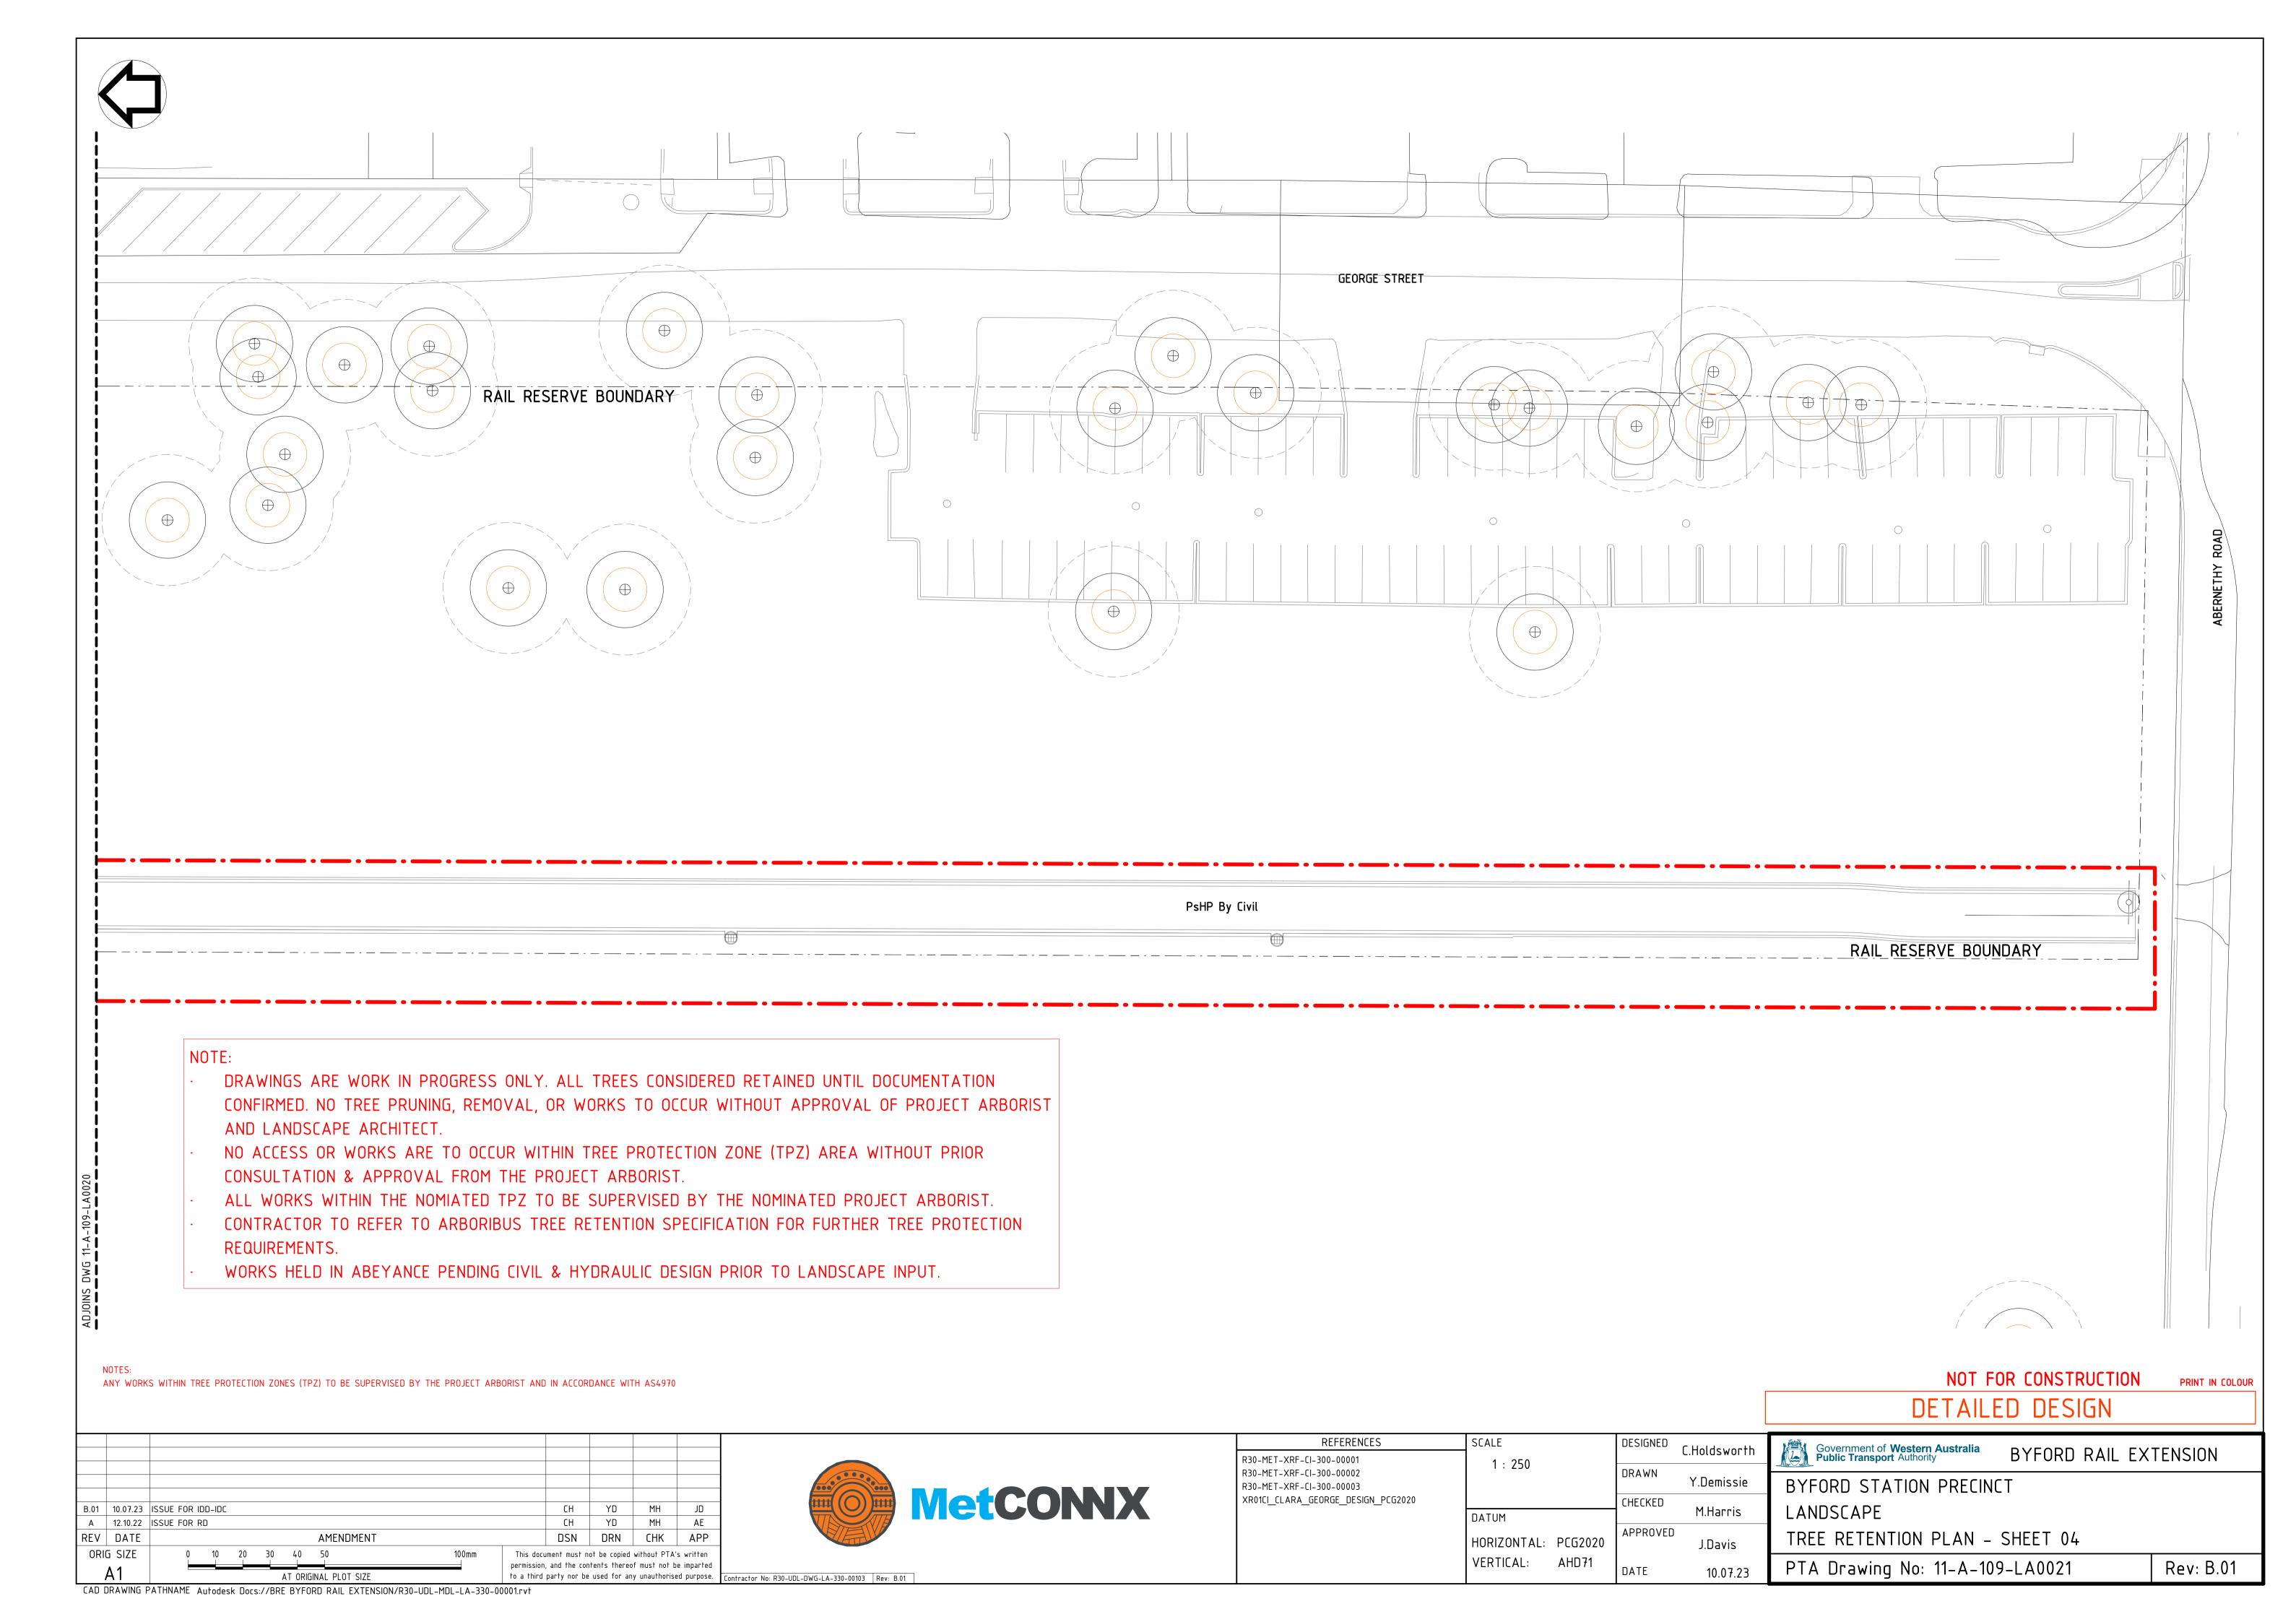


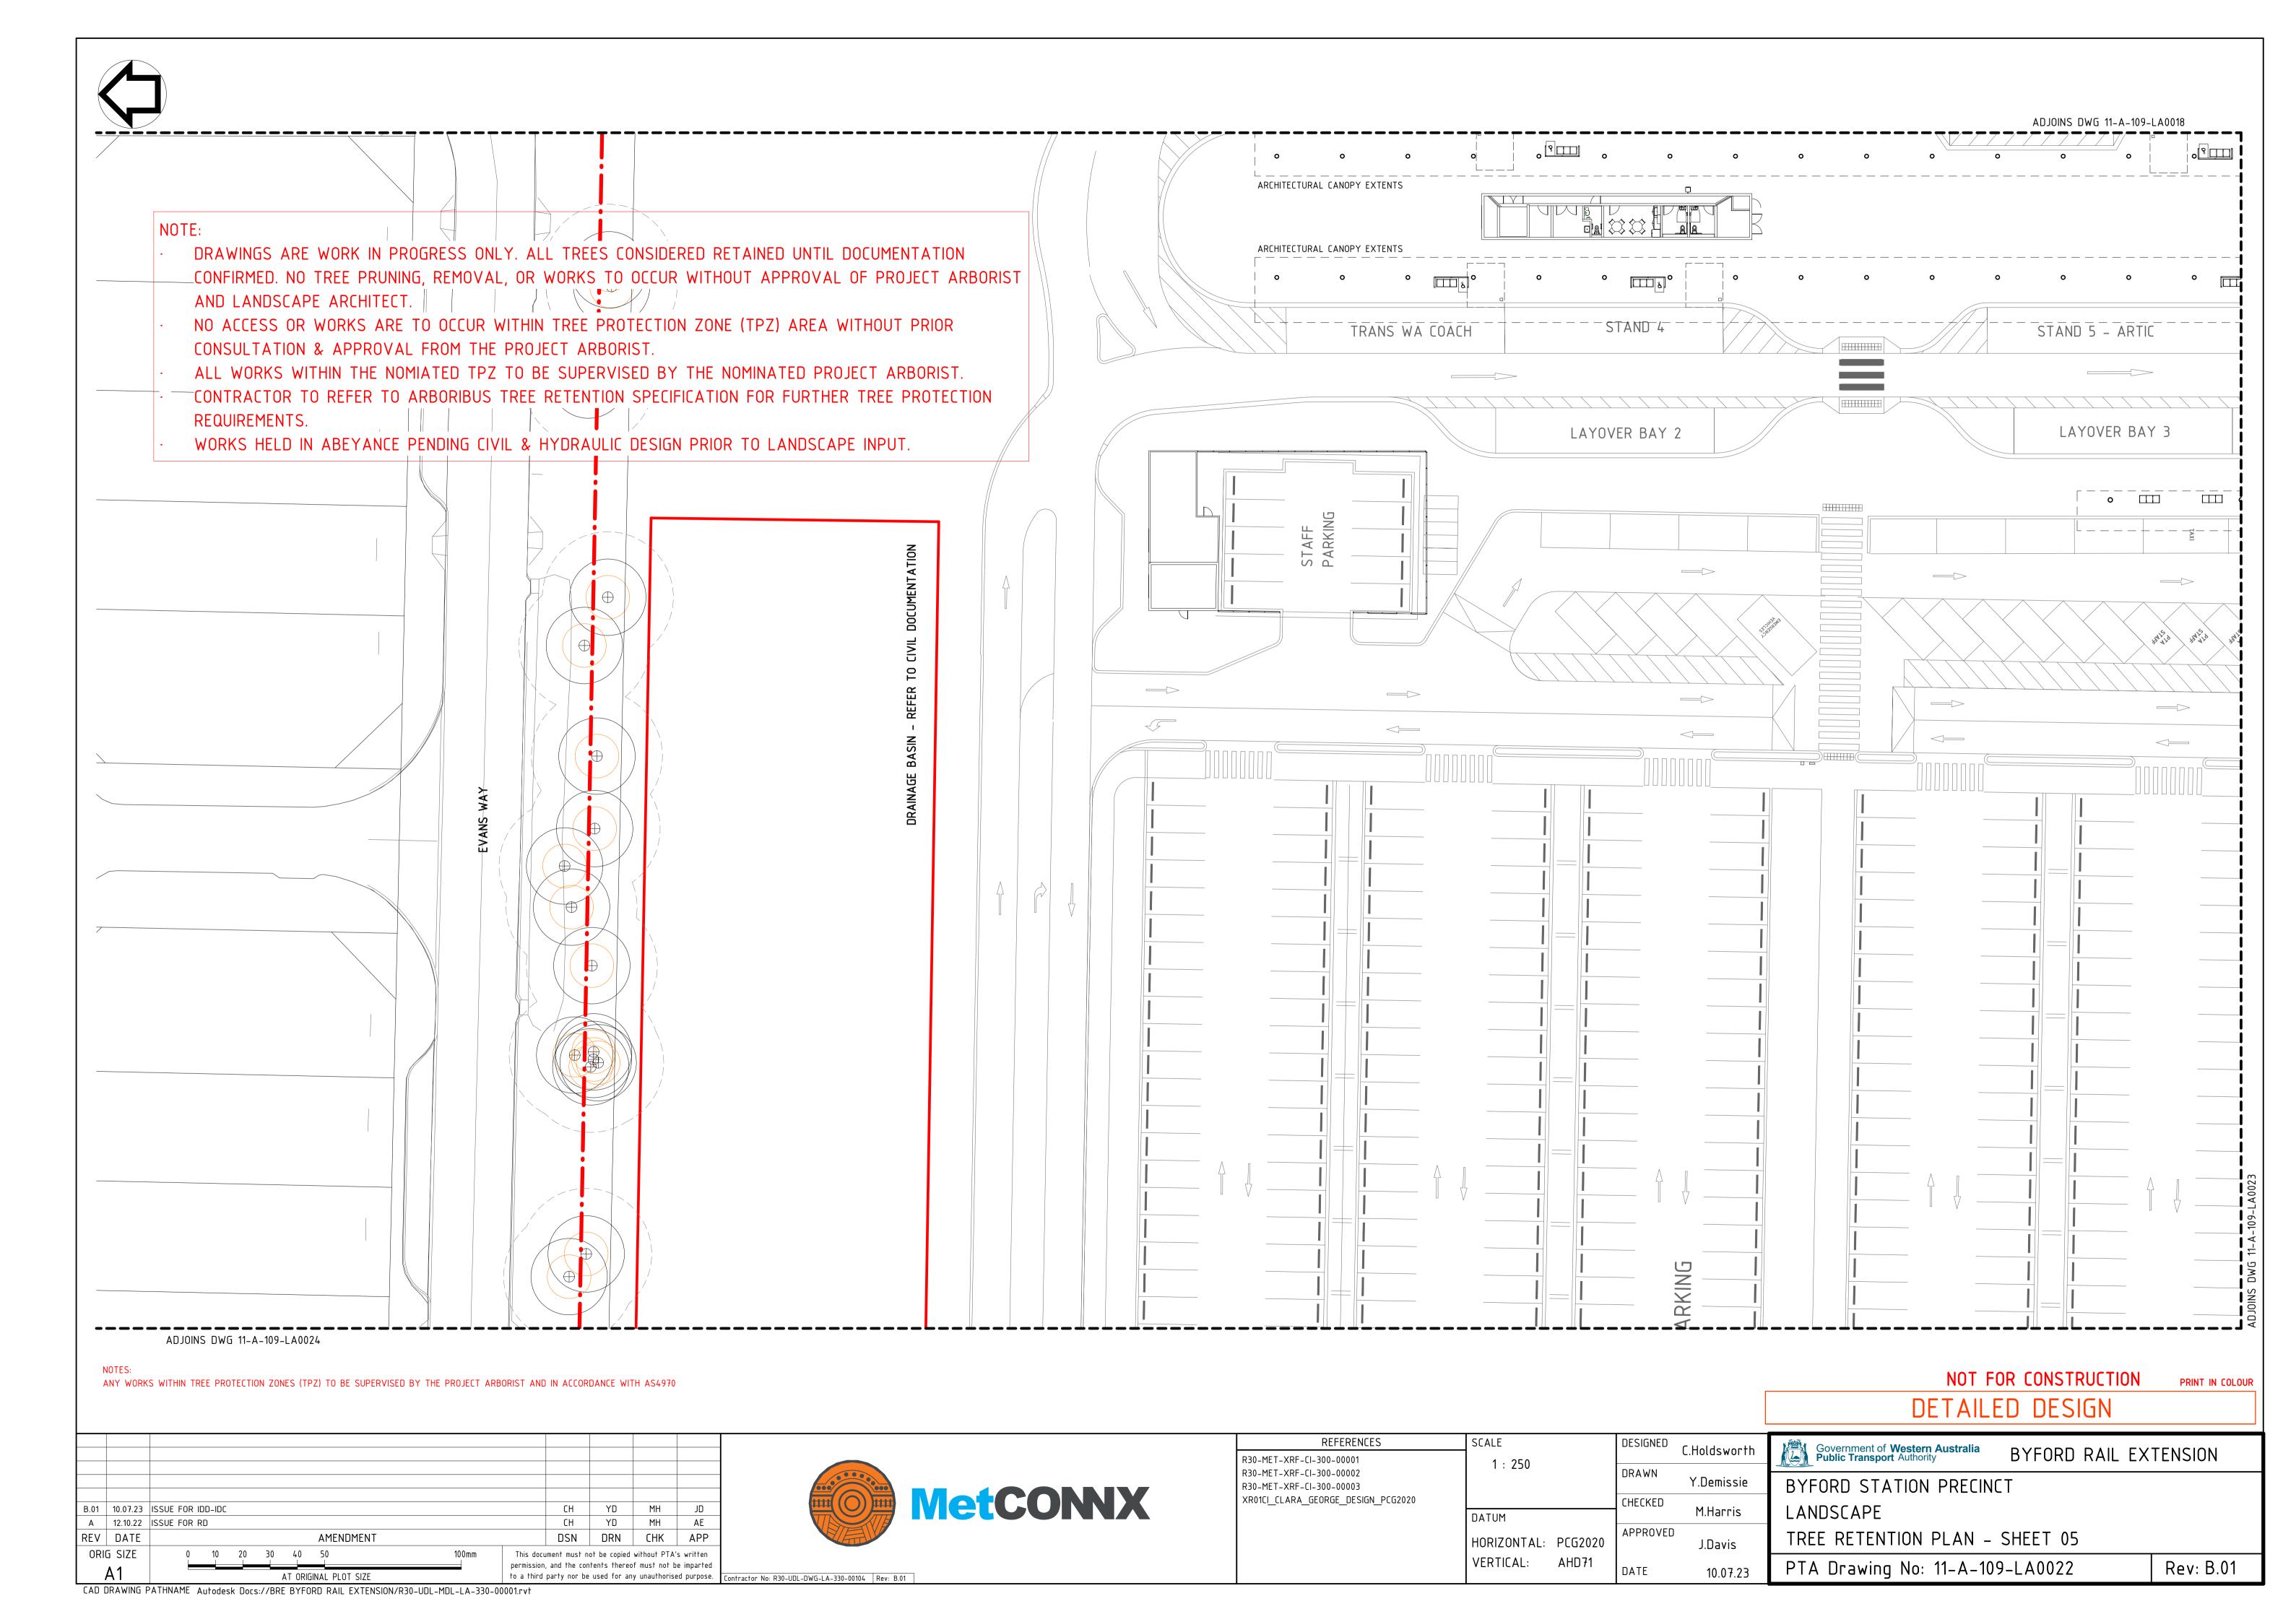


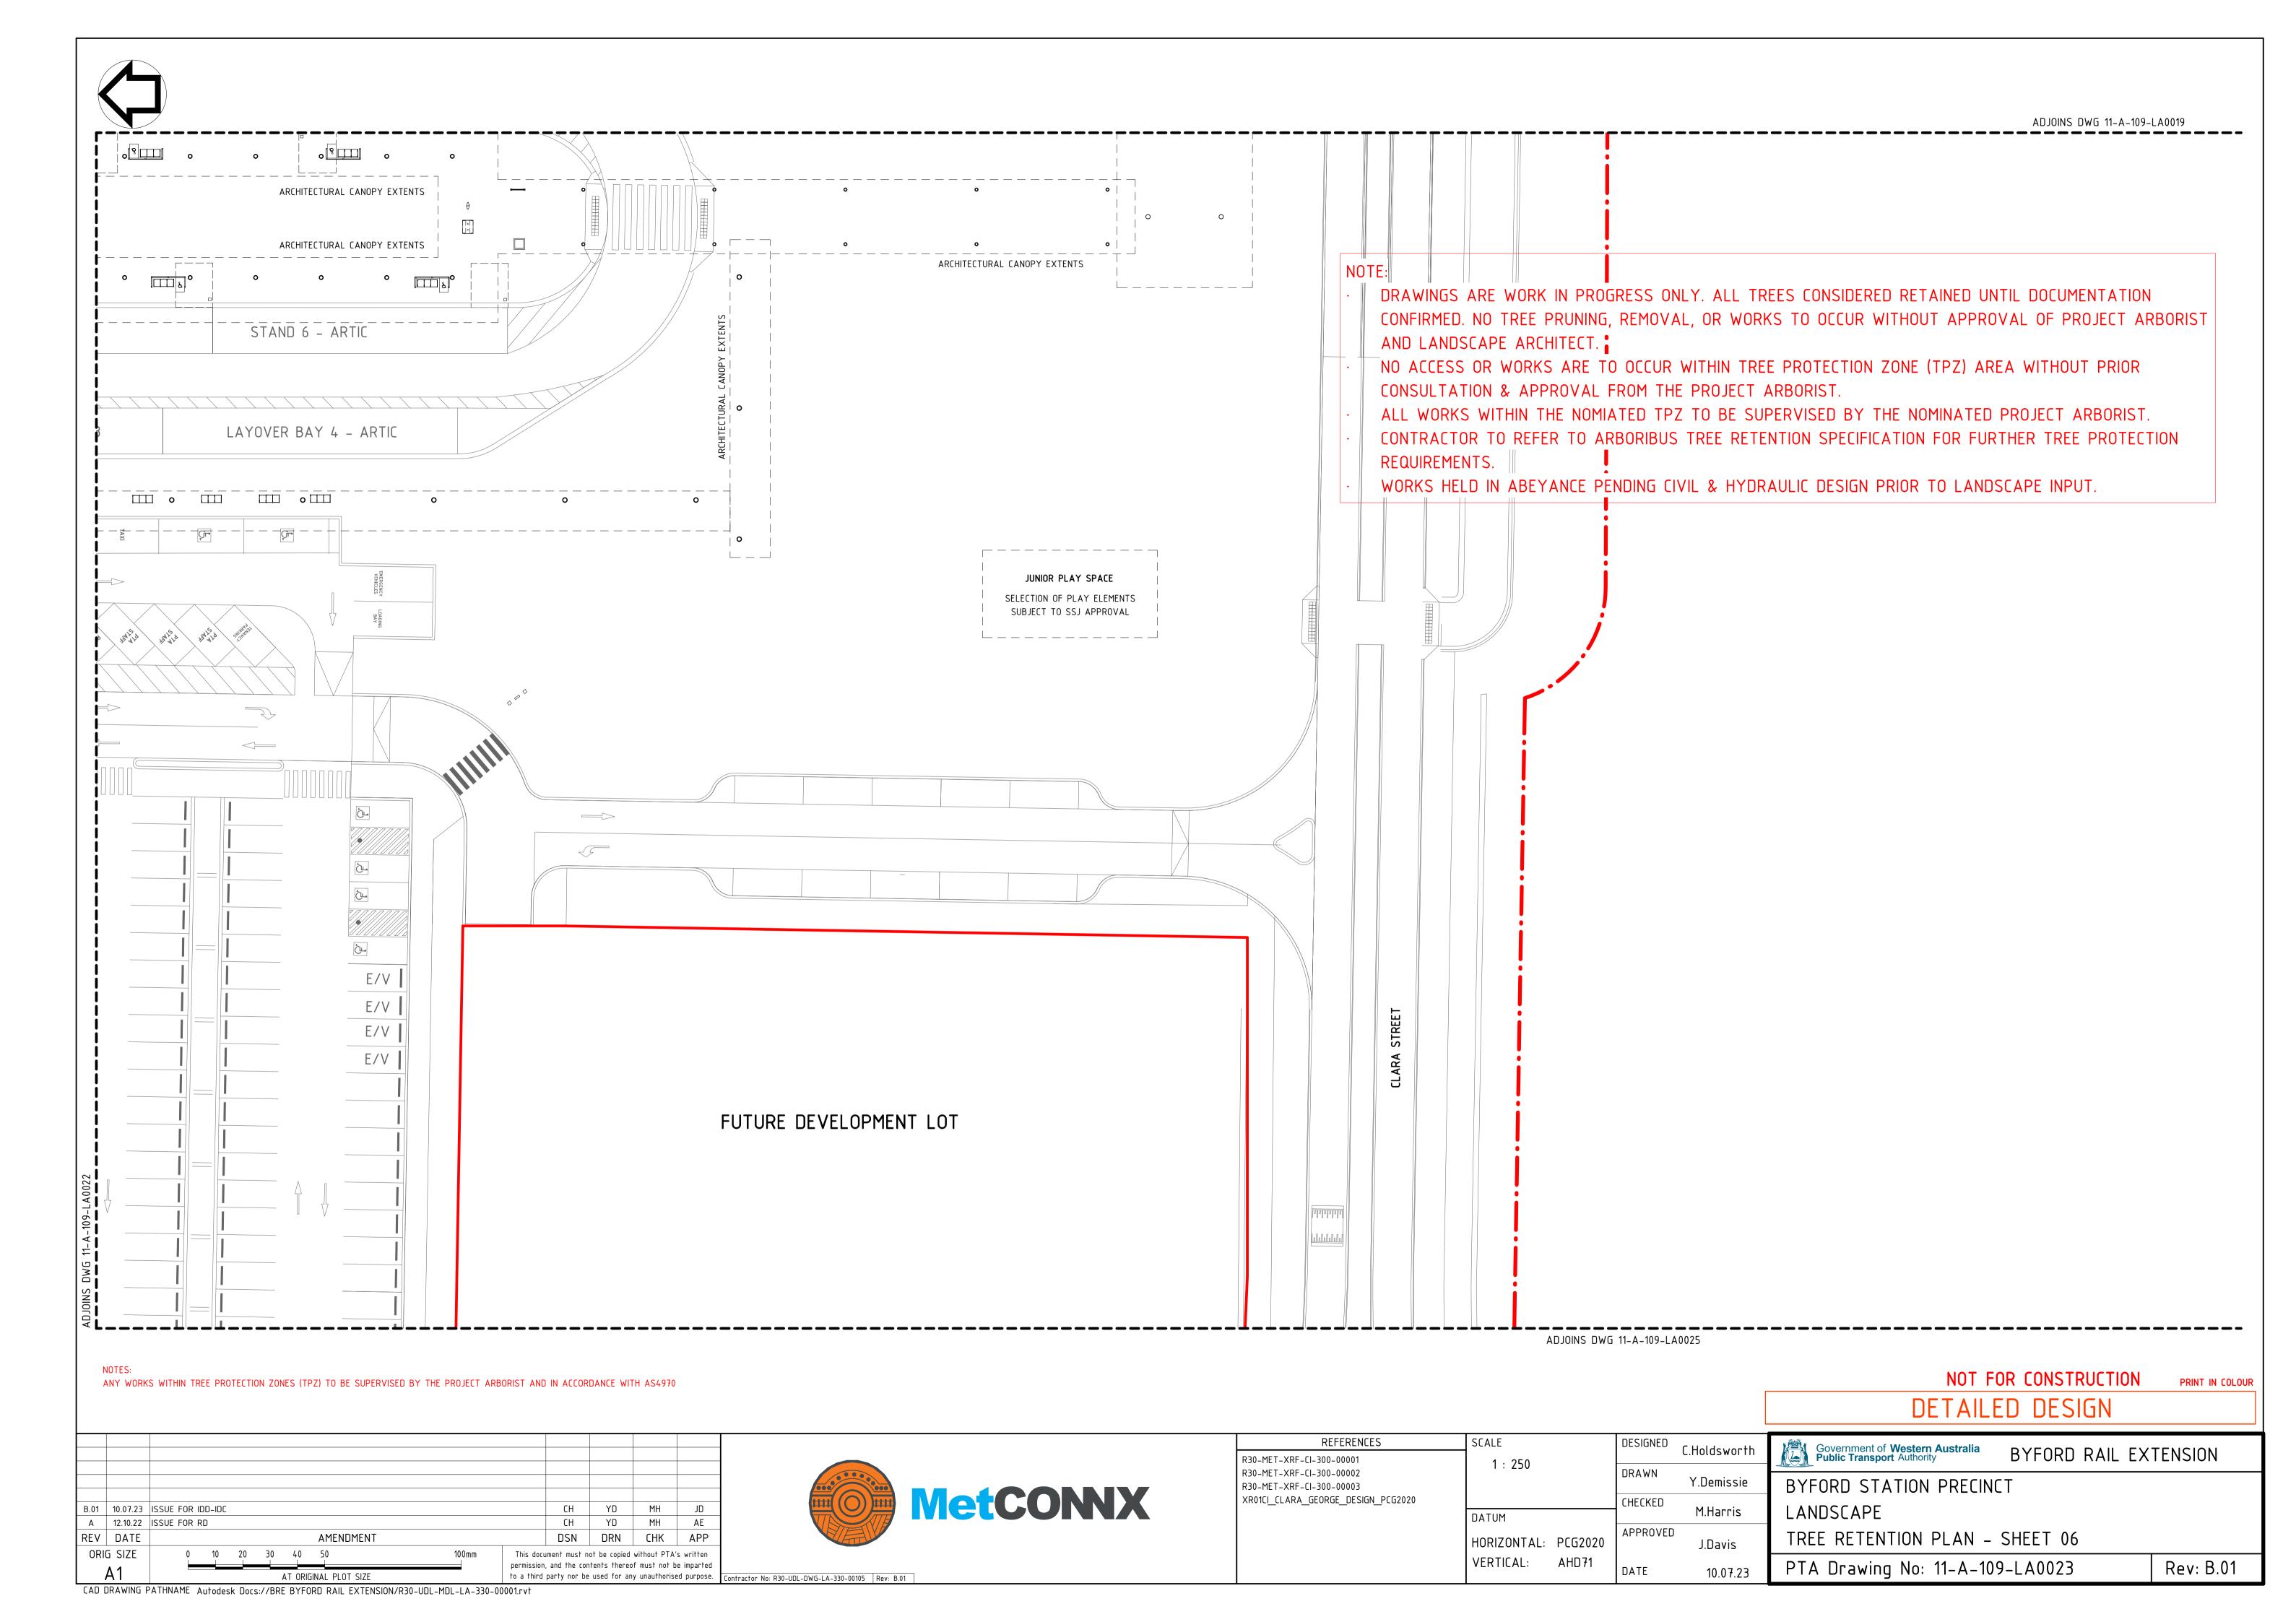

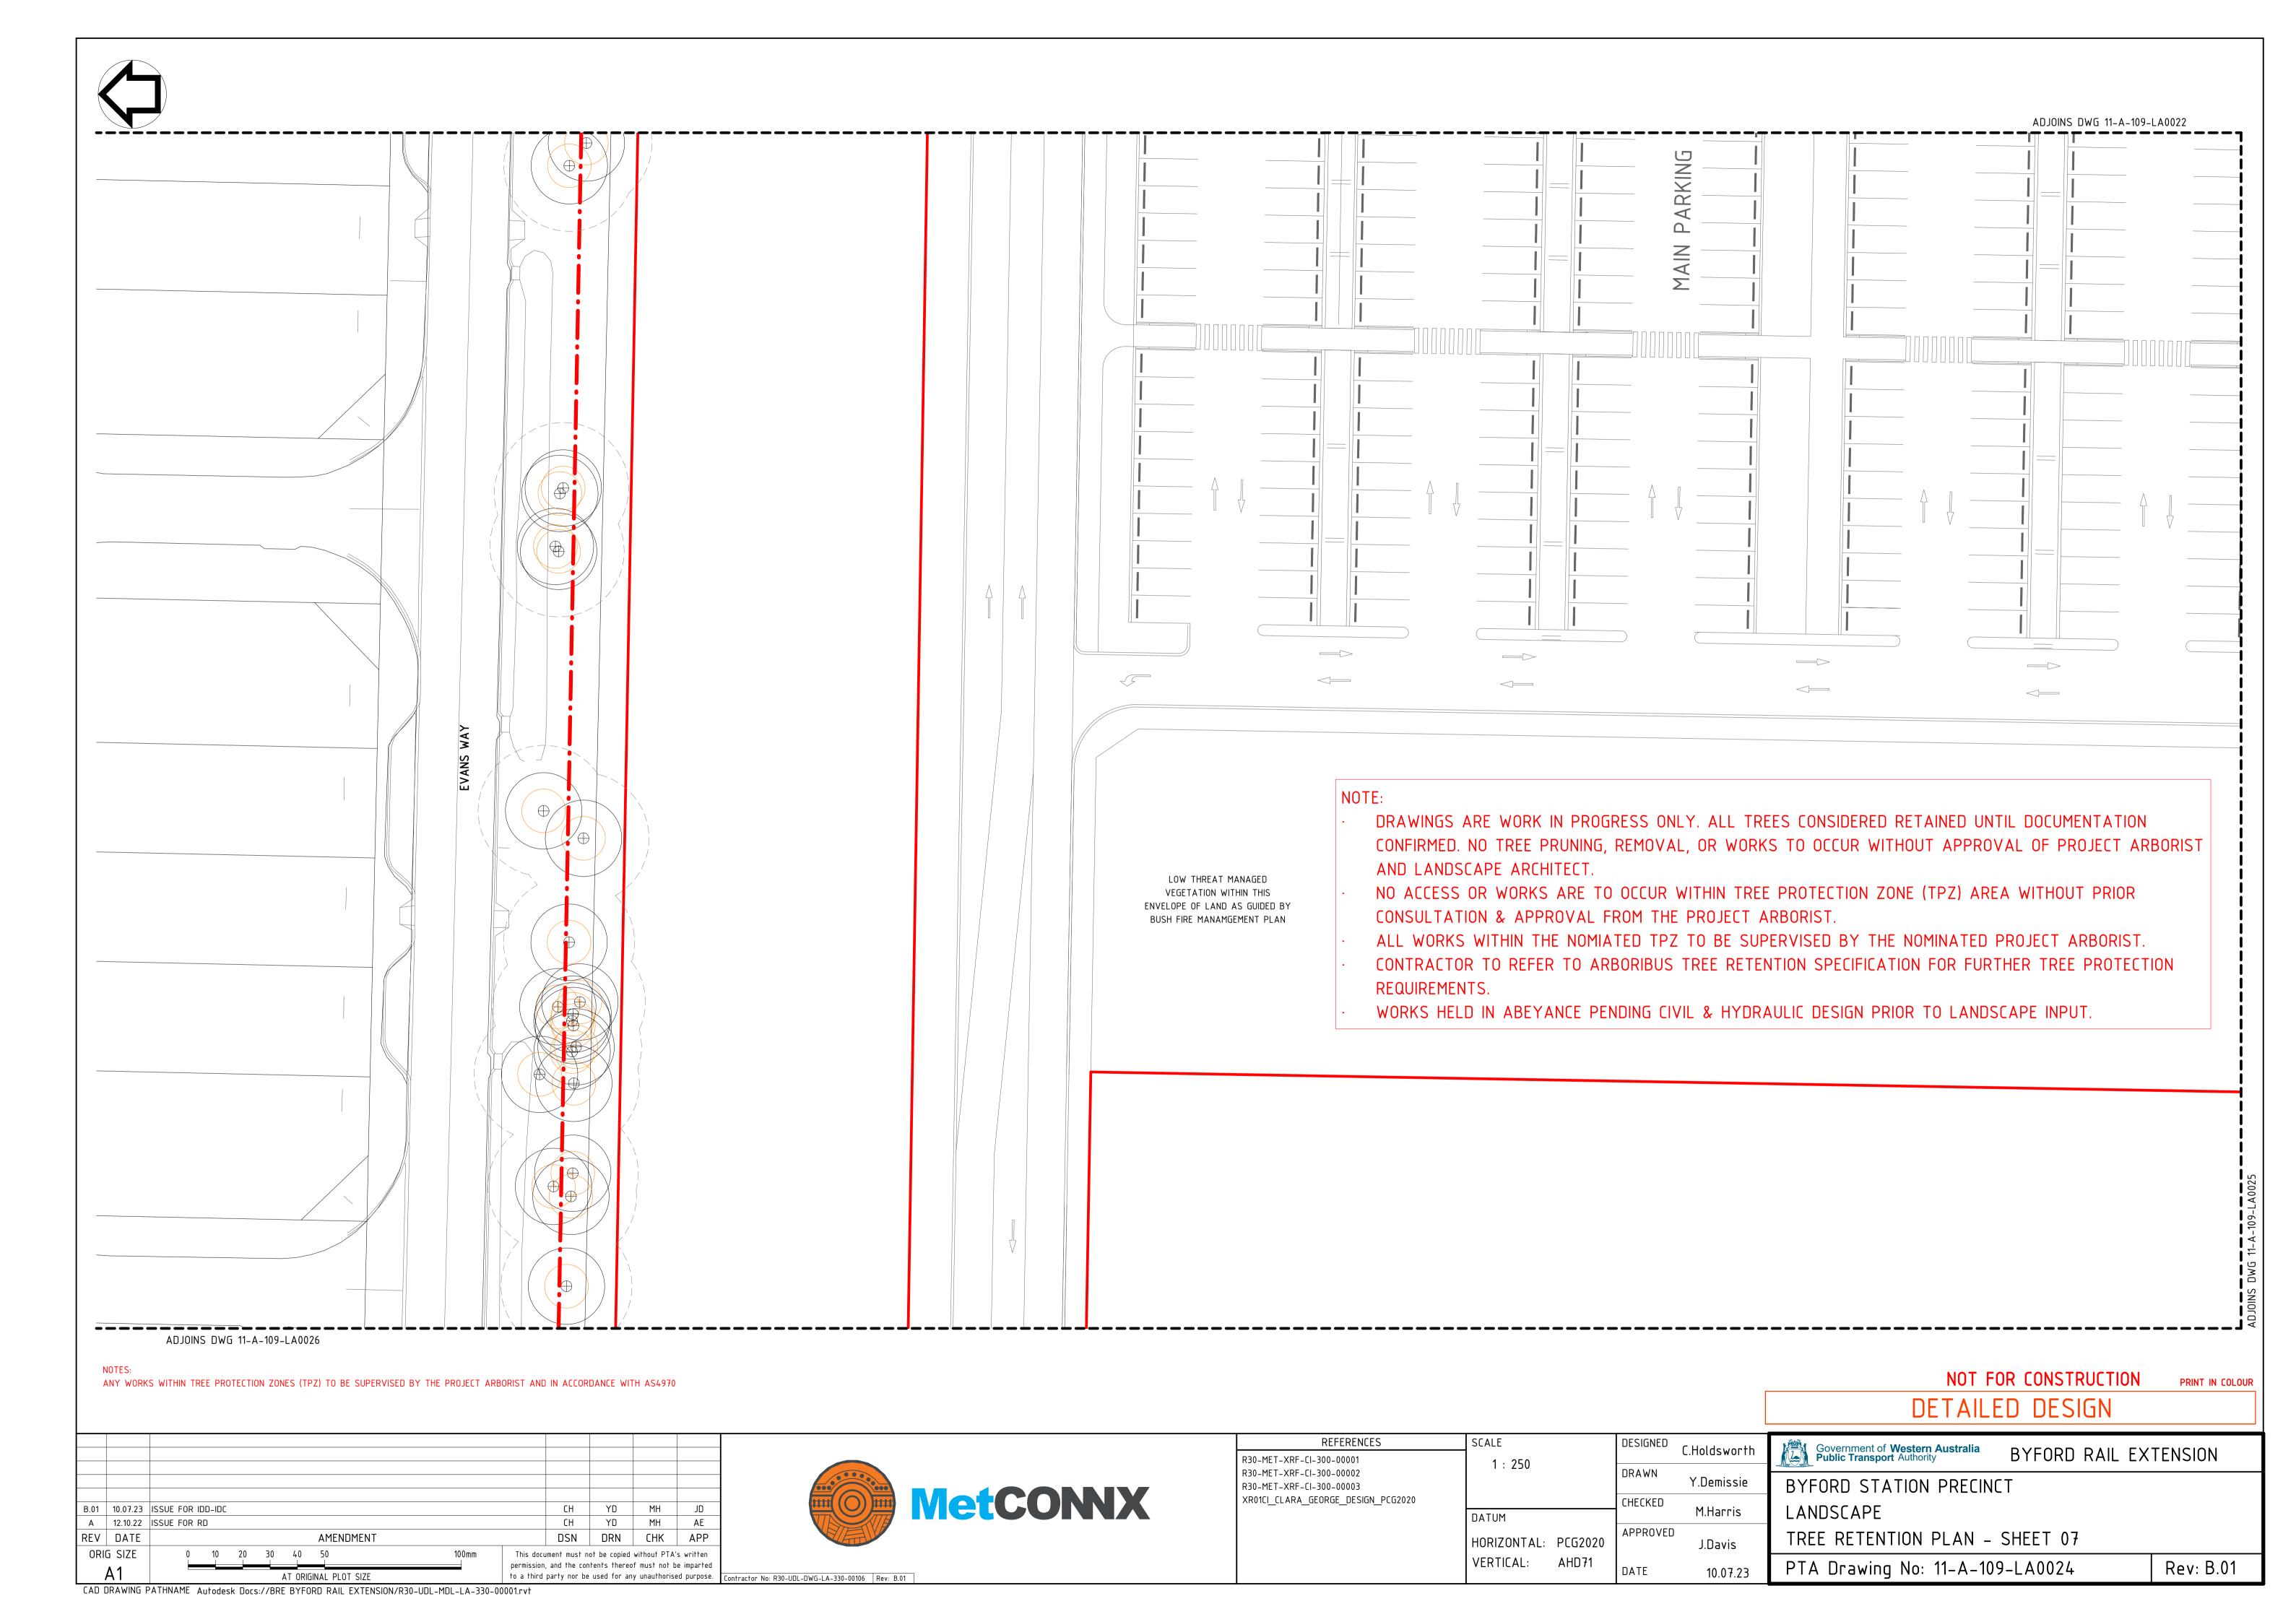

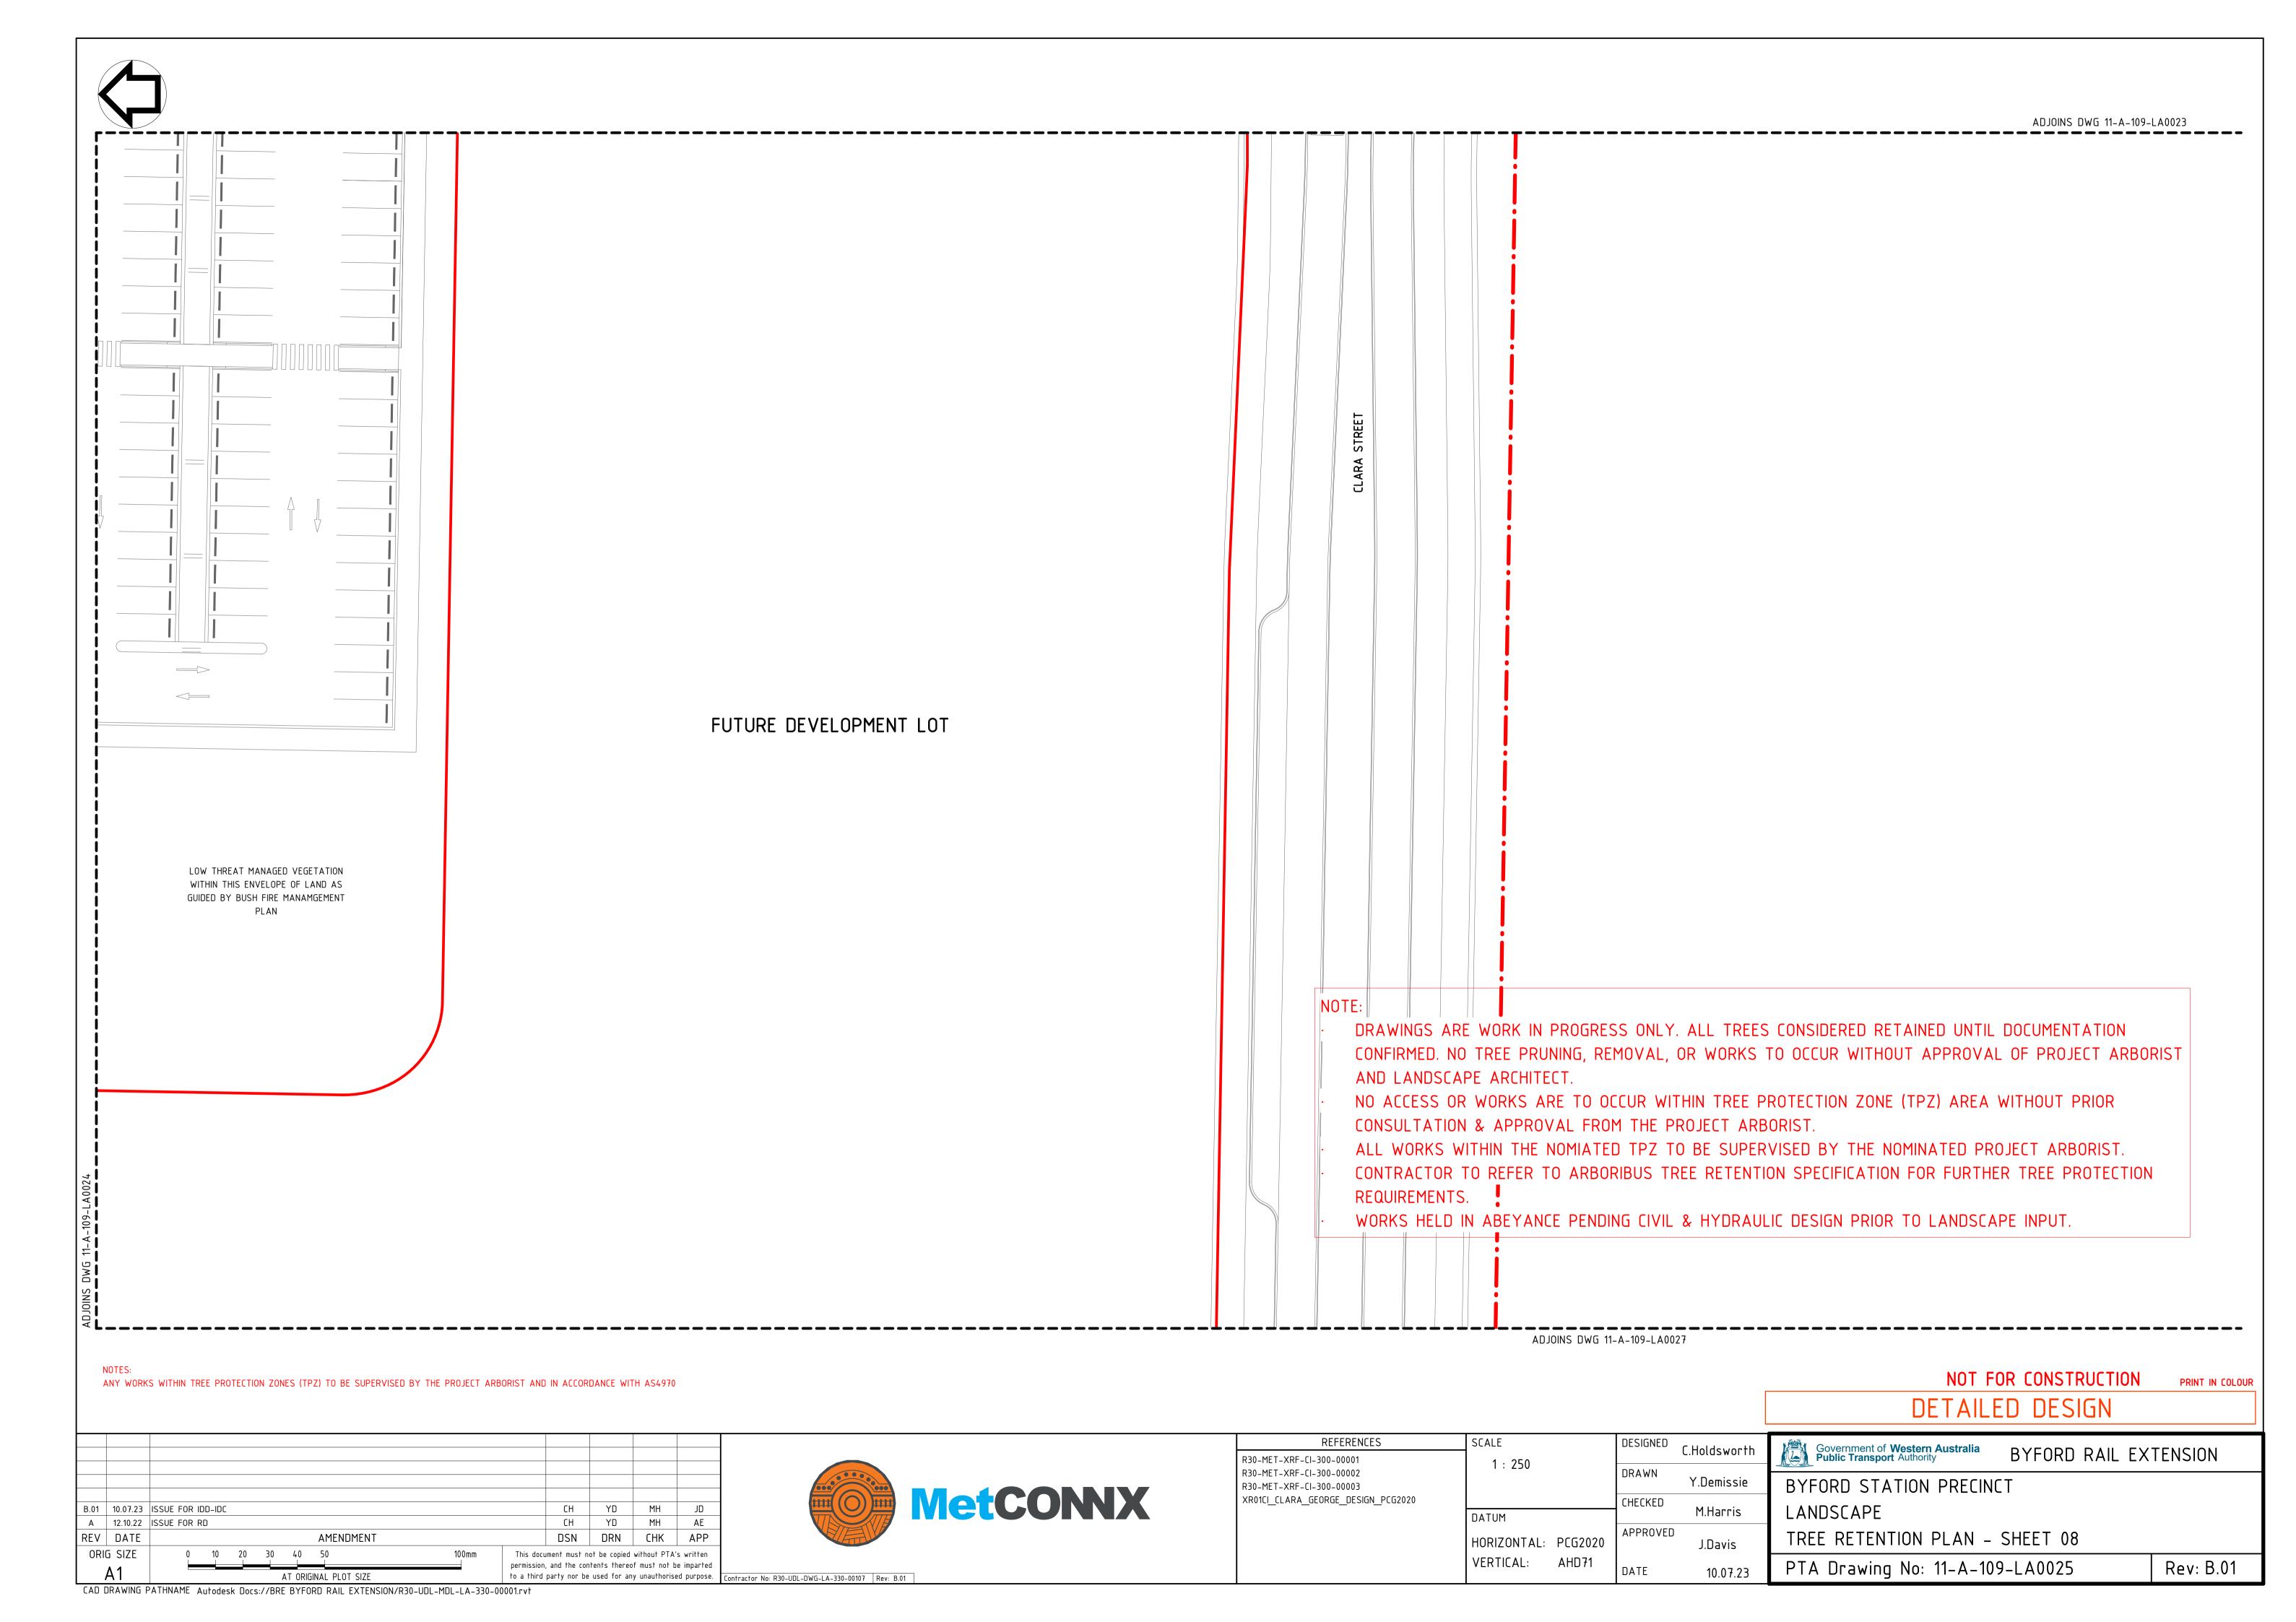

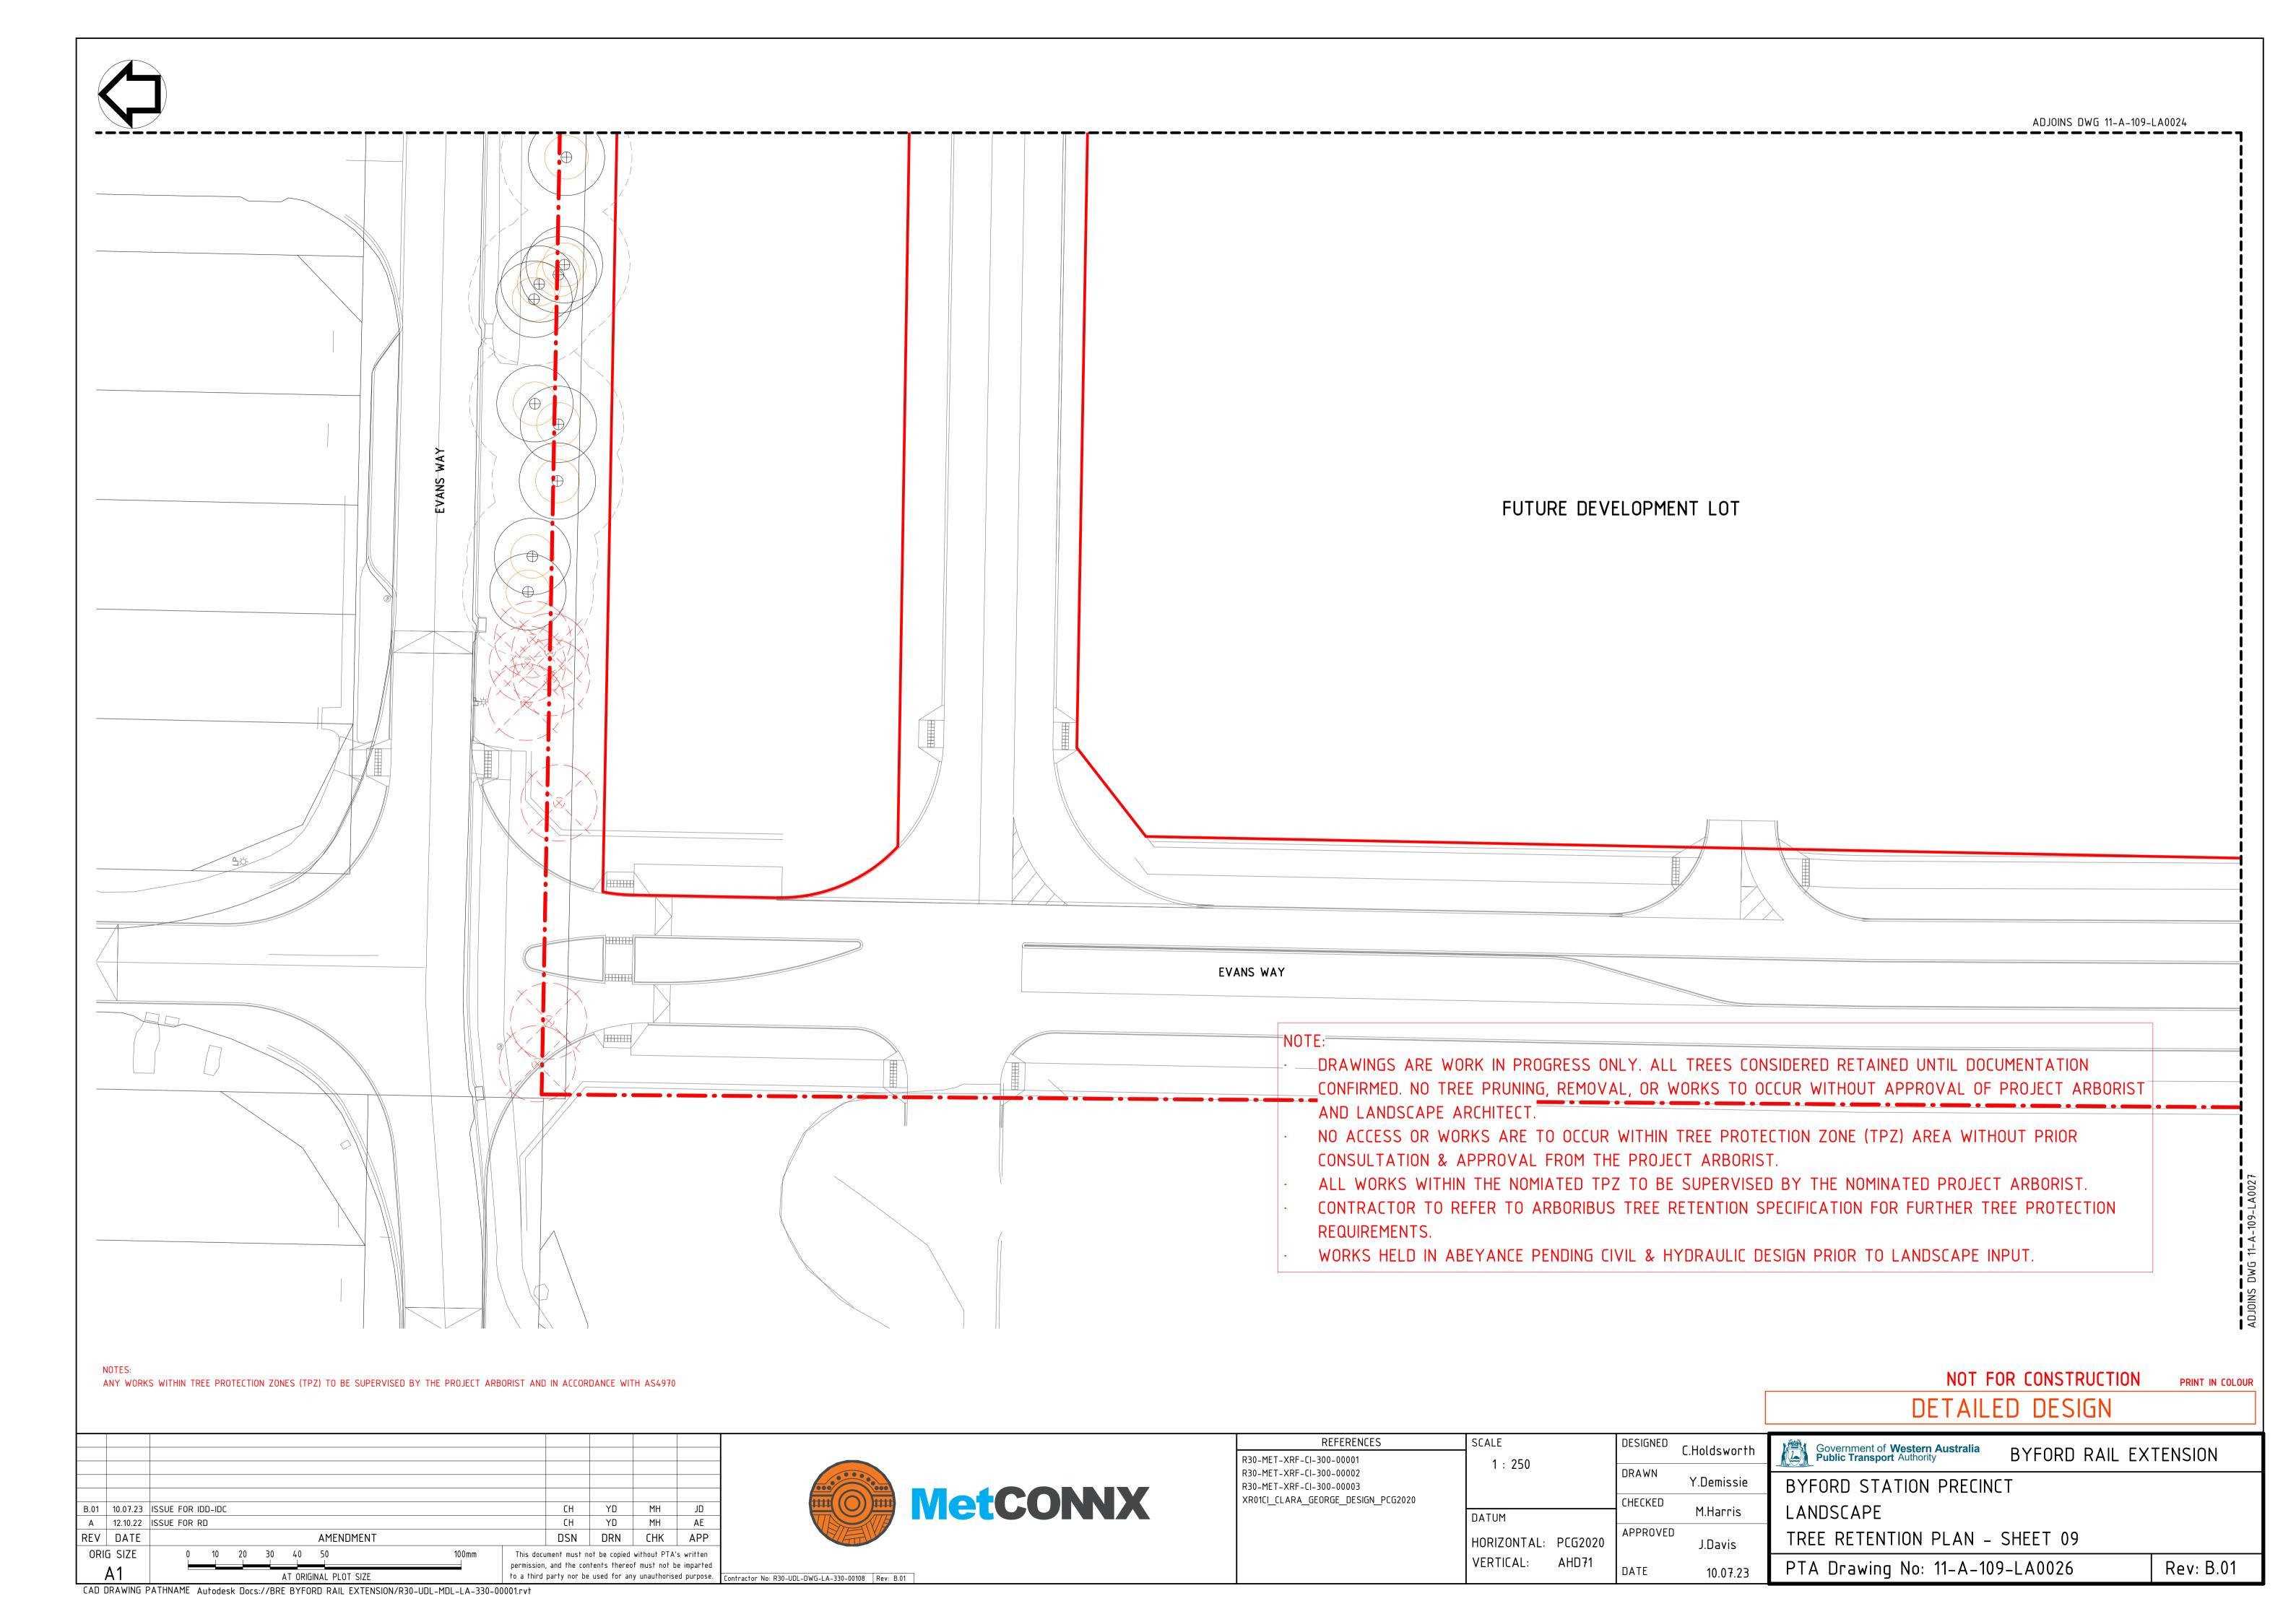

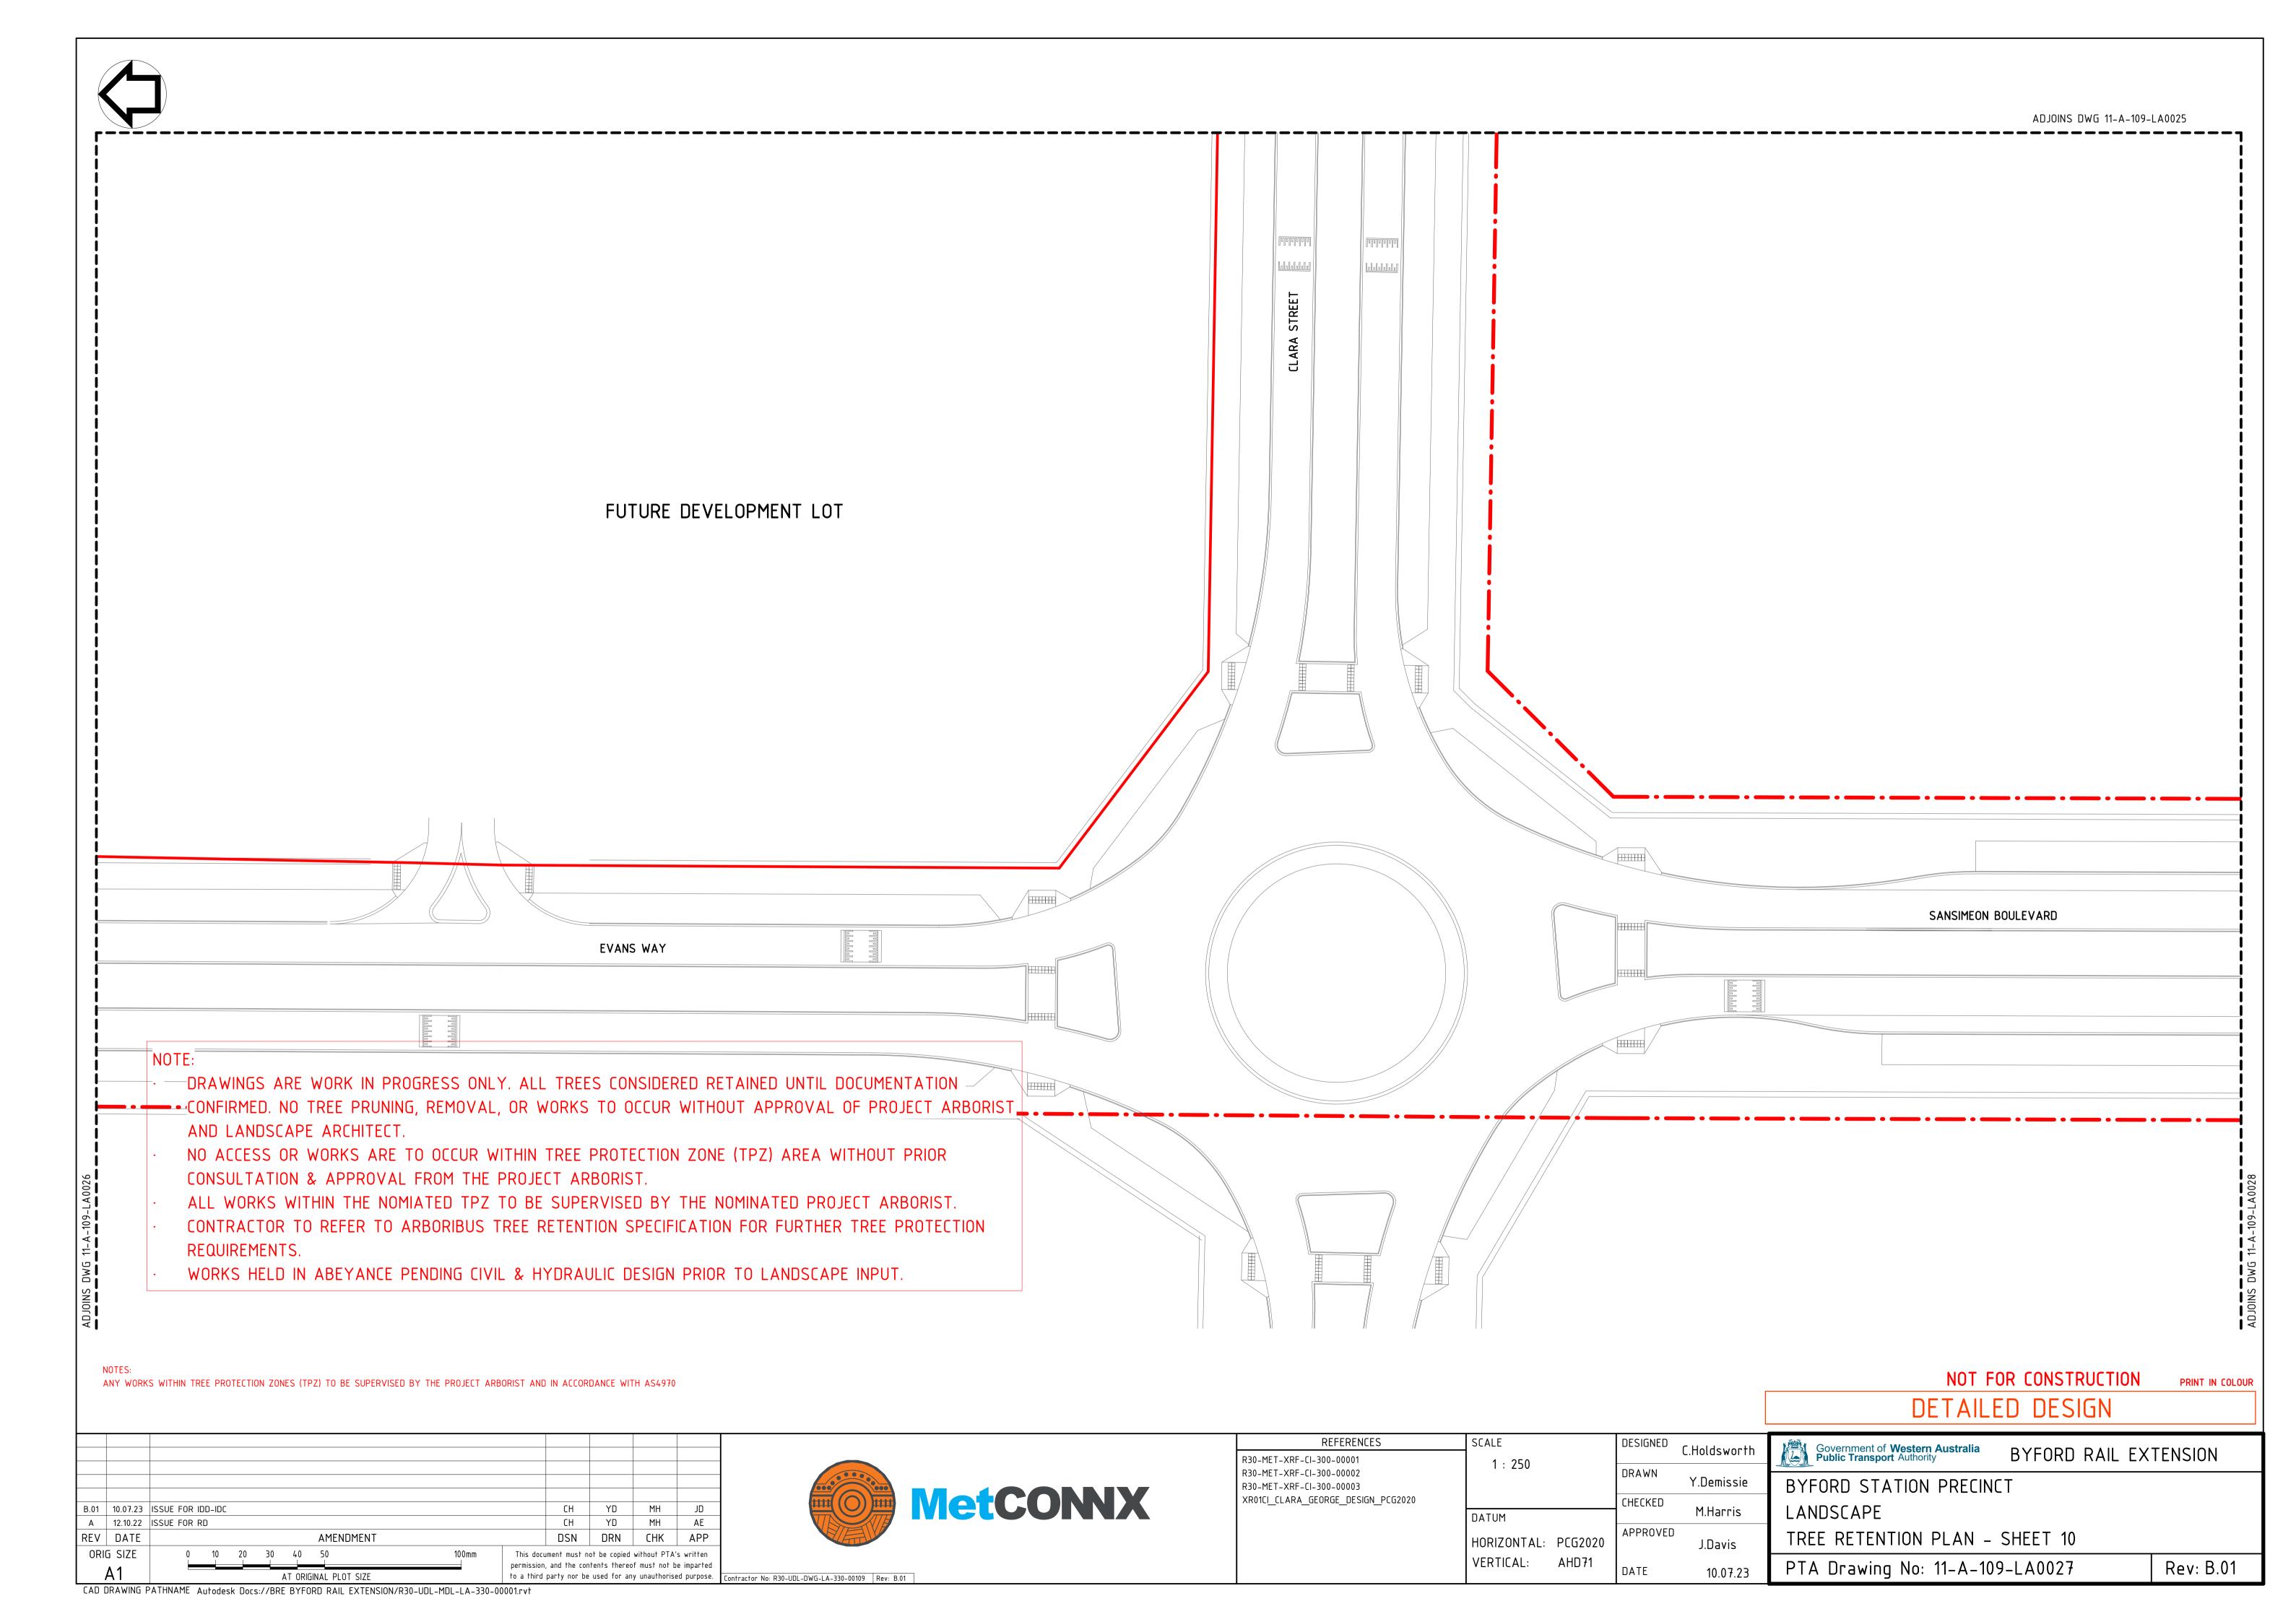



NOTE:

- DRAWINGS ARE WORK IN PROGRESS ONLY. ALL TREES CONSIDERED RETAINED UNTIL DOCUMENTATION CONFIRMED. NO TREE PRUNING, REMOVAL, OR WORKS TO OCCUR WITHOUT APPROVAL OF PROJECT ARBORIST AND LANDSCAPE ARCHITECT.
- NO ACCESS OR WORKS ARE TO OCCUR WITHIN TREE PROTECTION ZONE (TPZ) AREA WITHOUT PRIOR CONSULTATION & APPROVAL FROM THE PROJECT ARBORIST.
- ALL WORKS WITHIN THE NOMIATED TPZ TO BE SUPERVISED BY THE NOMINATED PROJECT ARBORIST.
- CONTRACTOR TO REFER TO ARBORIBUS TREE RETENTION SPECIFICATION FOR FURTHER TREE PROTECTION REQUIREMENTS.
- WORKS HELD IN ABEYANCE PENDING CIVIL & HYDRAULIC DESIGN PRIOR TO LANDSCAPE INPUT.

SANSIMEON BOULEVARD	
SANSITEON BOOLEVAND	
 ·	

INTES:

ANY WORKS WITHIN TREE PROTECTION ZONES (TPZ) TO BE SUPERVISED BY THE PROJECT ARBORIST AND IN ACCORDANCE WITH AS4970

B.01 10.07.23 ISSUE FOR IDD-IDC

A 12.10.22 ISSUE FOR RD

CH YD MH JD

CH YD MH AE

REV DATE

ORIG SIZE

O 10 20 30 40 50

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REFERENCES	SCALE	DESIGNED	C.Holdsworth
R30-MET-XRF-CI-300-00001	1 : 250		C.Hotuswol H
R30-MET-XRF-CI-300-00002 R30-MET-XRF-CI-300-00003		DRAWN	Y.Demissie
XR01CI_CLARA_GEORGE_DESIGN_PCG2020		CHECKED	M I I ! -
	DATUM		M.Harris
	HORIZONTAL: PCG2020	APPROVED	J.Davis

10.07.23


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	Government of Western Australia Public Transport Authority BYFORD RAIL EXTENSION			
	BYFORD STATION PRECINCT			
LANDSCAPE				
TREE RETENTION PLAN - SHEET 11				
	PTA Drawing No: 11-A-109-LA0028 Rev: B.01			


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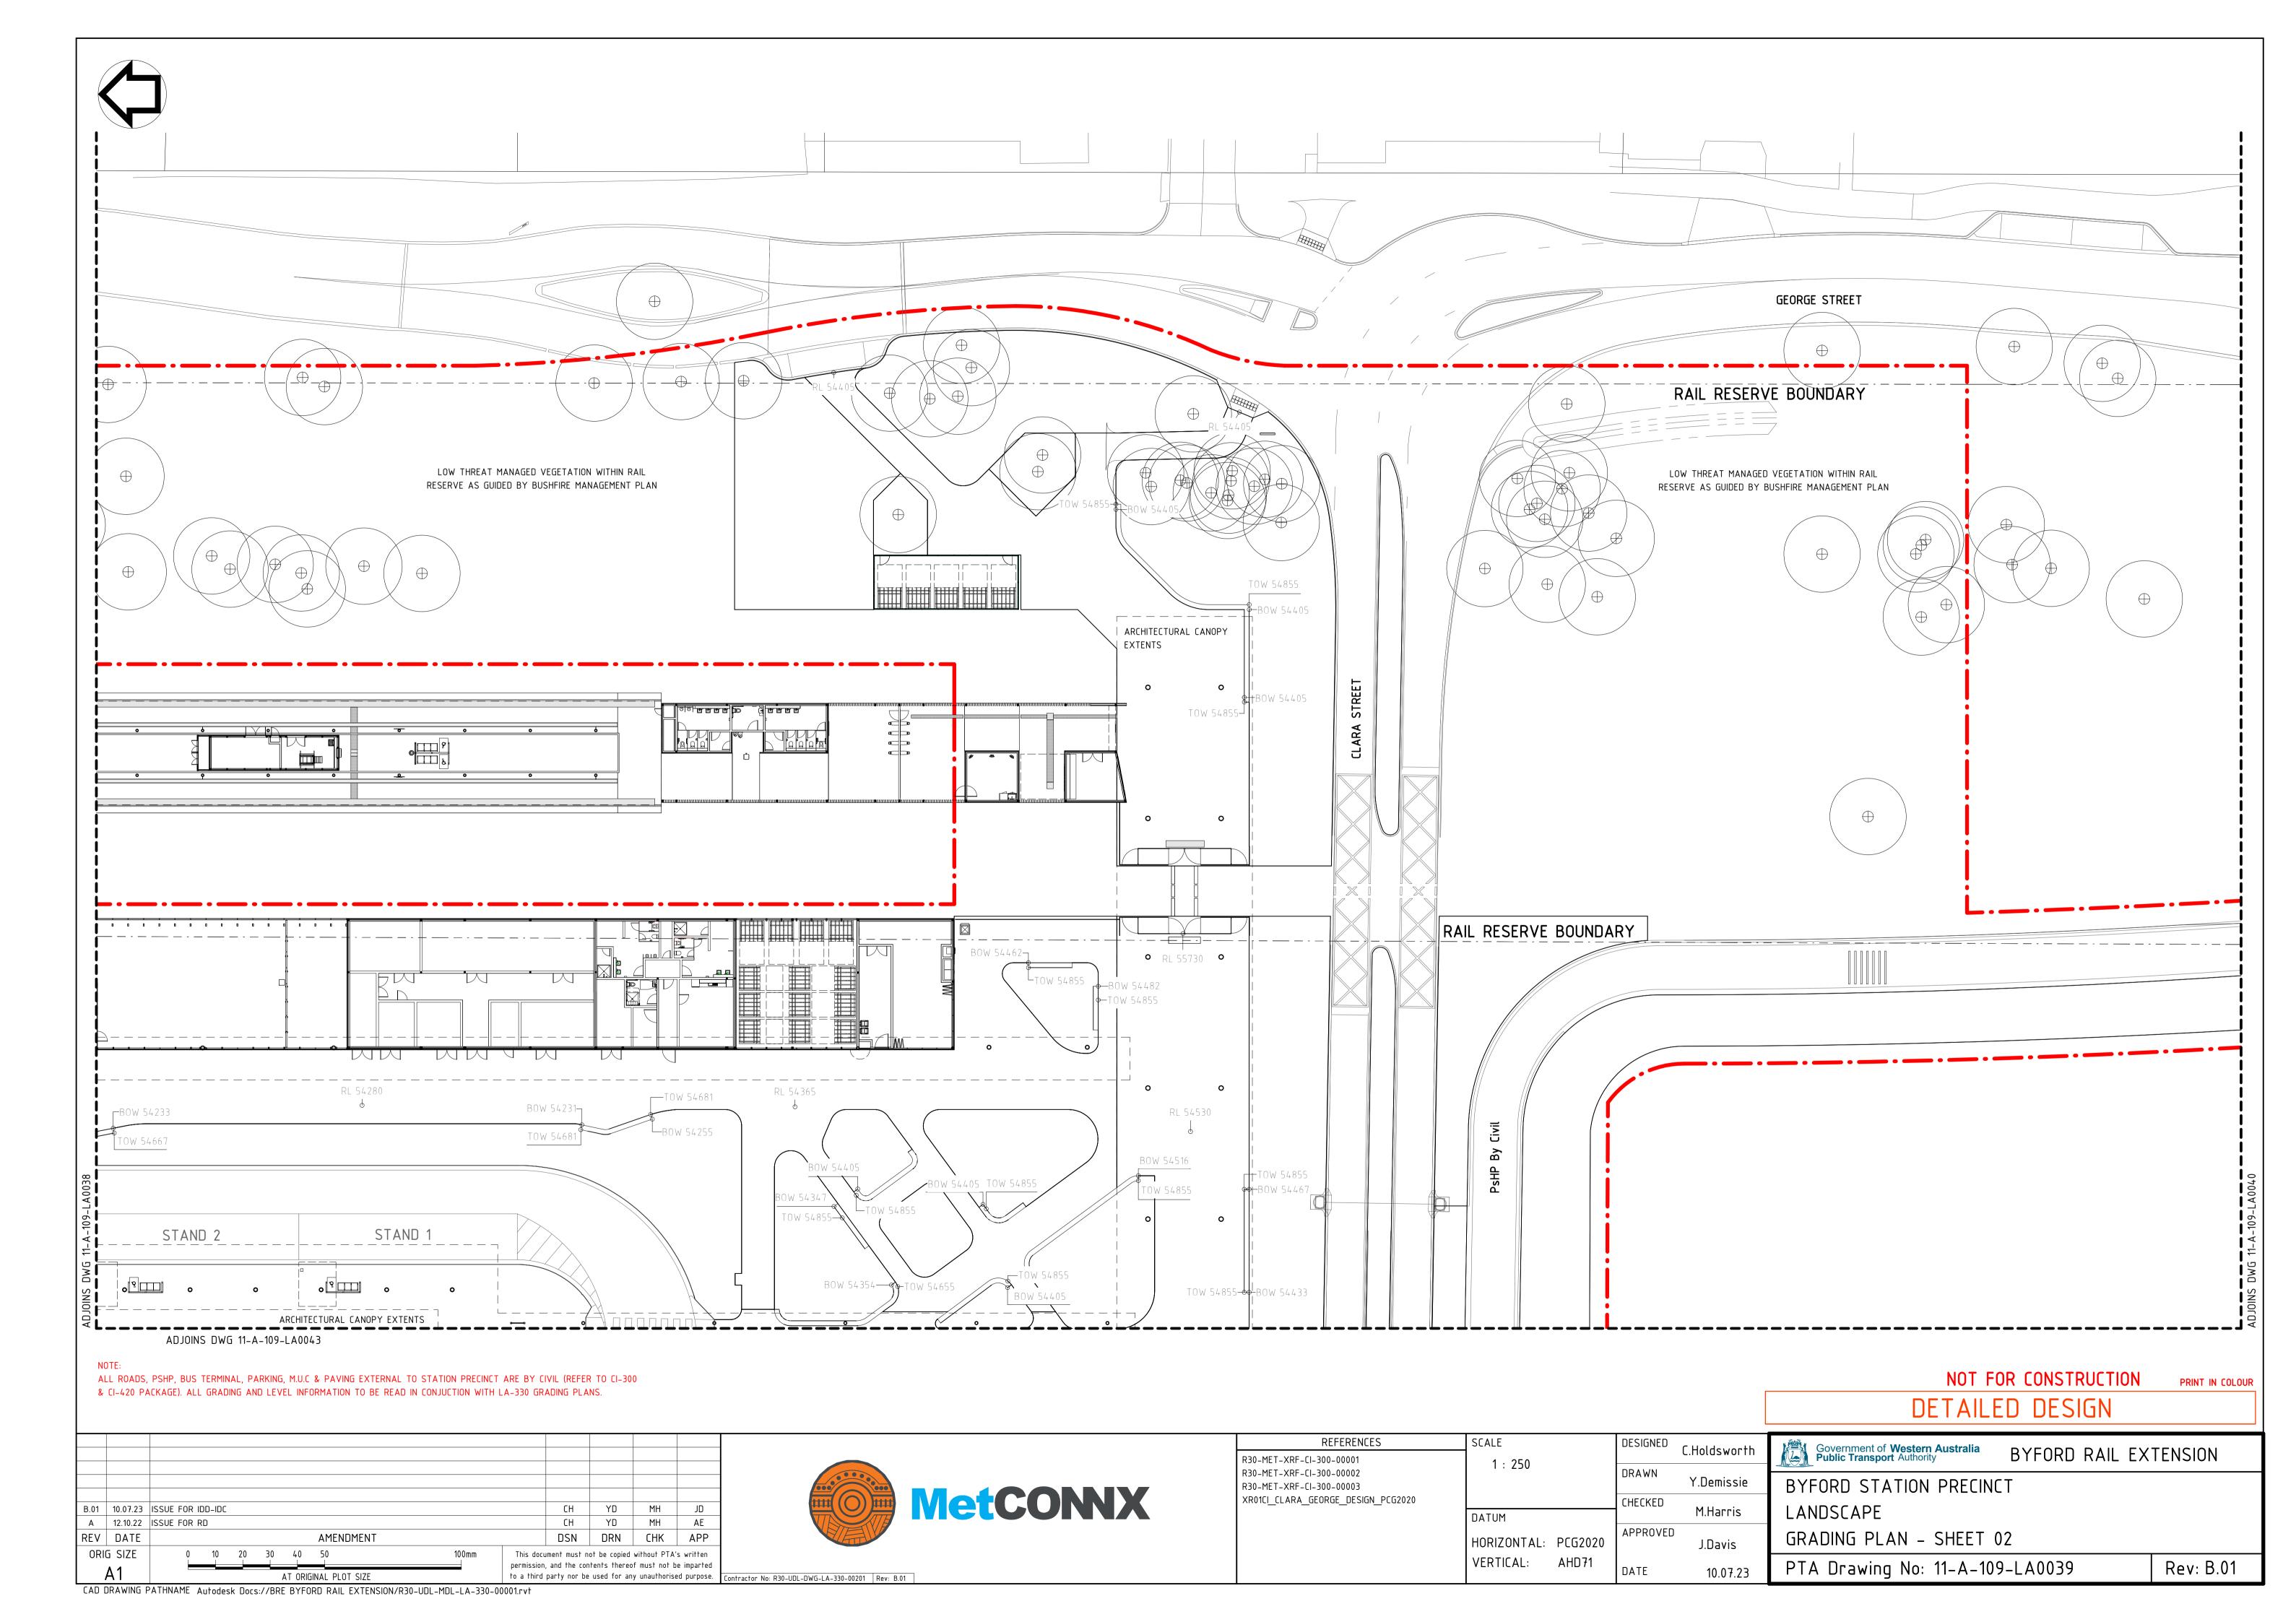
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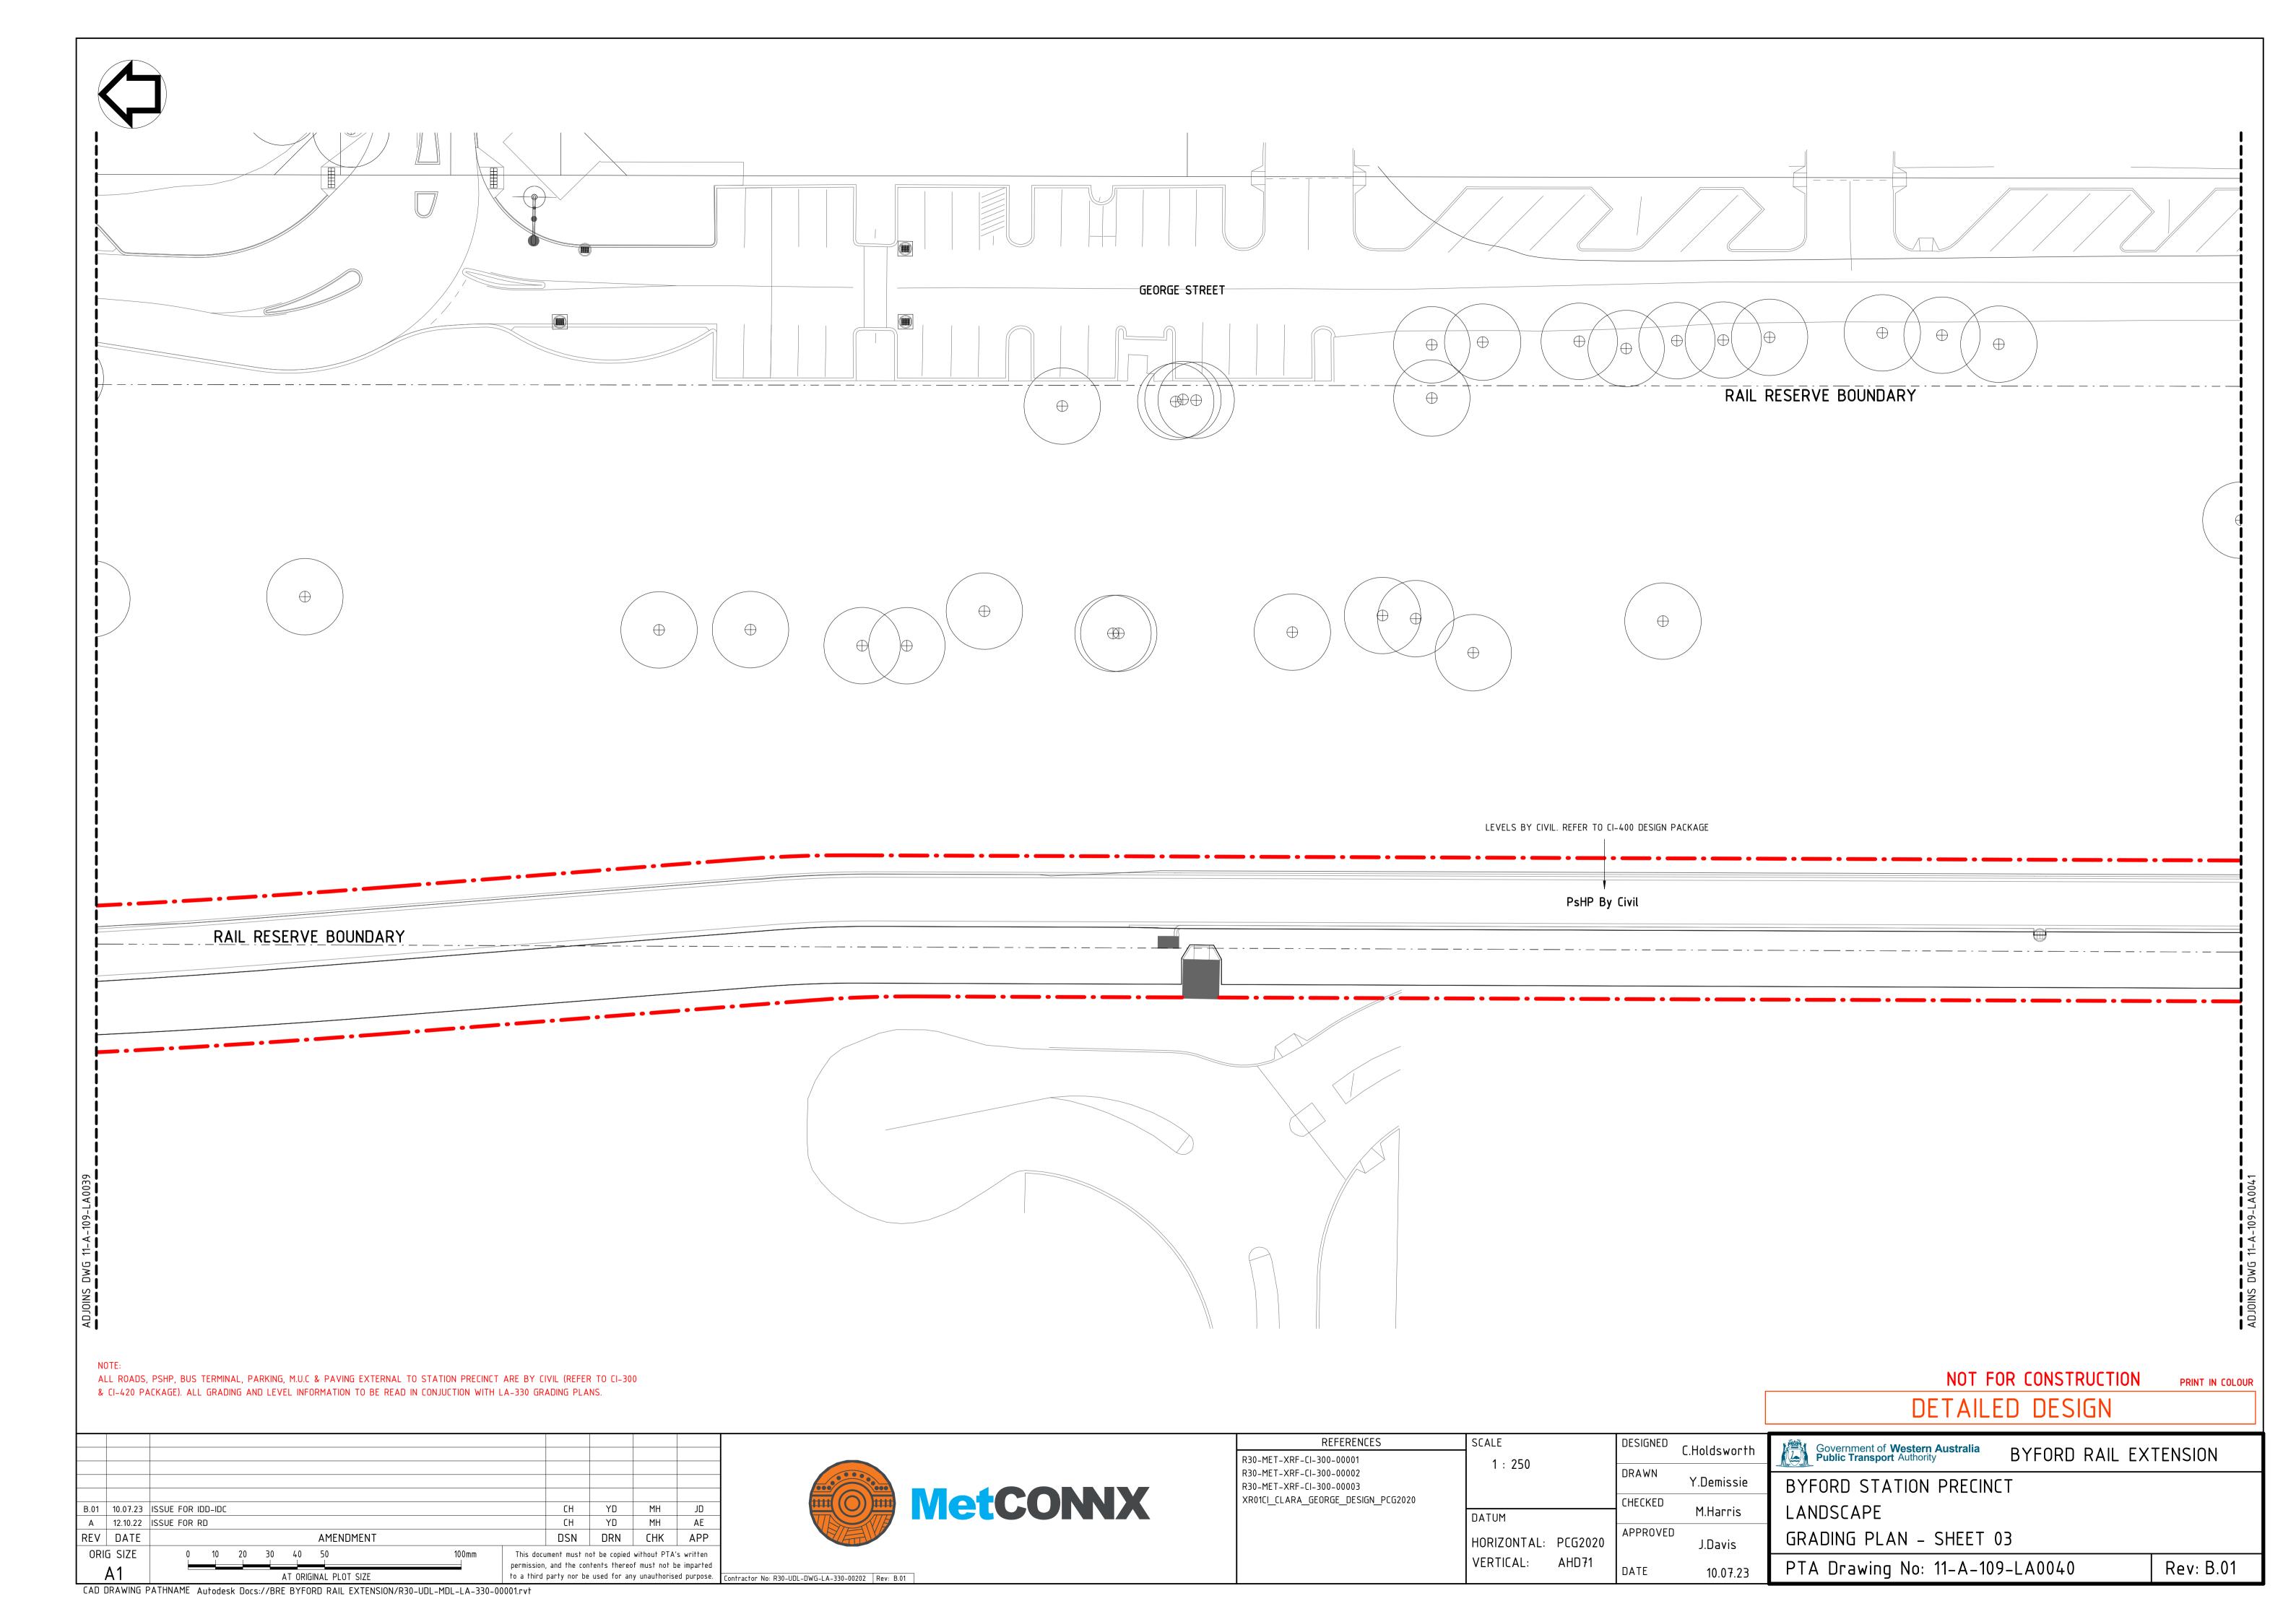
AT ORIGINAL PLOT SIZE to a third party nor be used for any unauthorised purpose. Contractor No: R30-UDL-DWG-LA-330-00110 Rev: B.01


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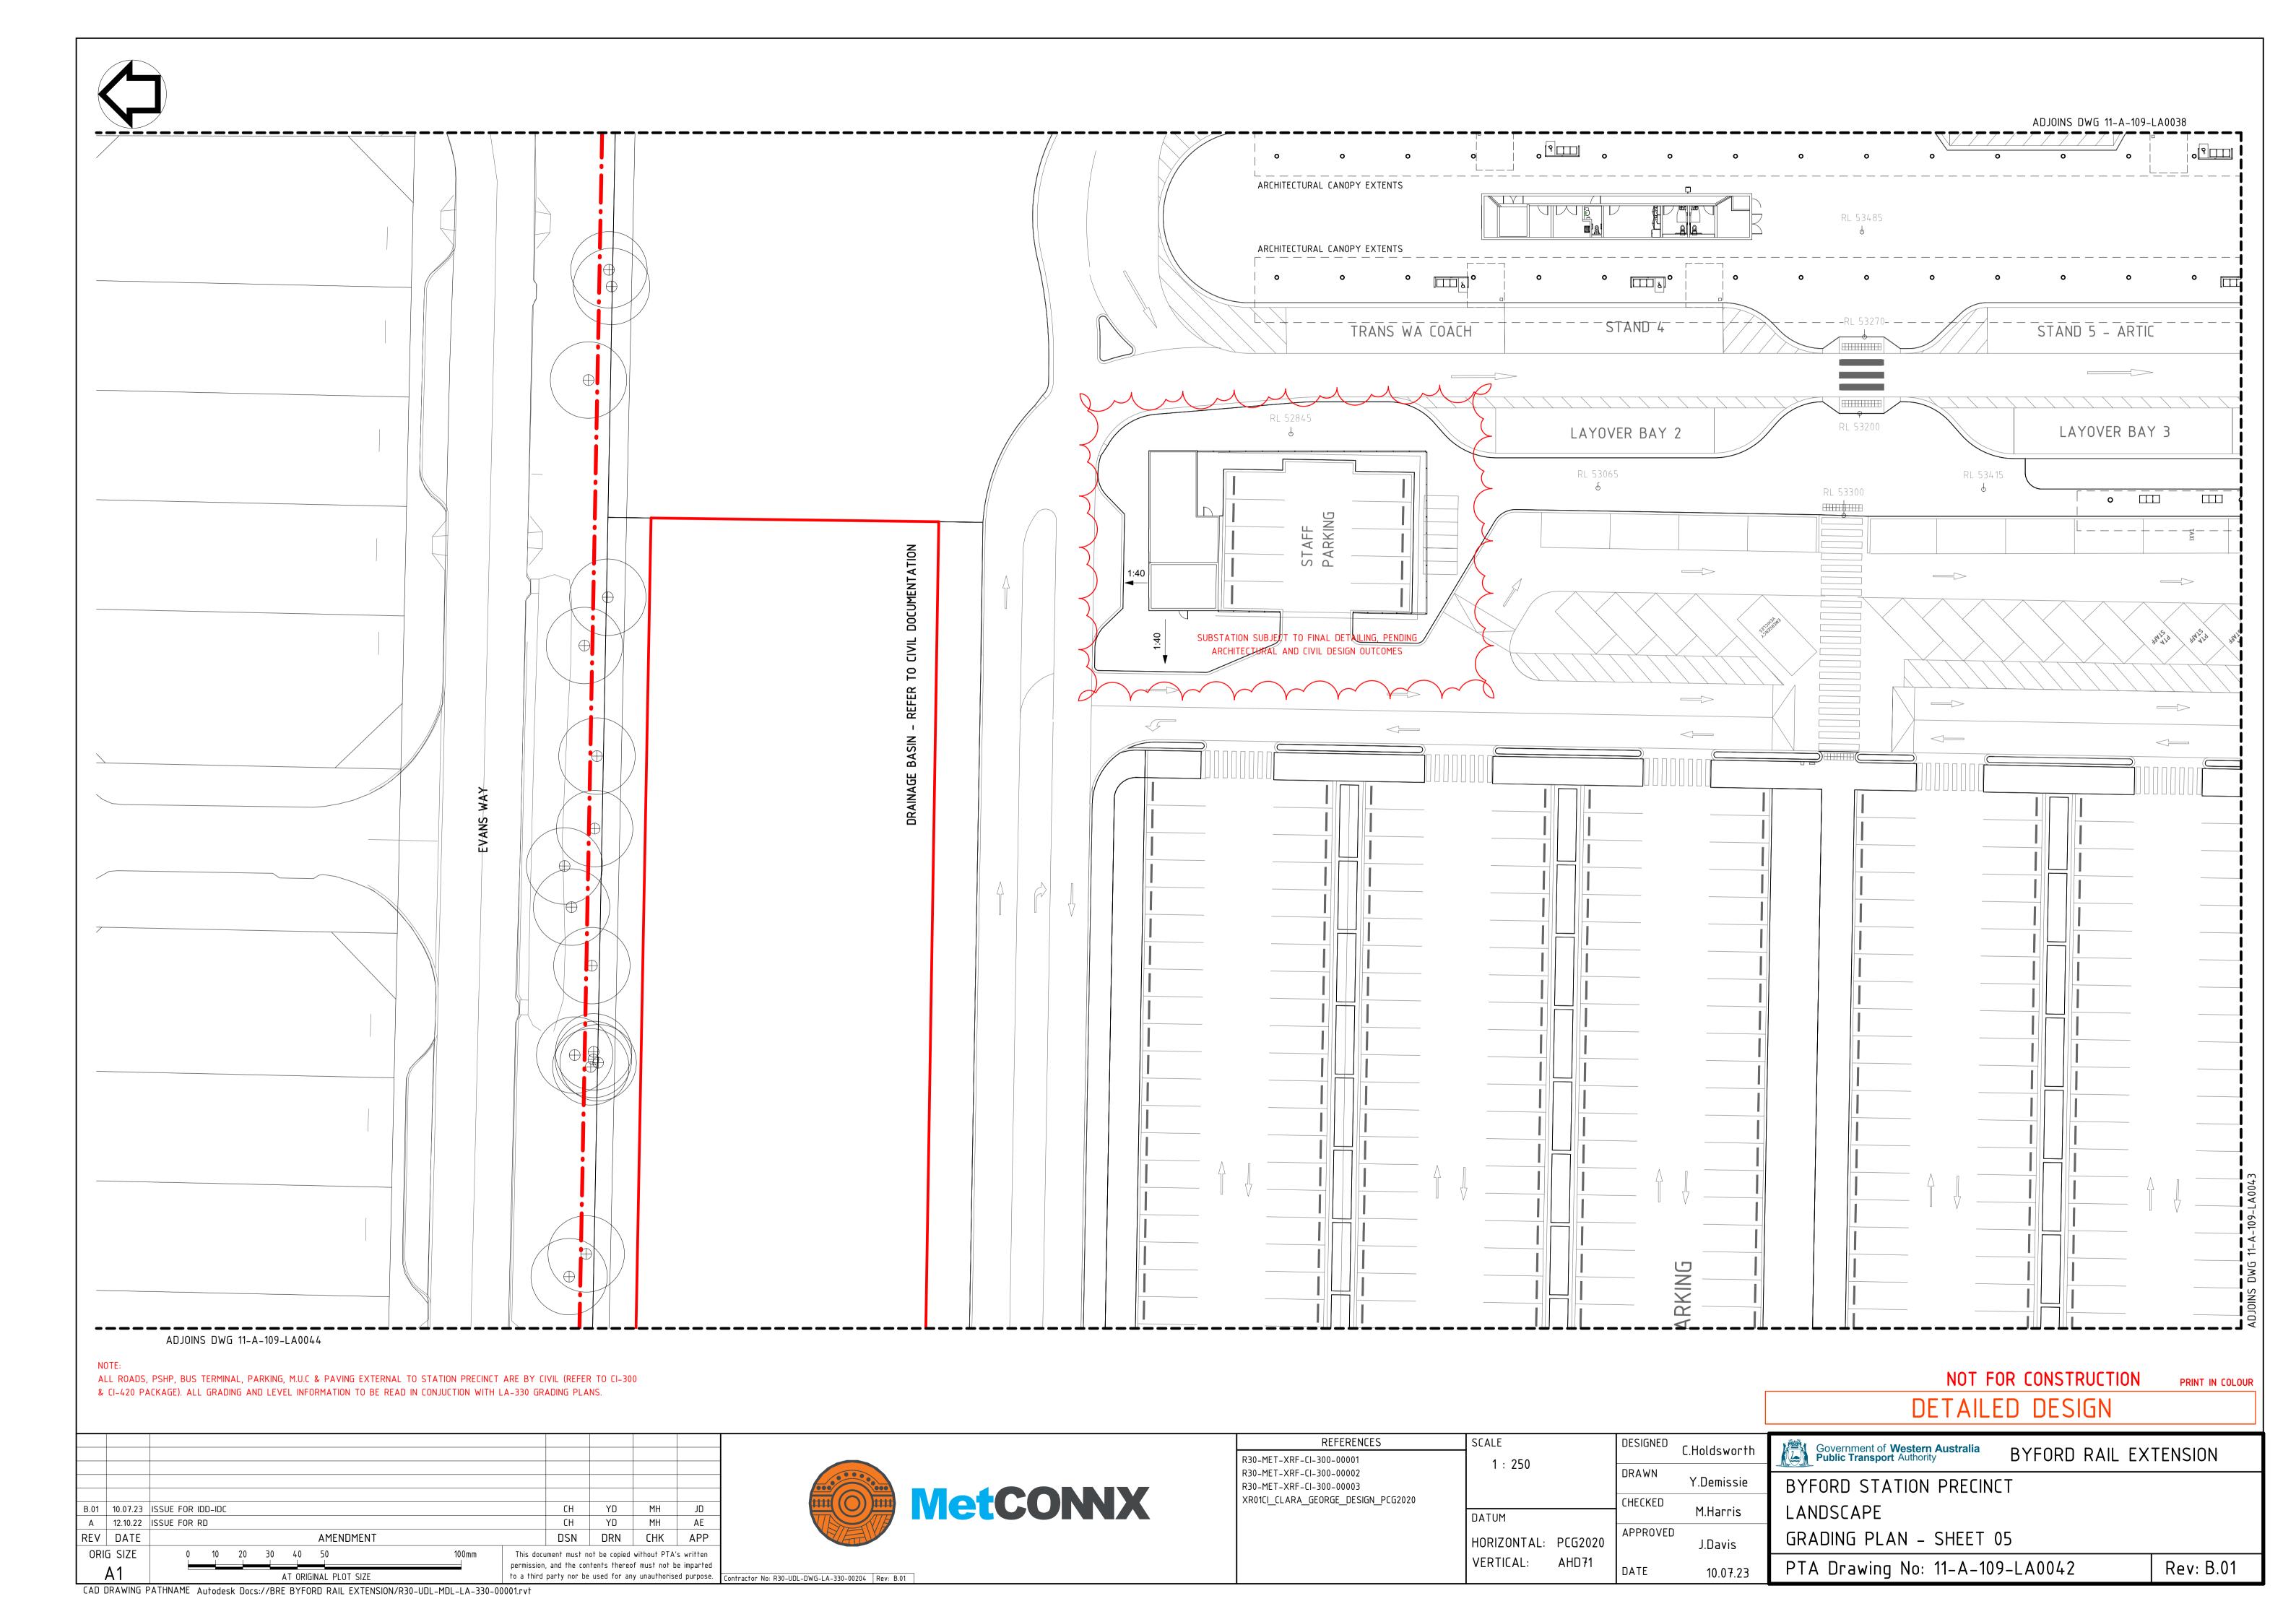








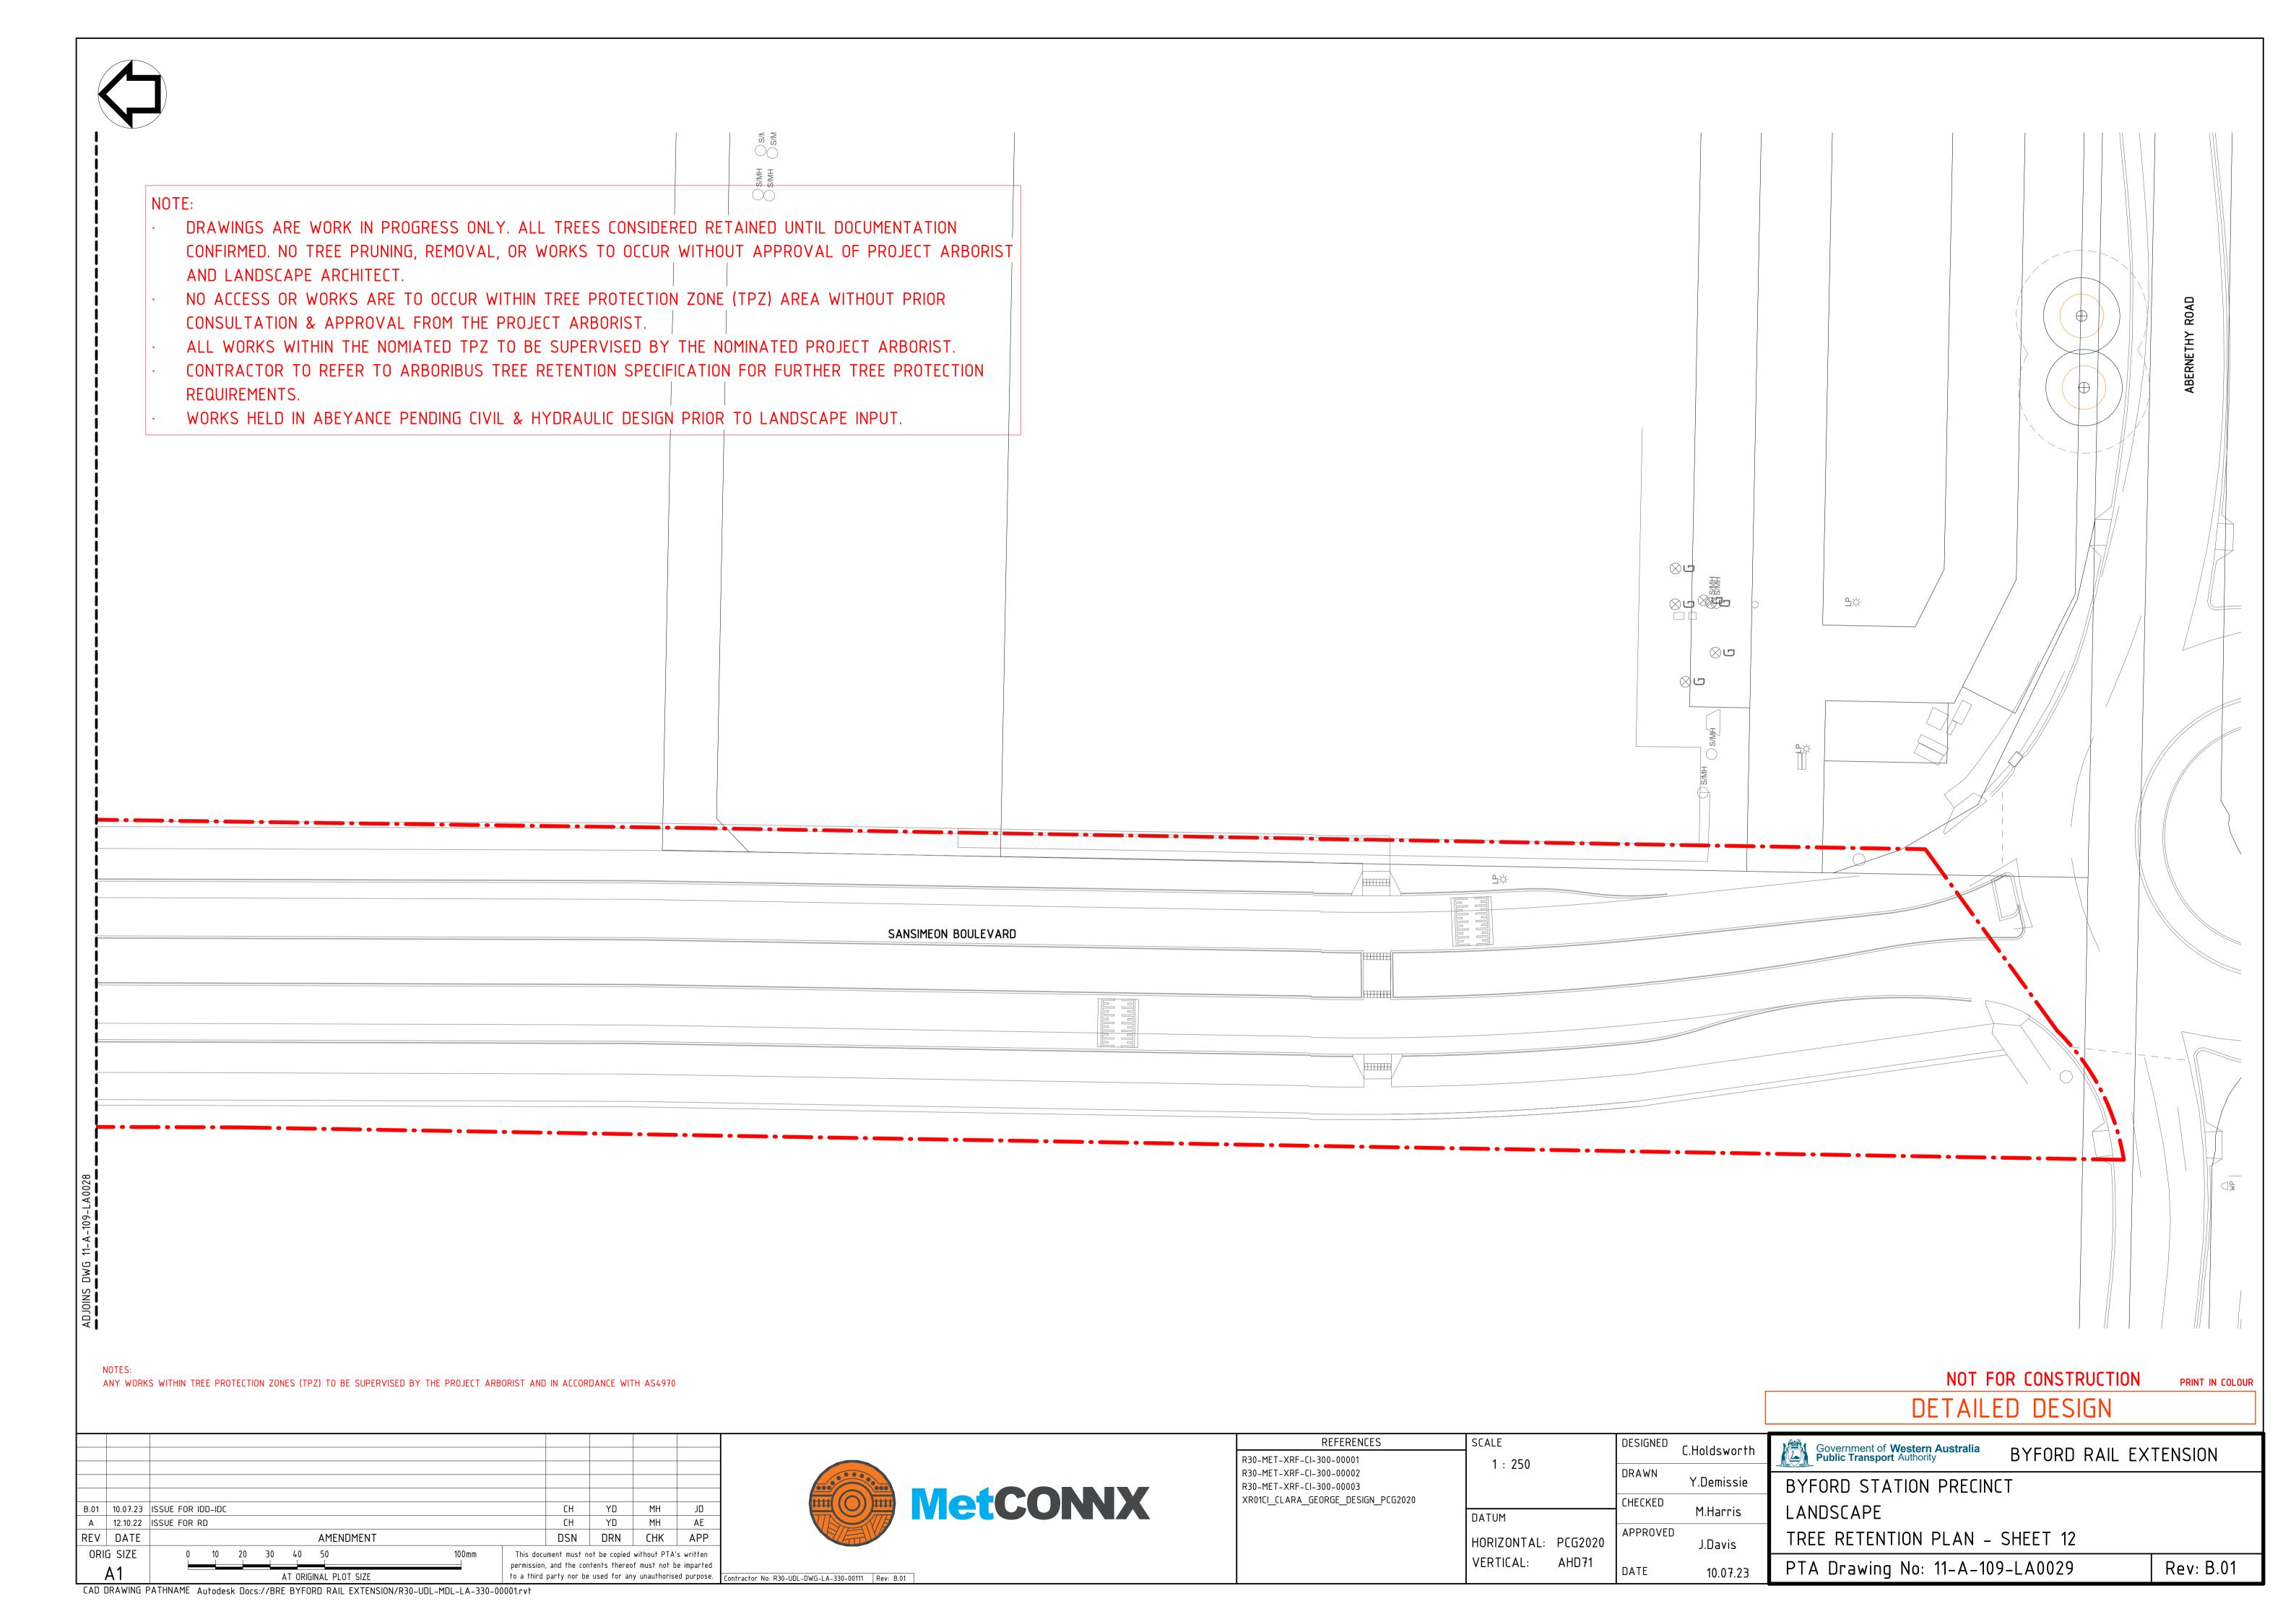


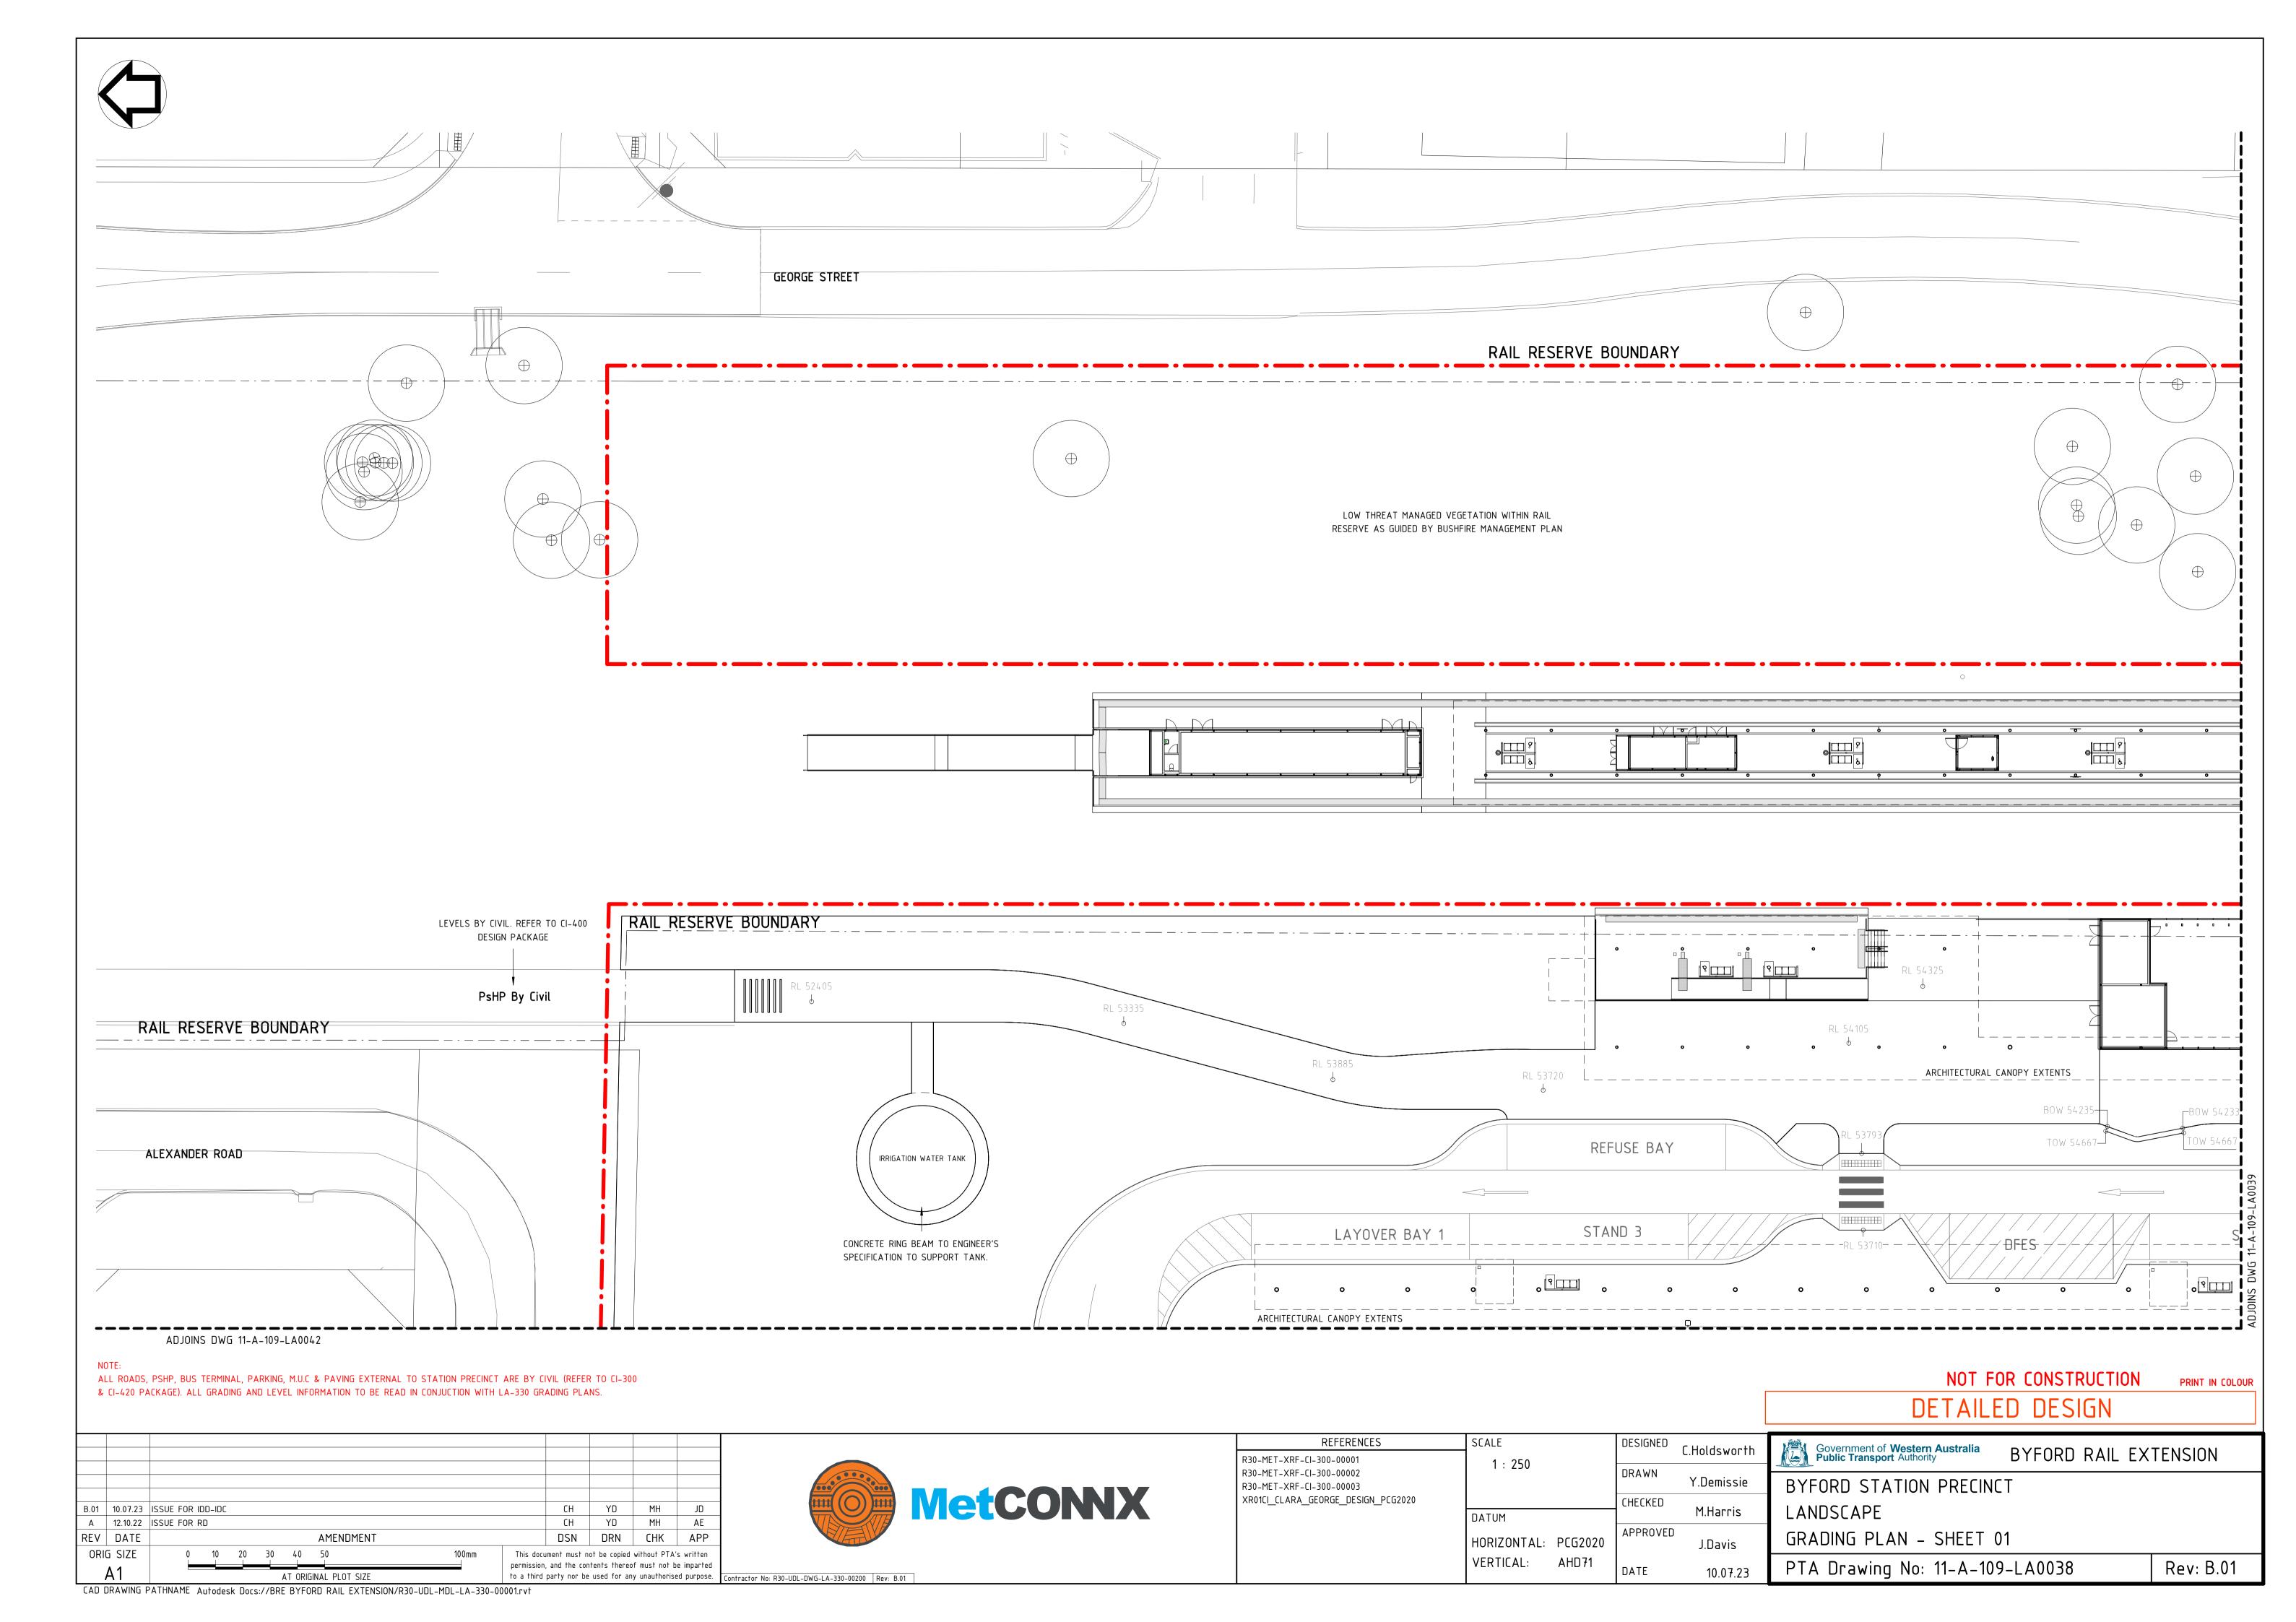


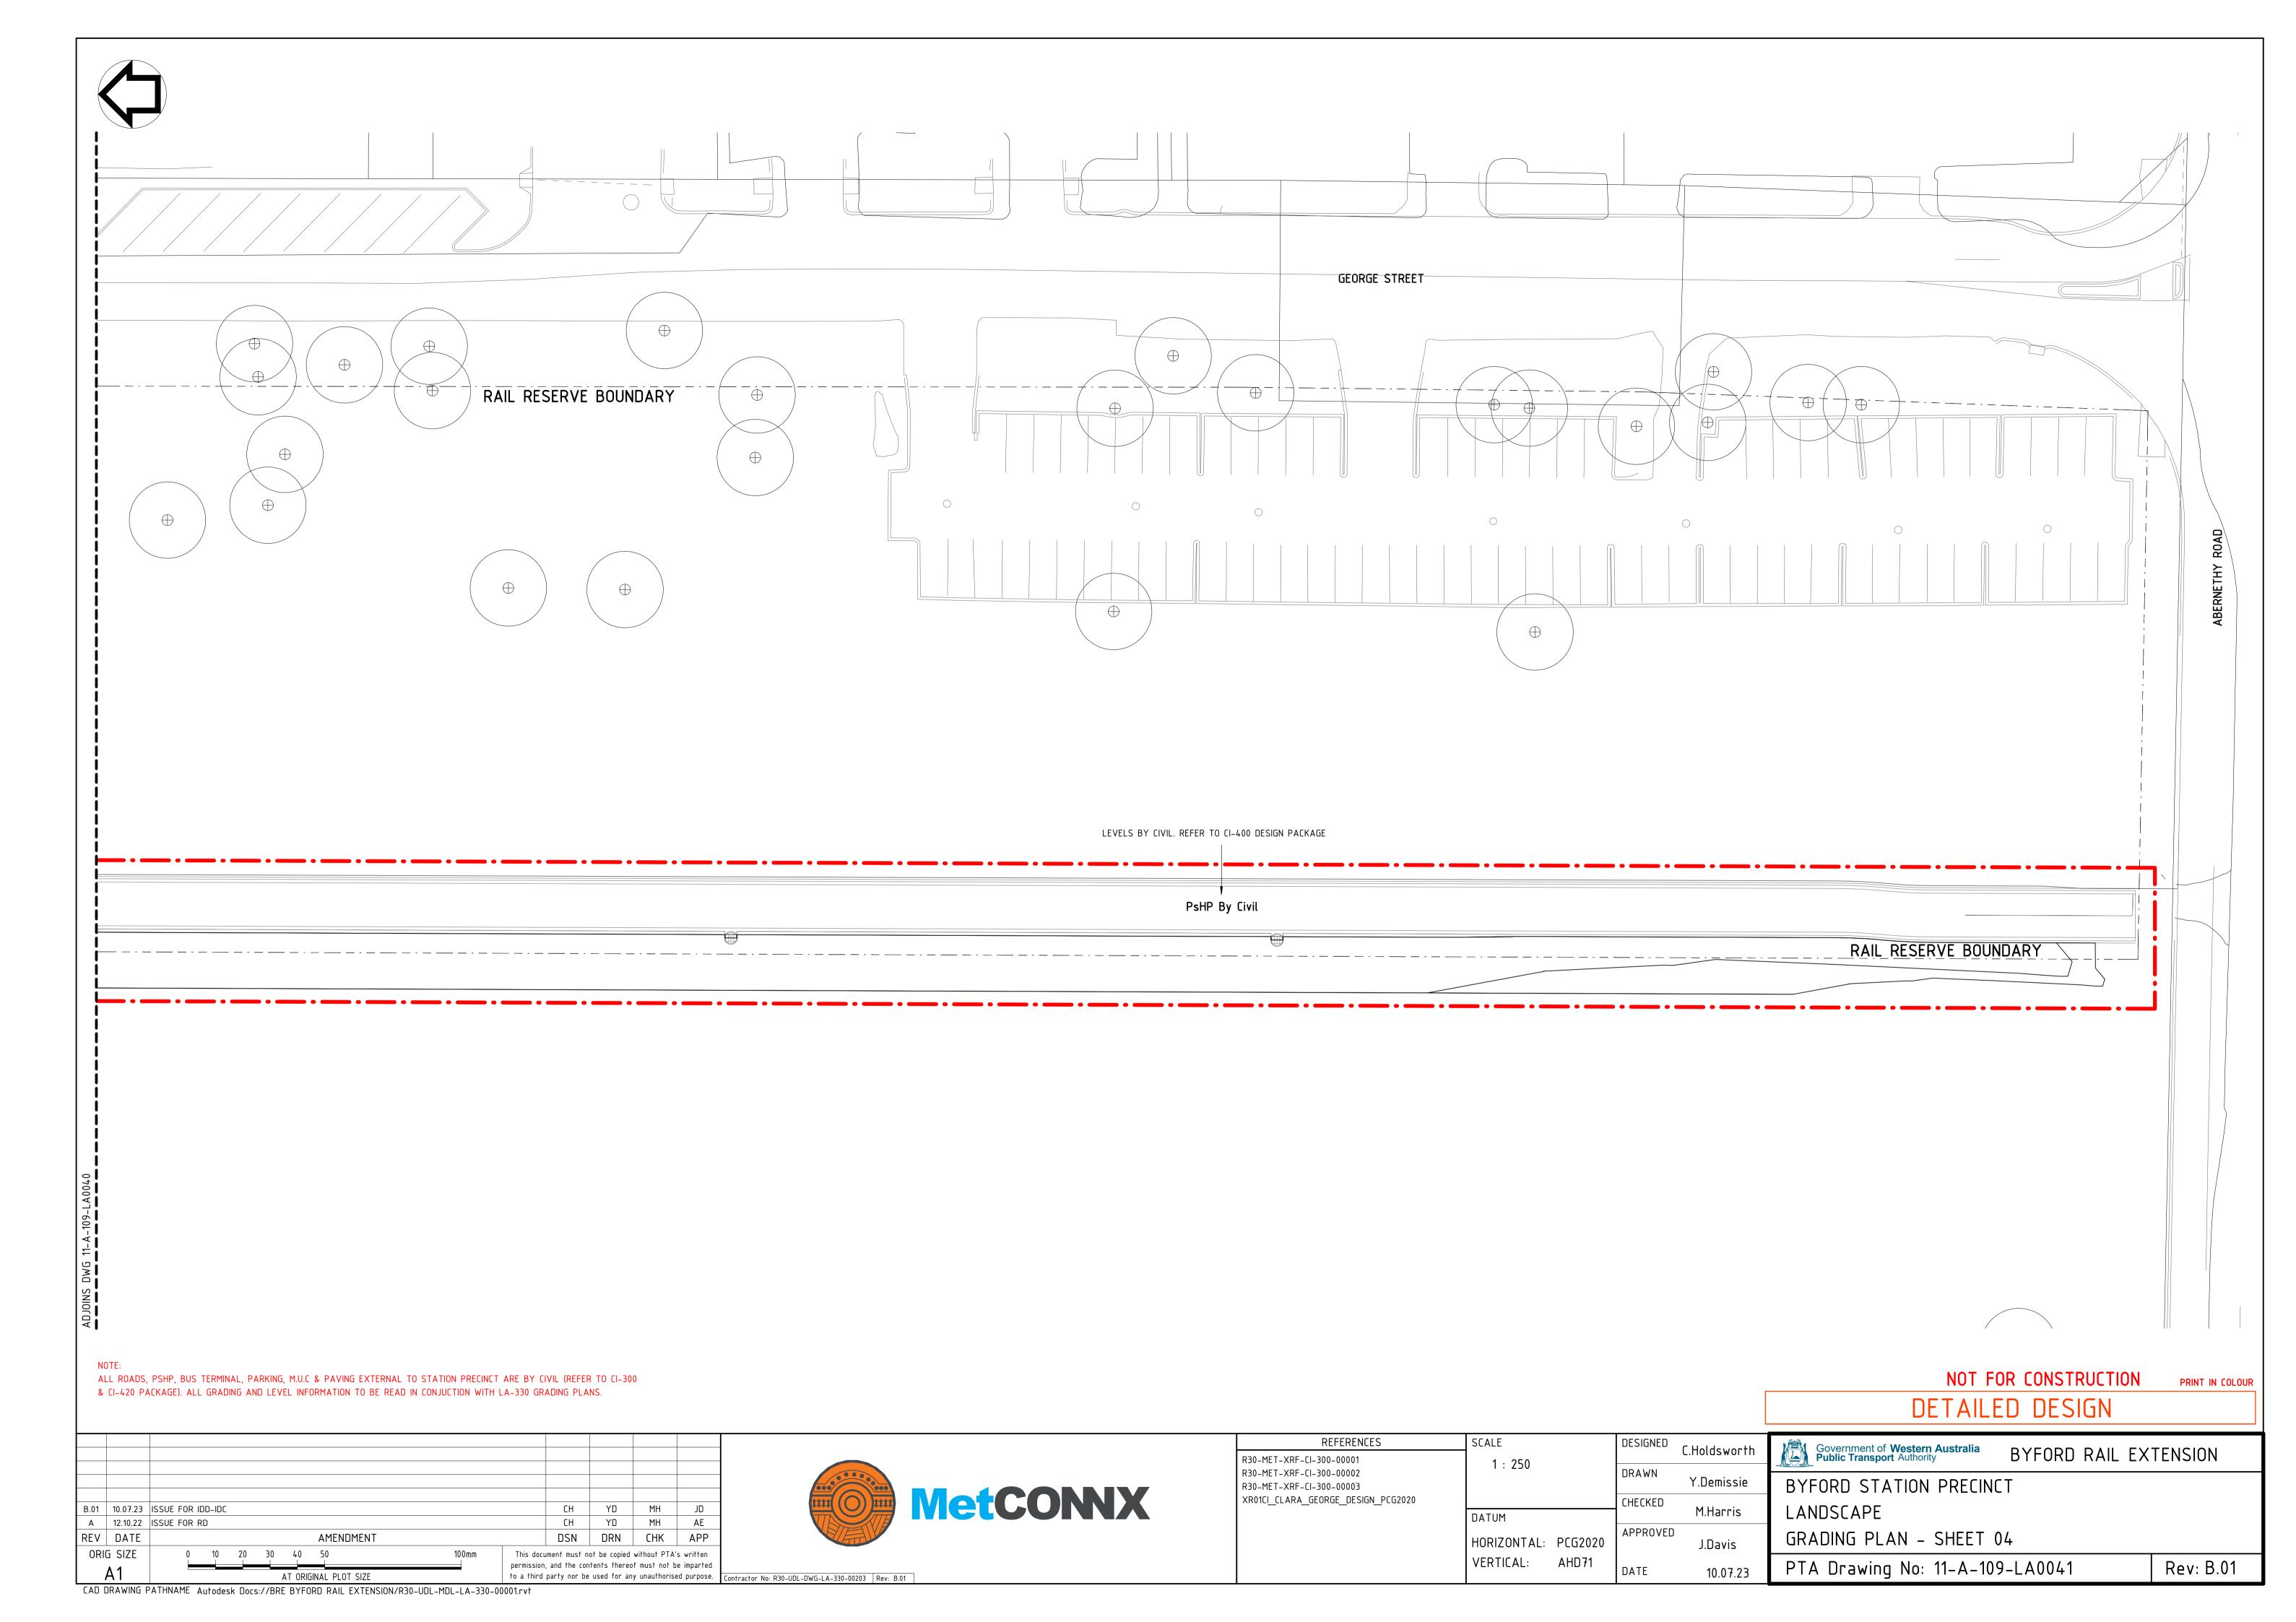


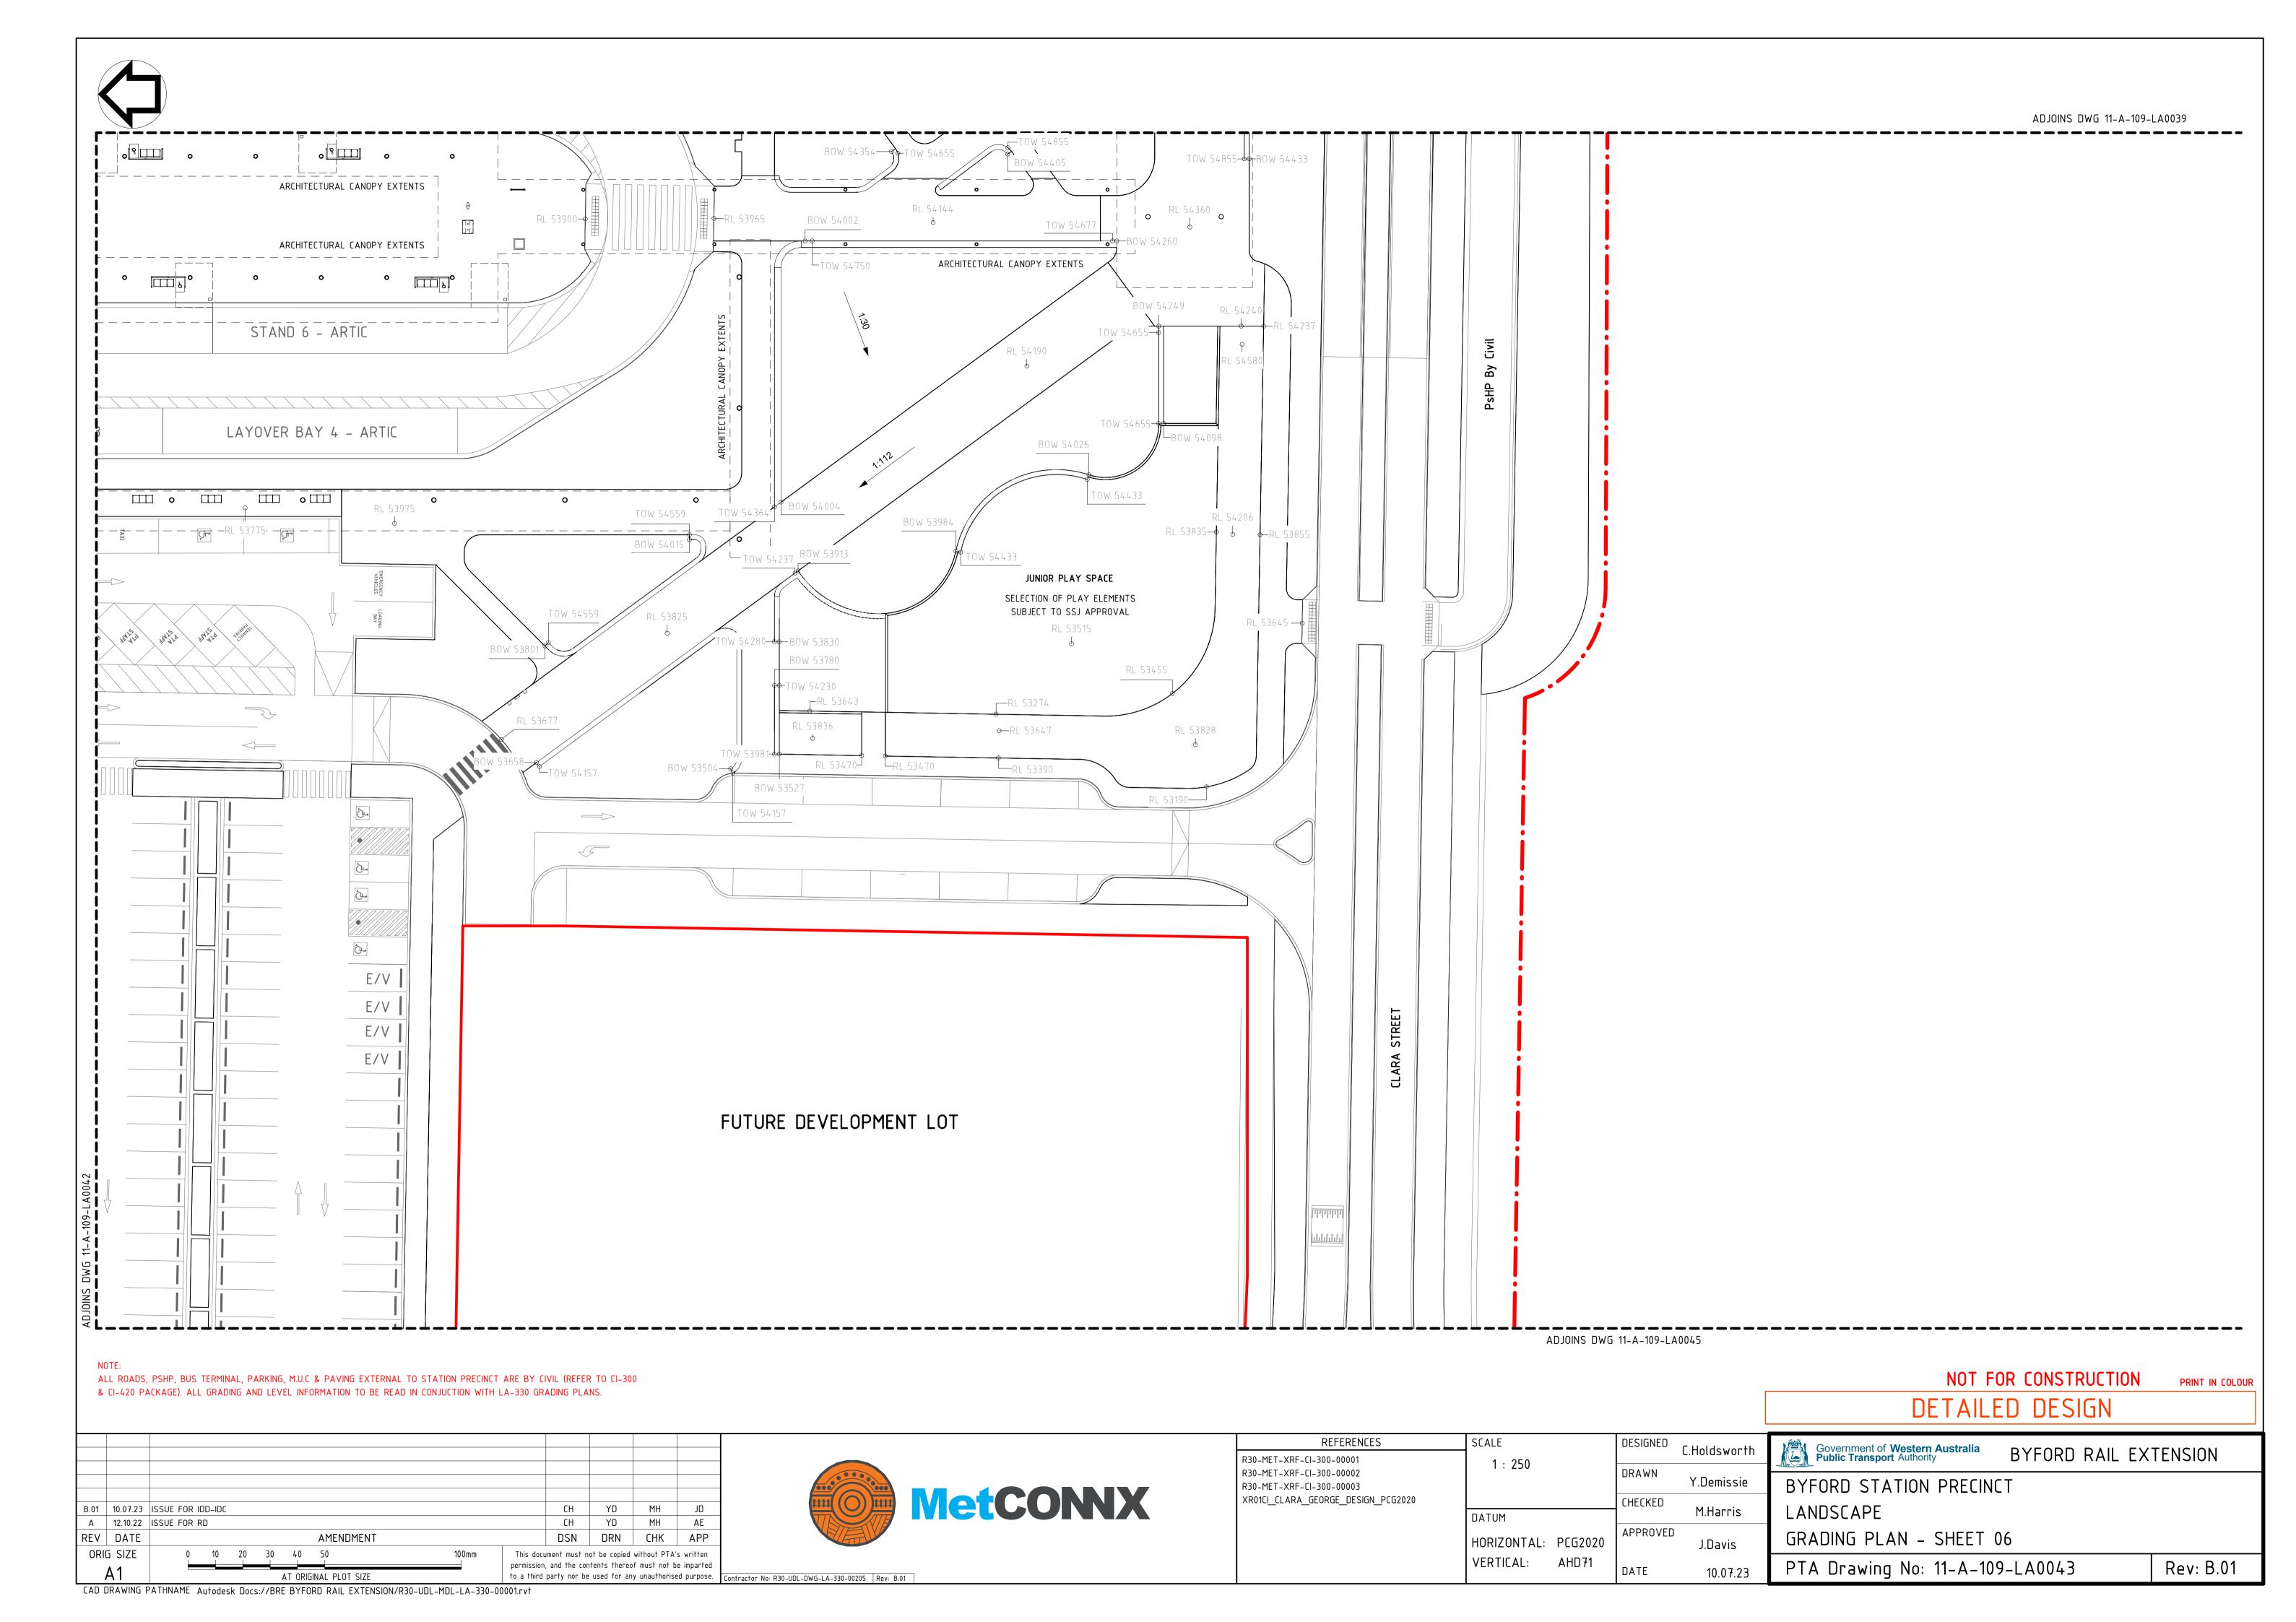

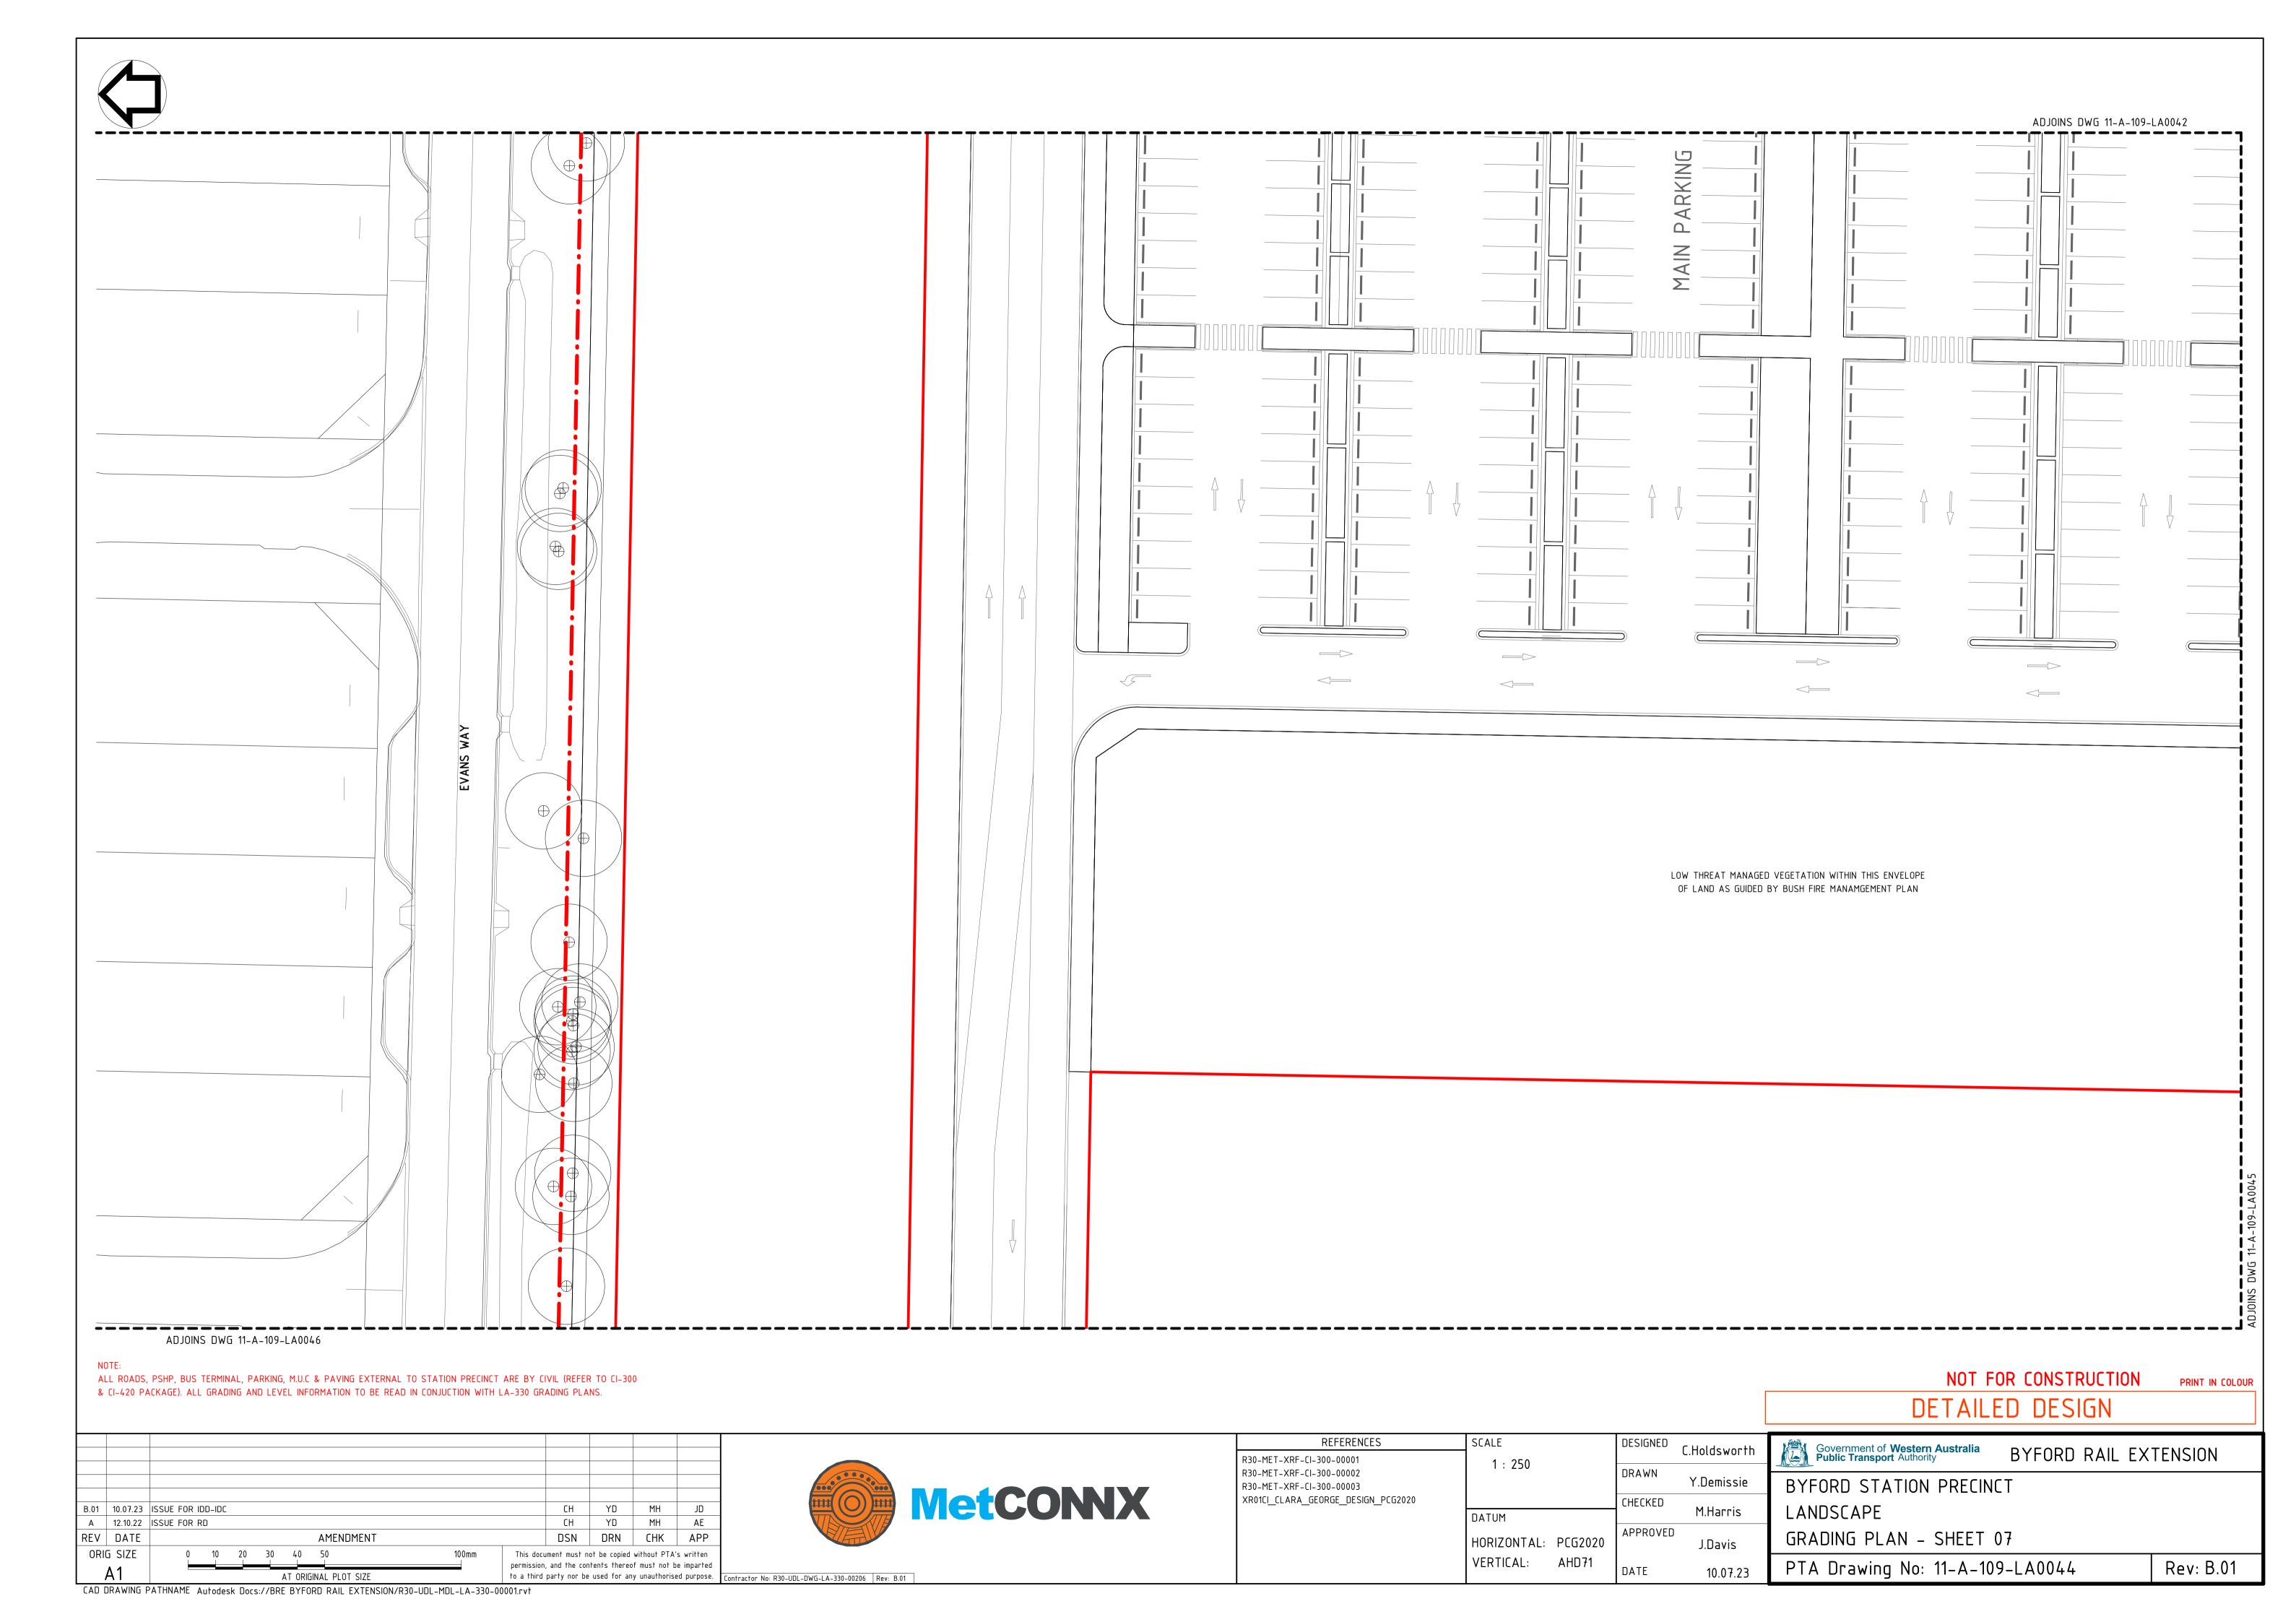


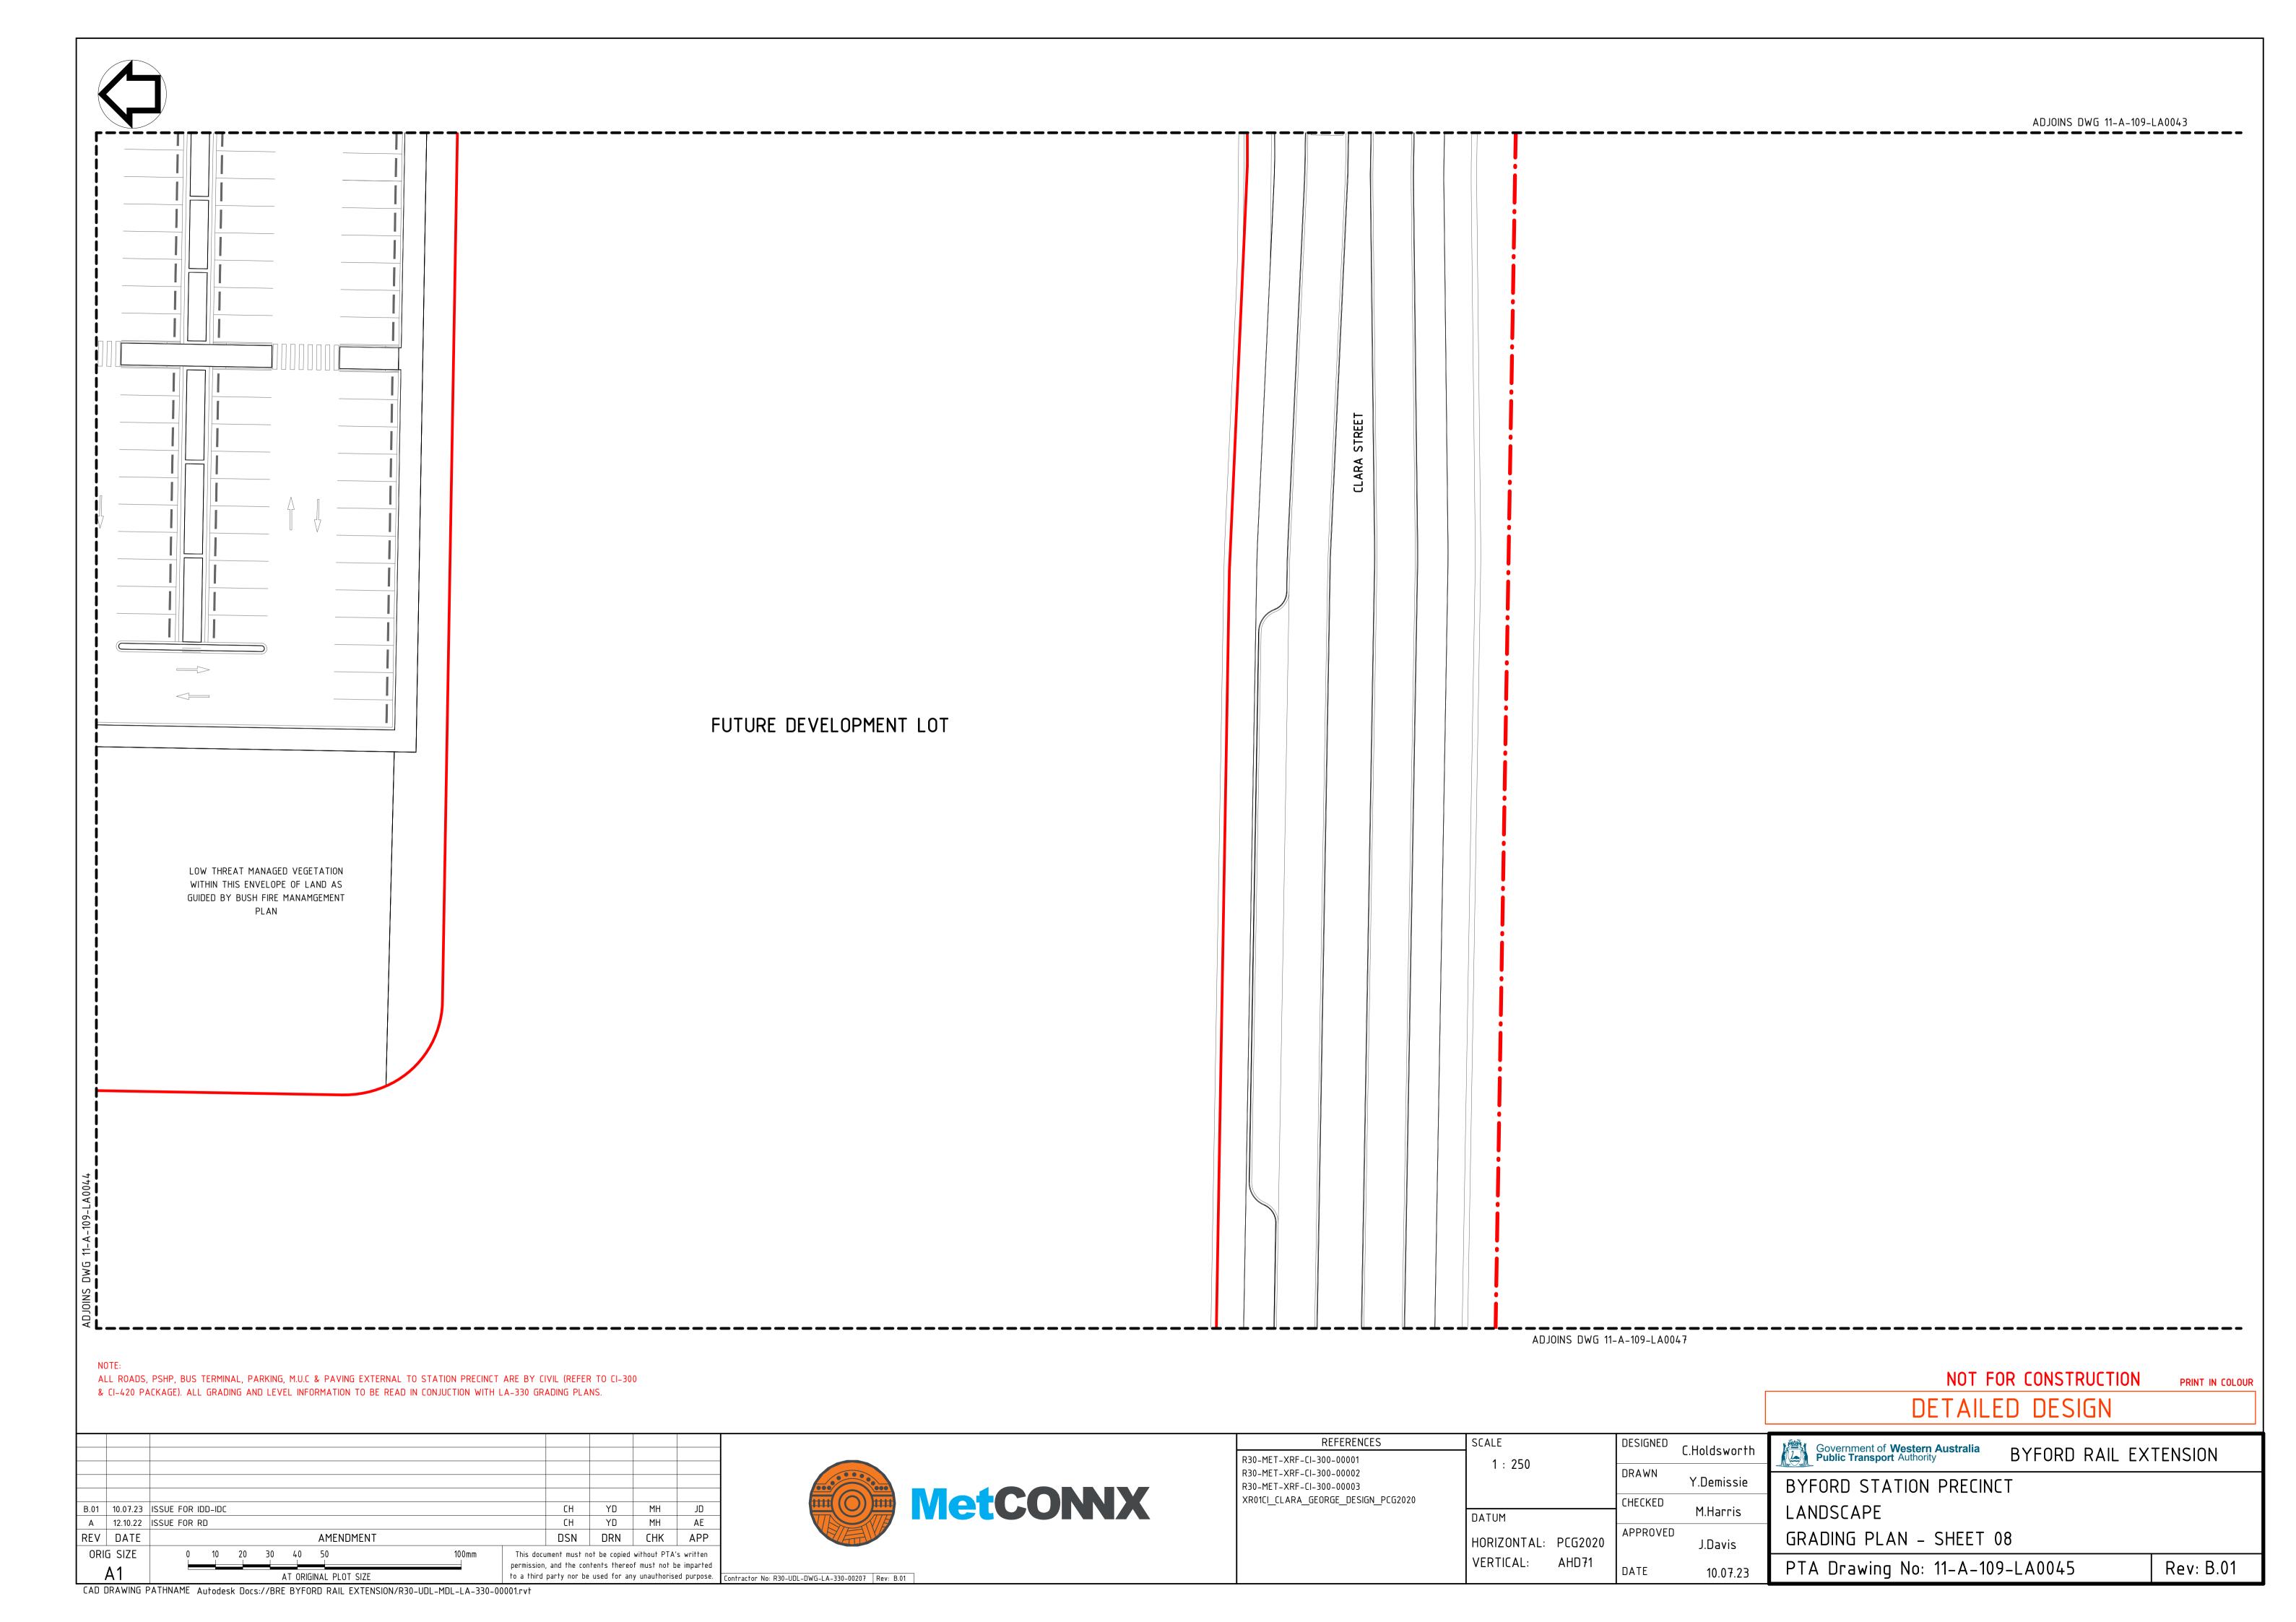


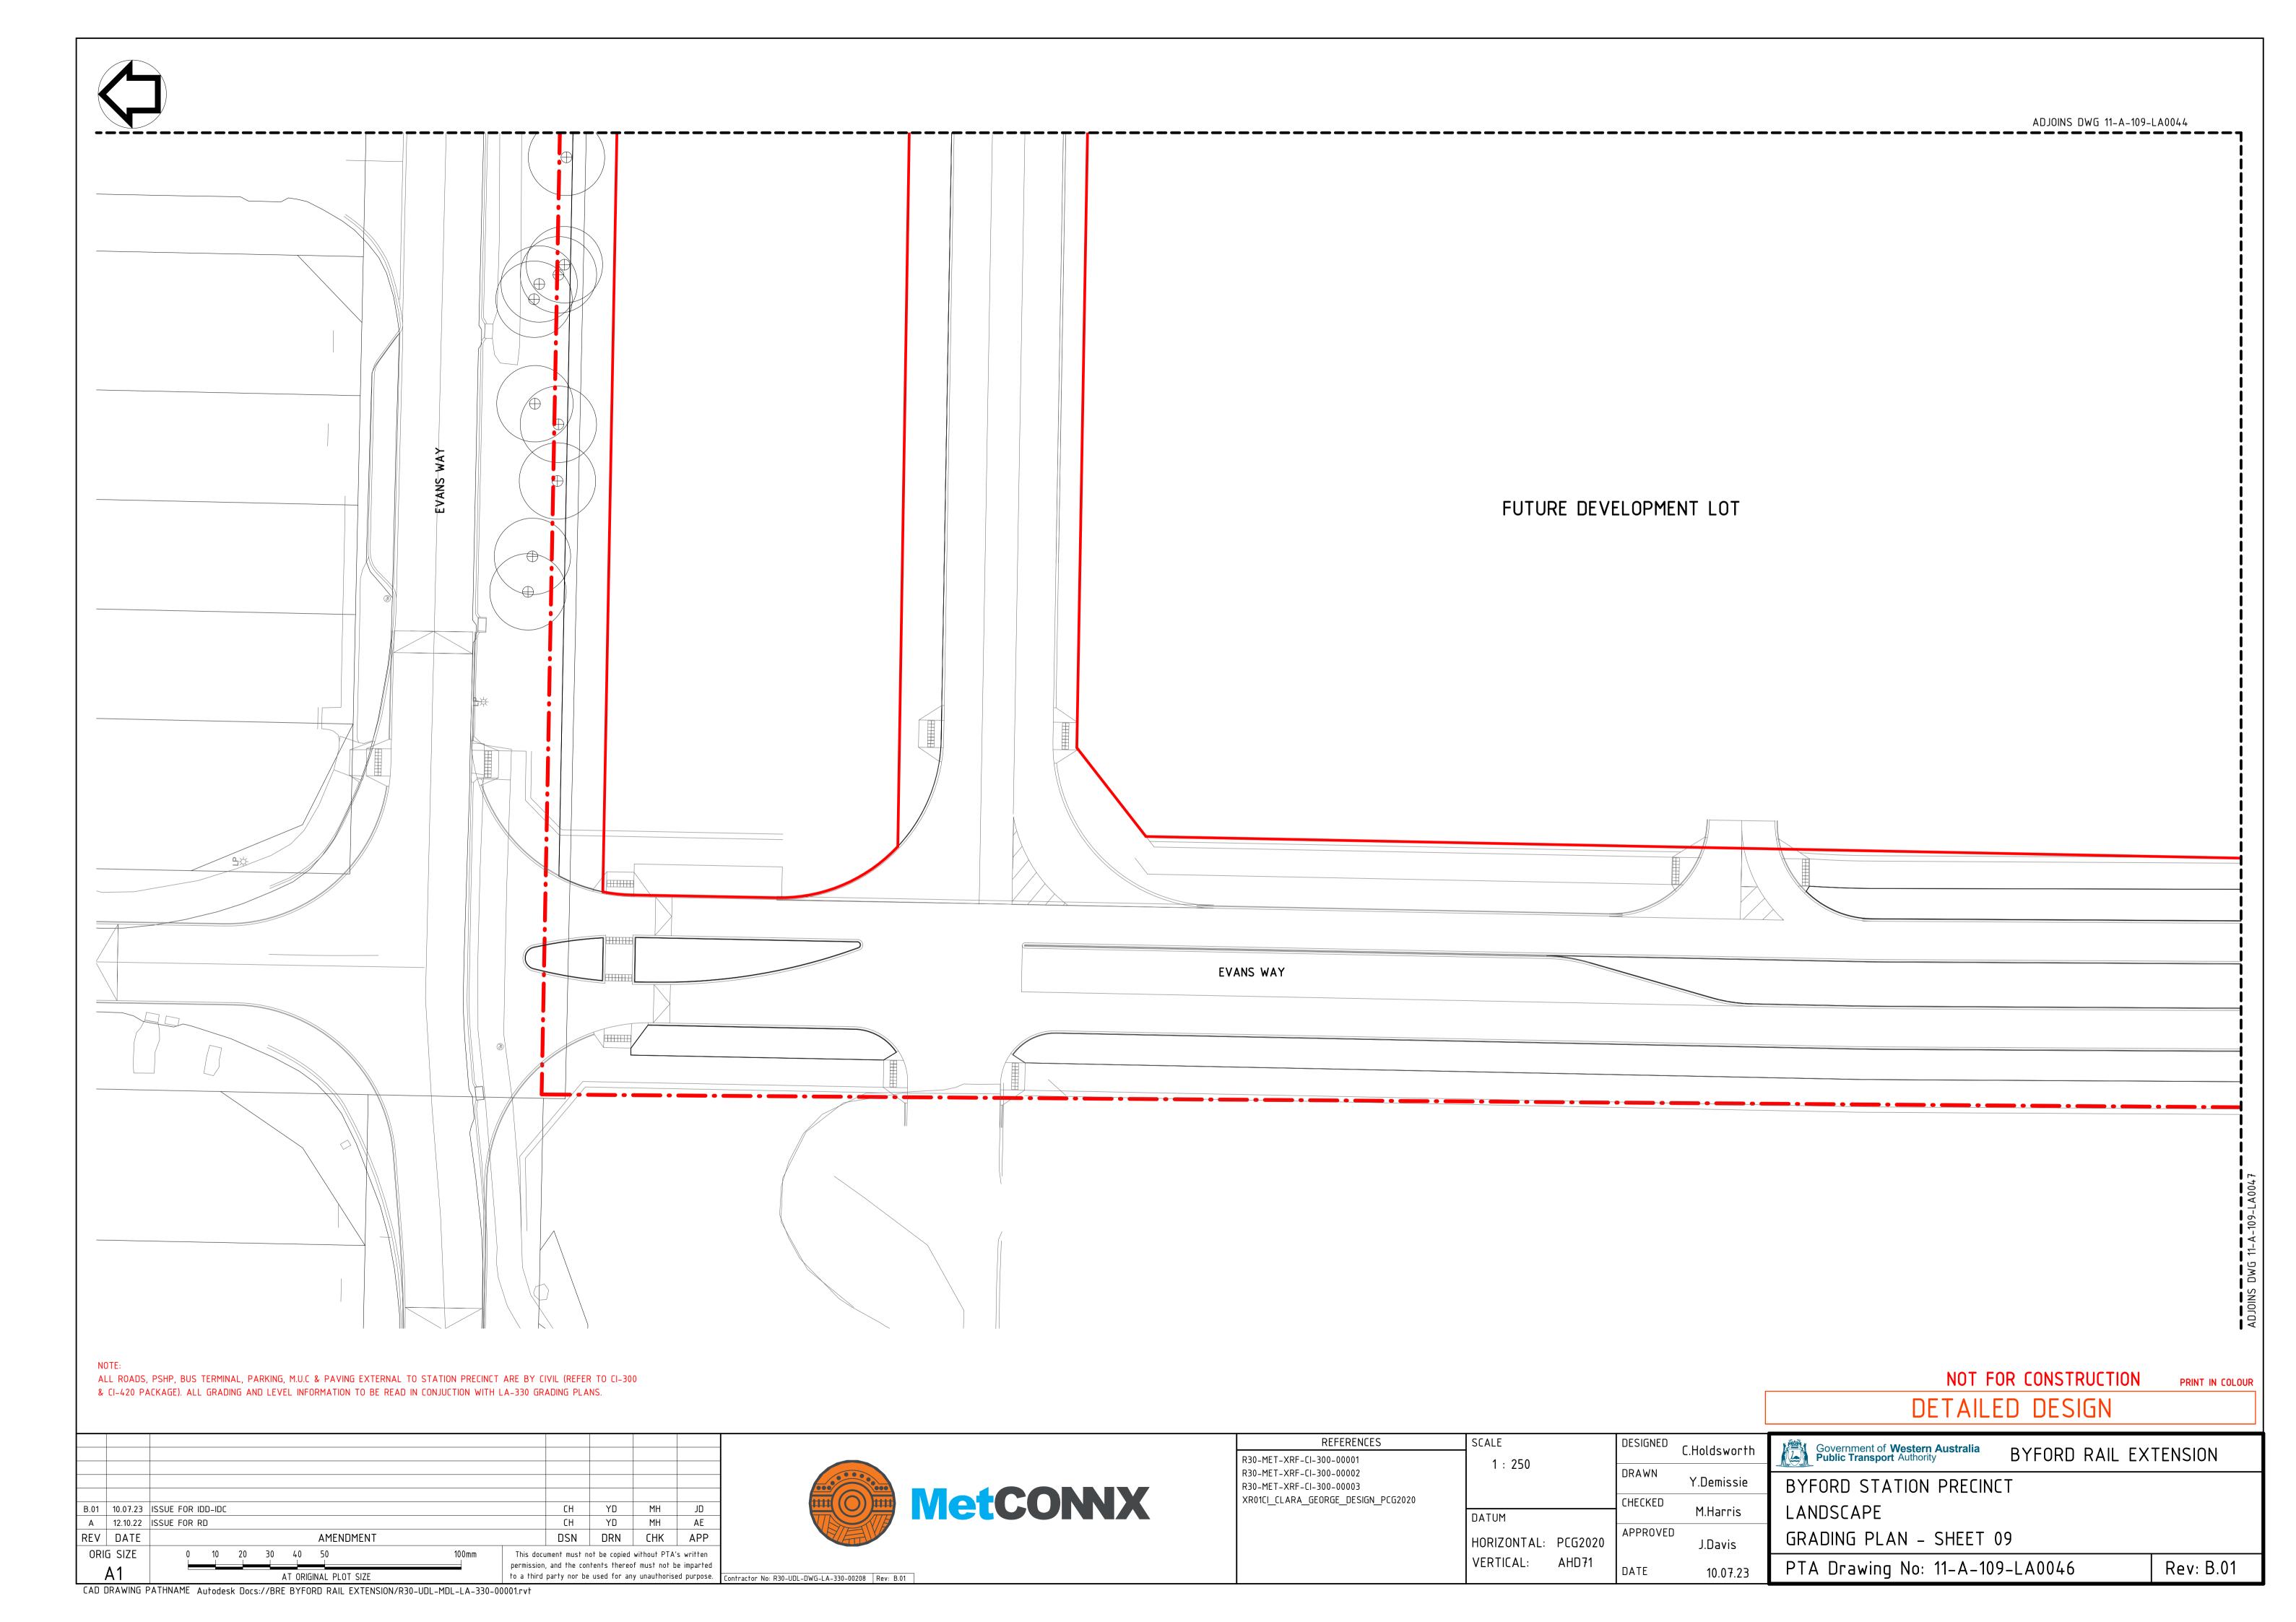


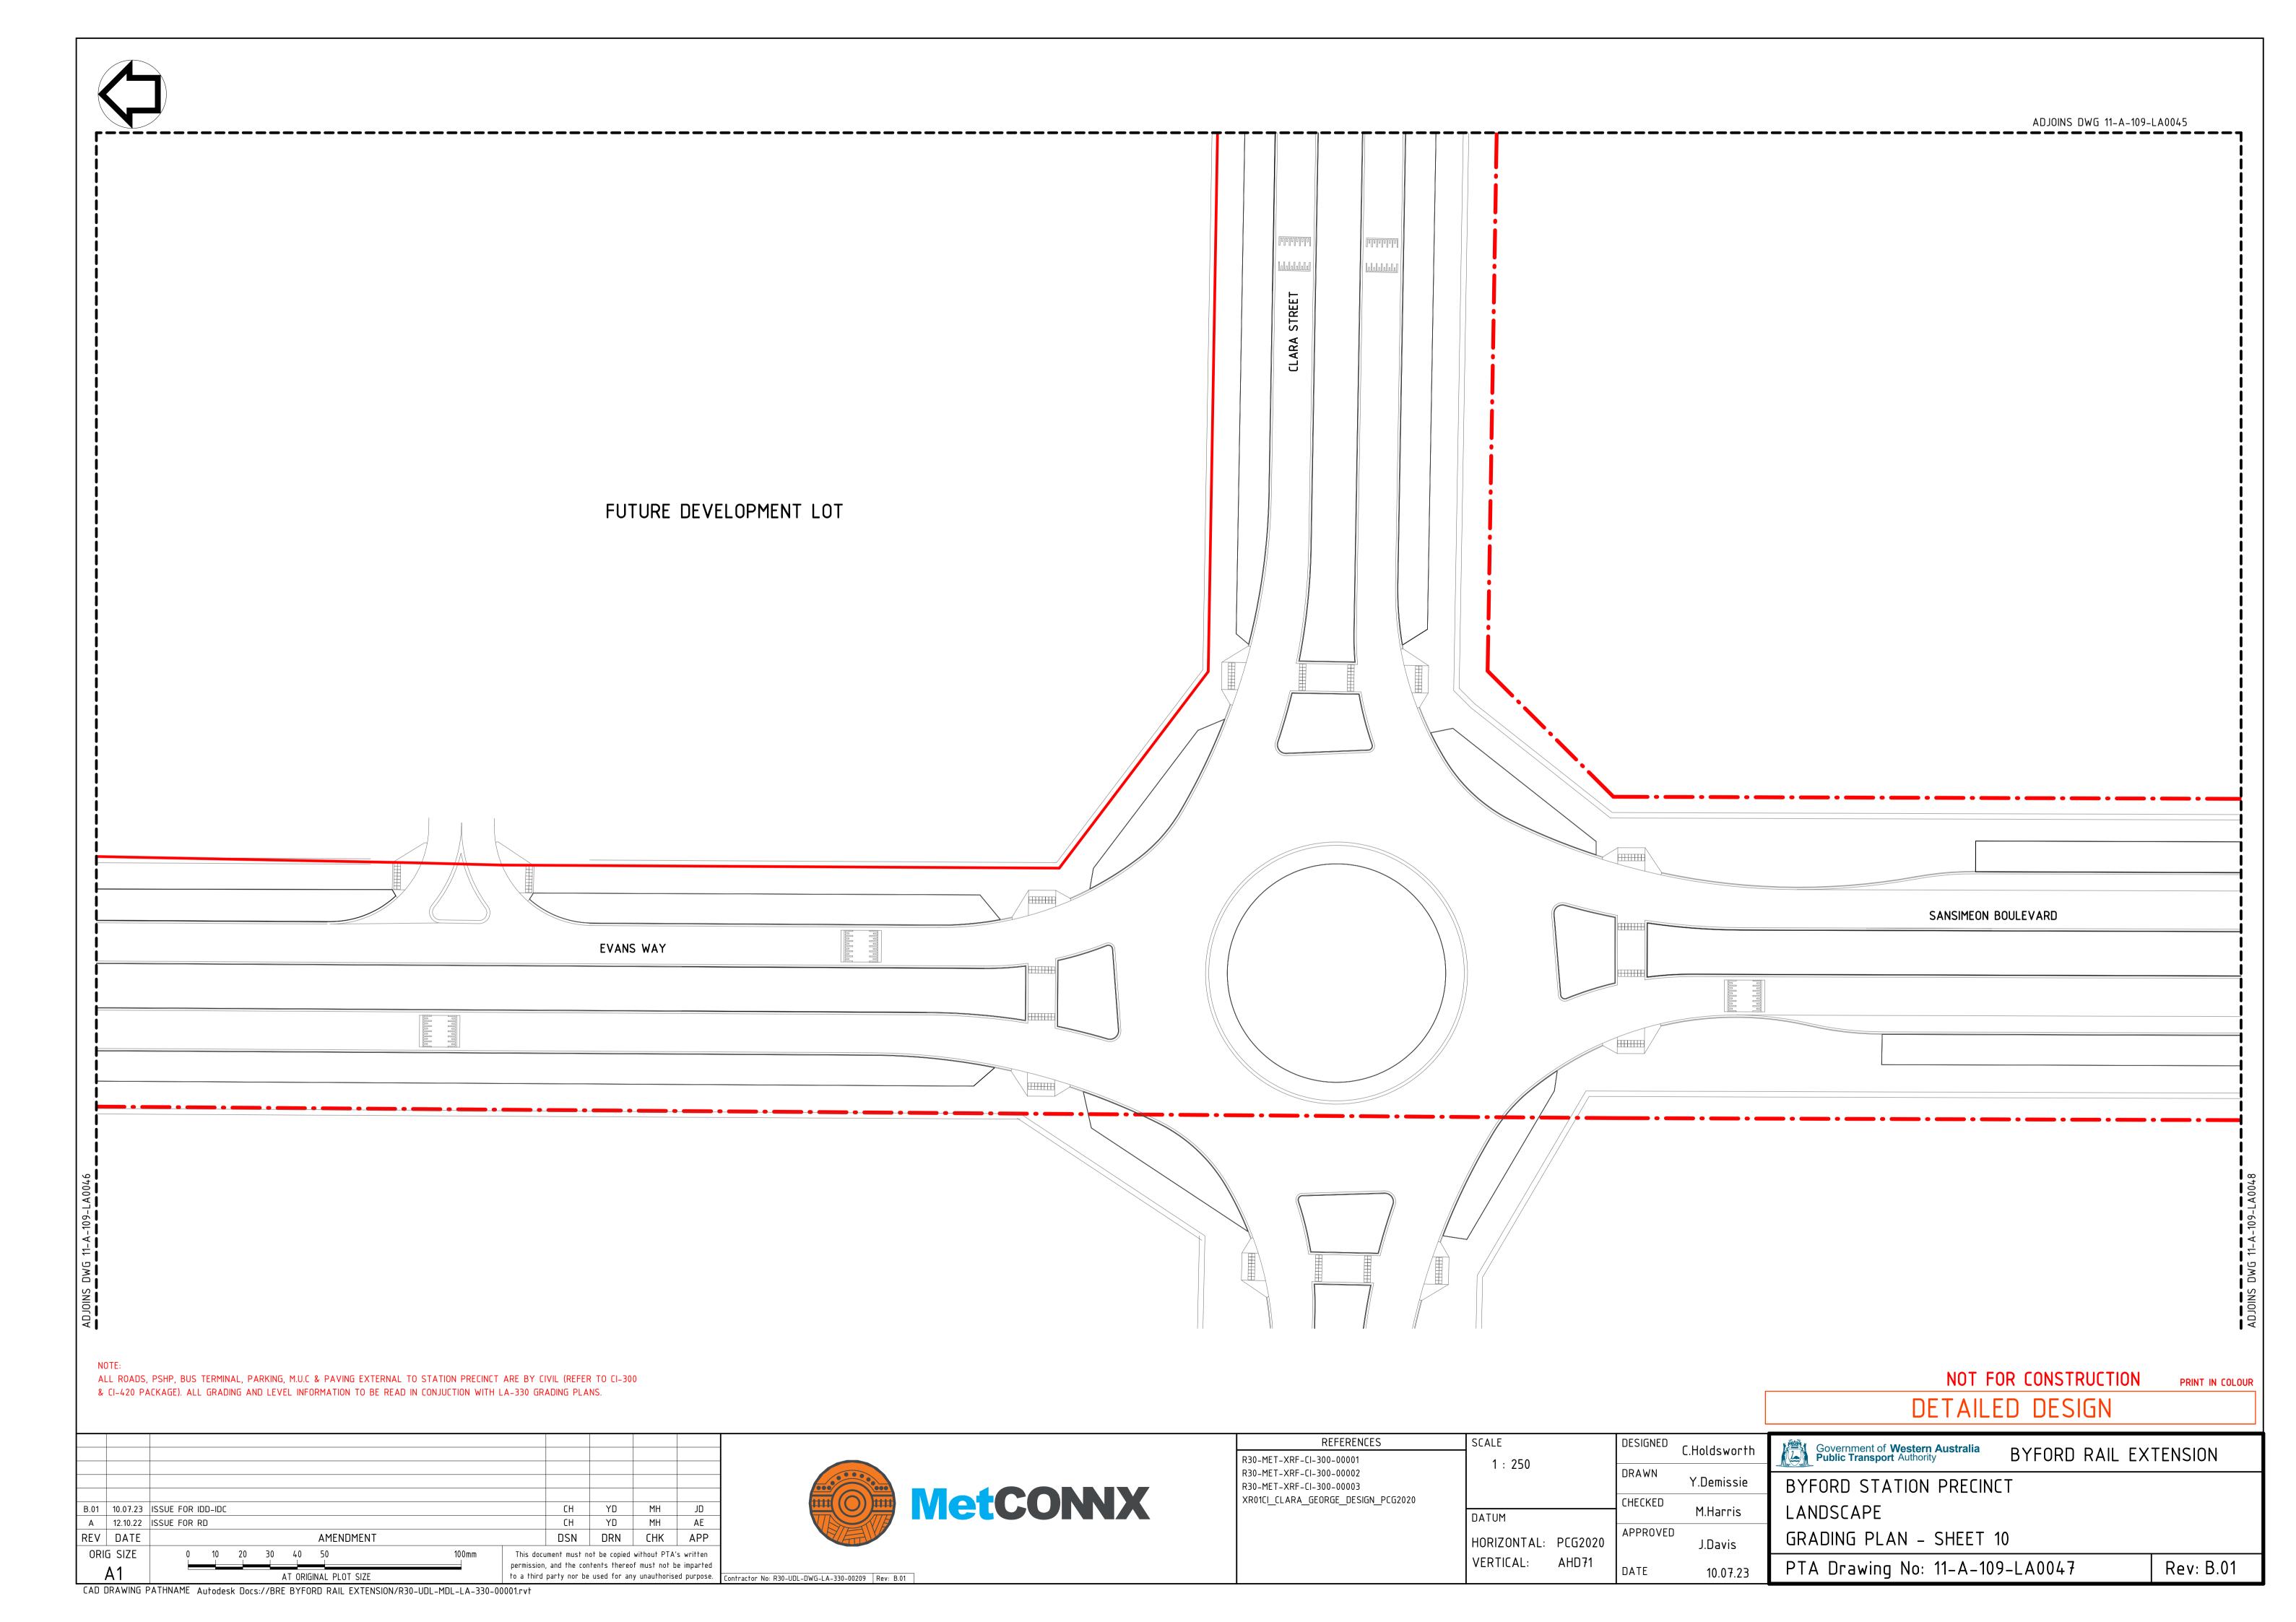



			<u> </u>
	SANSIMEON BOULEVARD		
27001			
ADJOINS DWG 11-A-109-LA			
NOTE: ALL ROADS, PSHP, BUS TERMINAL, PARKING, M.U.C & PAVING EXTERNAL TO STATION PRECINCT ARE BY CIVIL (REFER TO CI-300 & CI-420 PACKAGE). ALL GRADING AND LEVEL INFORMATION TO BE READ IN CONJUCTION WITH LA-330 GRADING PLANS.	REFERENCES	SCALE DESIGNED C.Holdswor	NOT FOR CONSTRUCTION PRINT IN COLOUR DETAILED DESIGN
B.01 10.07.23 ISSUE FOR IDD-IDC A 12.10.22 ISSUE FOR RD CH YD MH JD A 12.10.22 ISSUE FOR RD CH YD MH AE REV DATE AMENDMENT ORIG SIZE A1 ORIGINAL PLOT SIZE AT ORIGINAL PLOT SIZE AT ORIGINAL PLOT SIZE O a third party nor be used for any unauthorised purpose. Contractor No: R30-UDL-DWG-LA-330-00210 Rev: B.01	R30-MET-XRF-CI-300-00001 R30-MET-XRF-CI-300-00002 R30-MET-XRF-CI-300-00003 XR01CI_CLARA_GEORGE_DESIGN_PCG2020	1: 250 DRAWN Y.Demissi CHECKED M.Harris HORIZONTAL: PCG2020 VERTICAL: AHD71 DATE 10.07.2	BYFORD STATION PRECINCT LANDSCAPE GRADING PLAN - SHEET 11

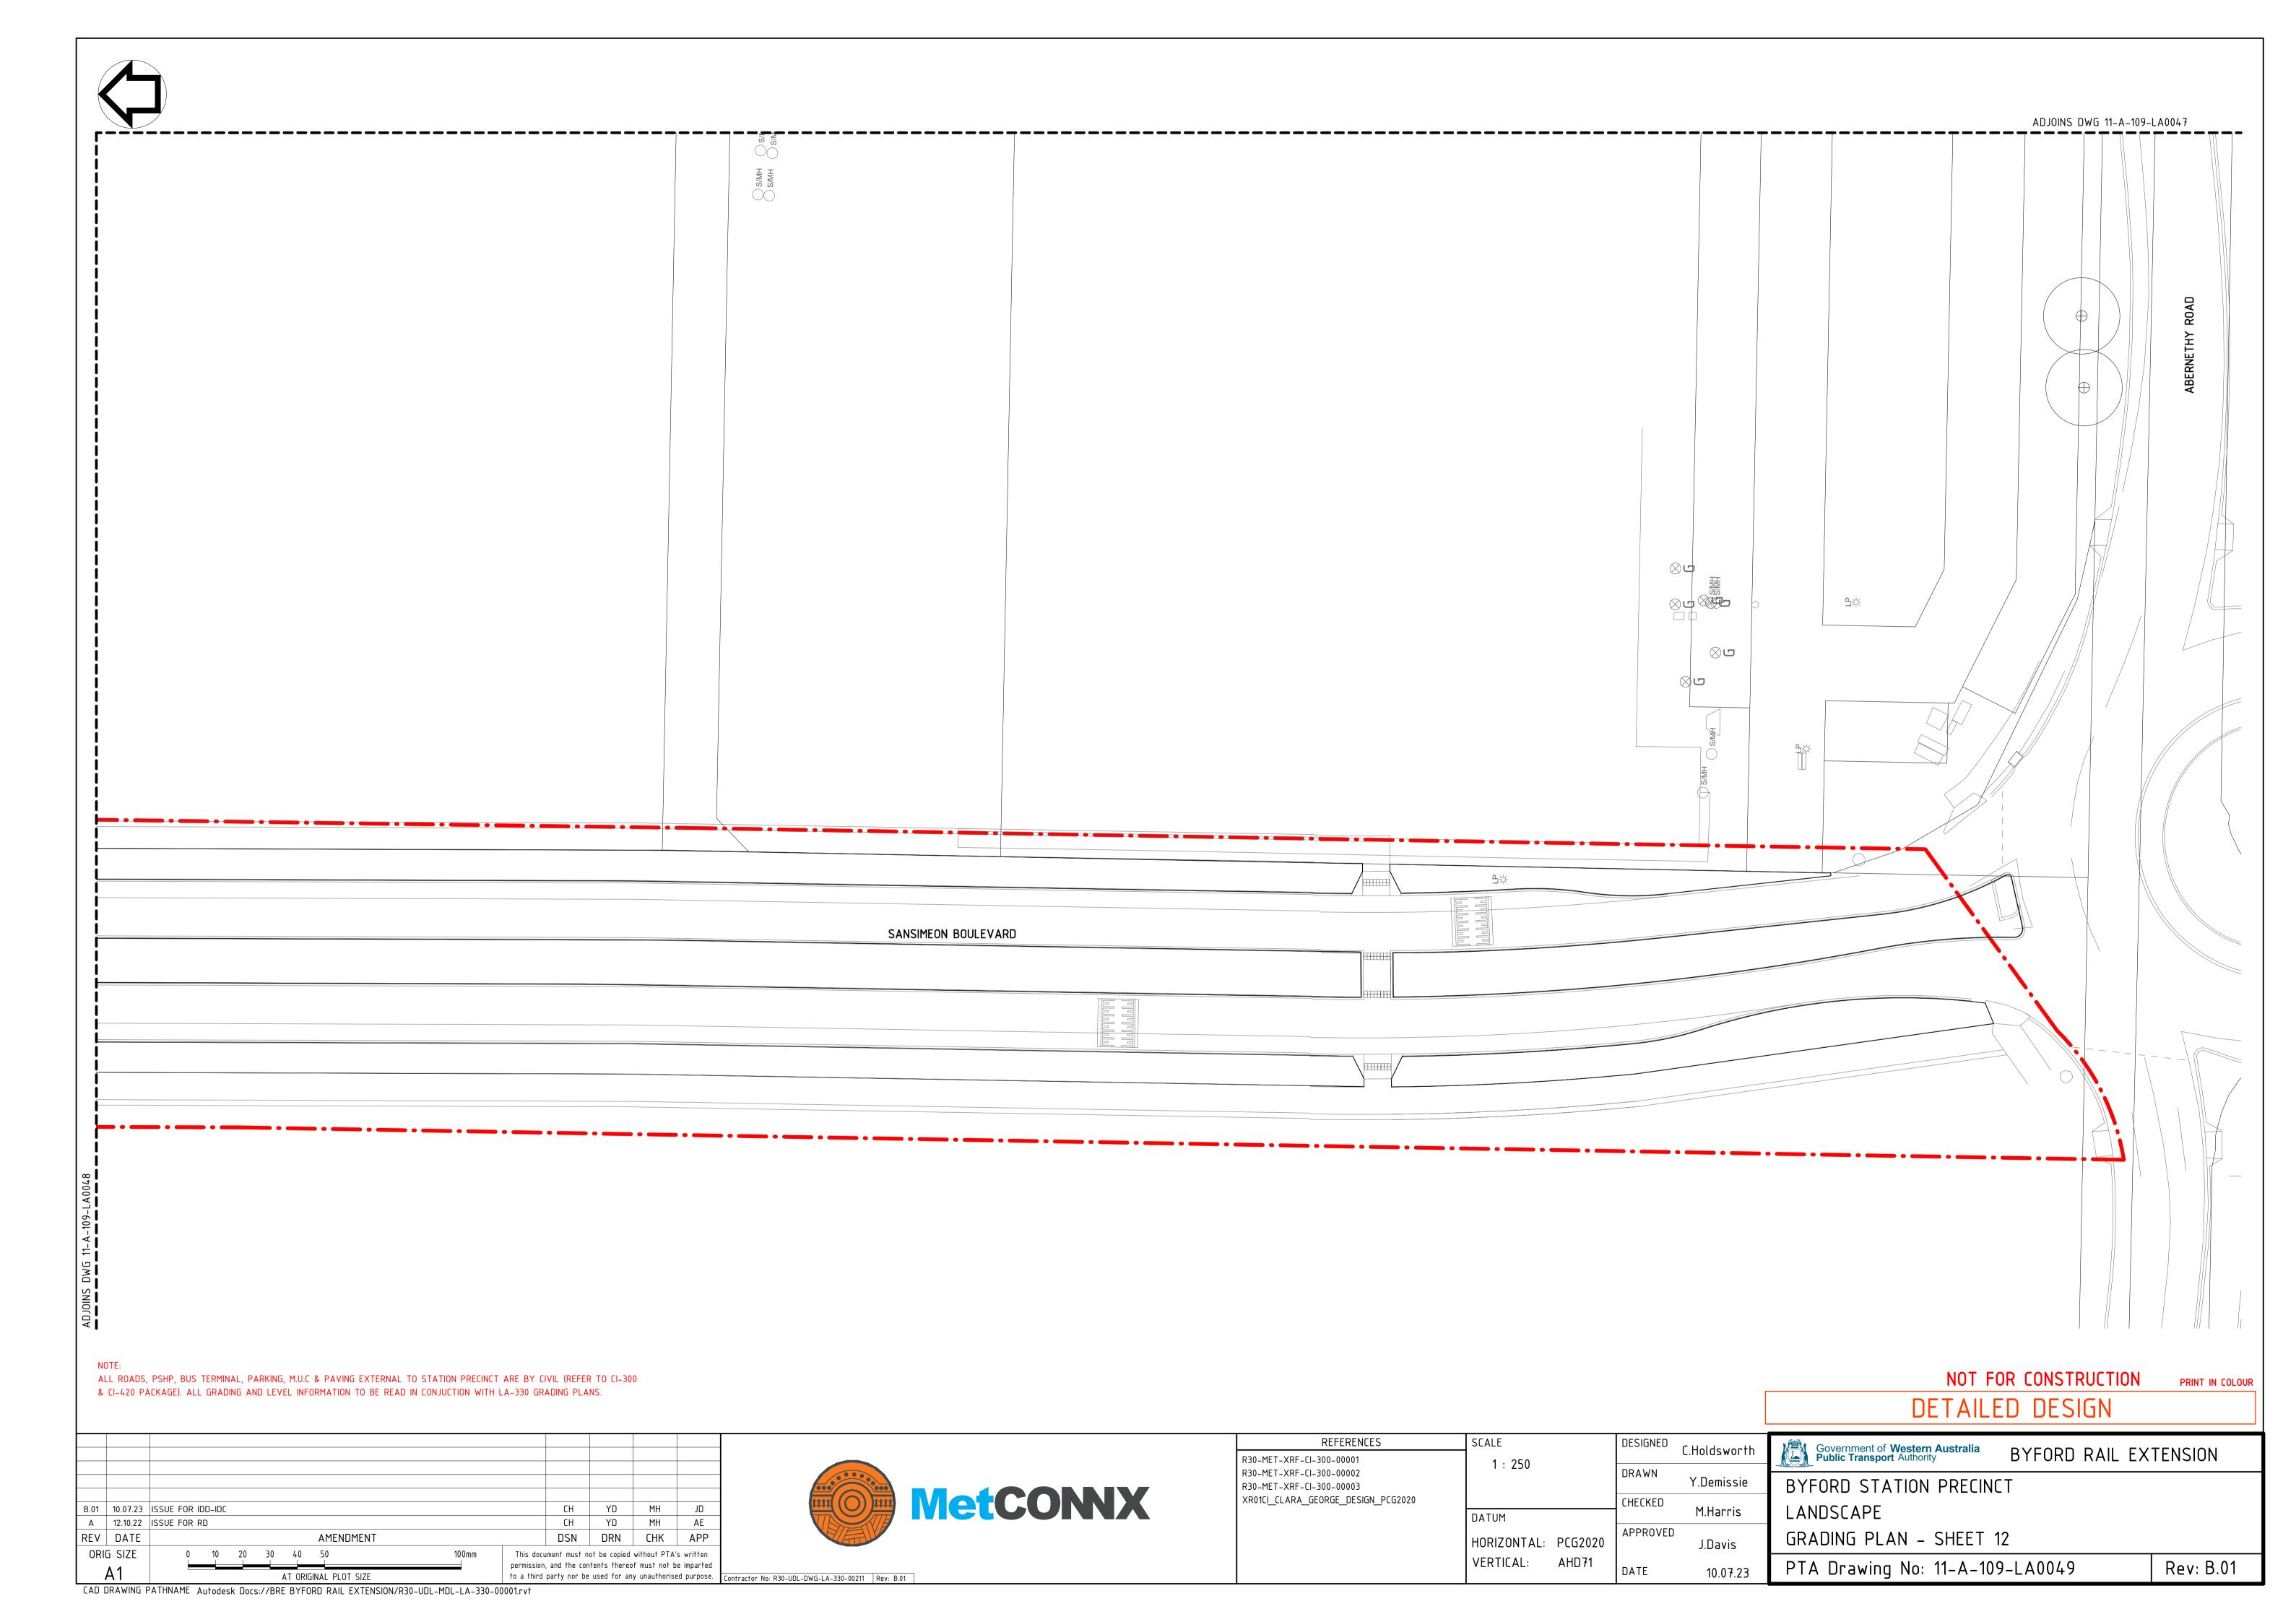


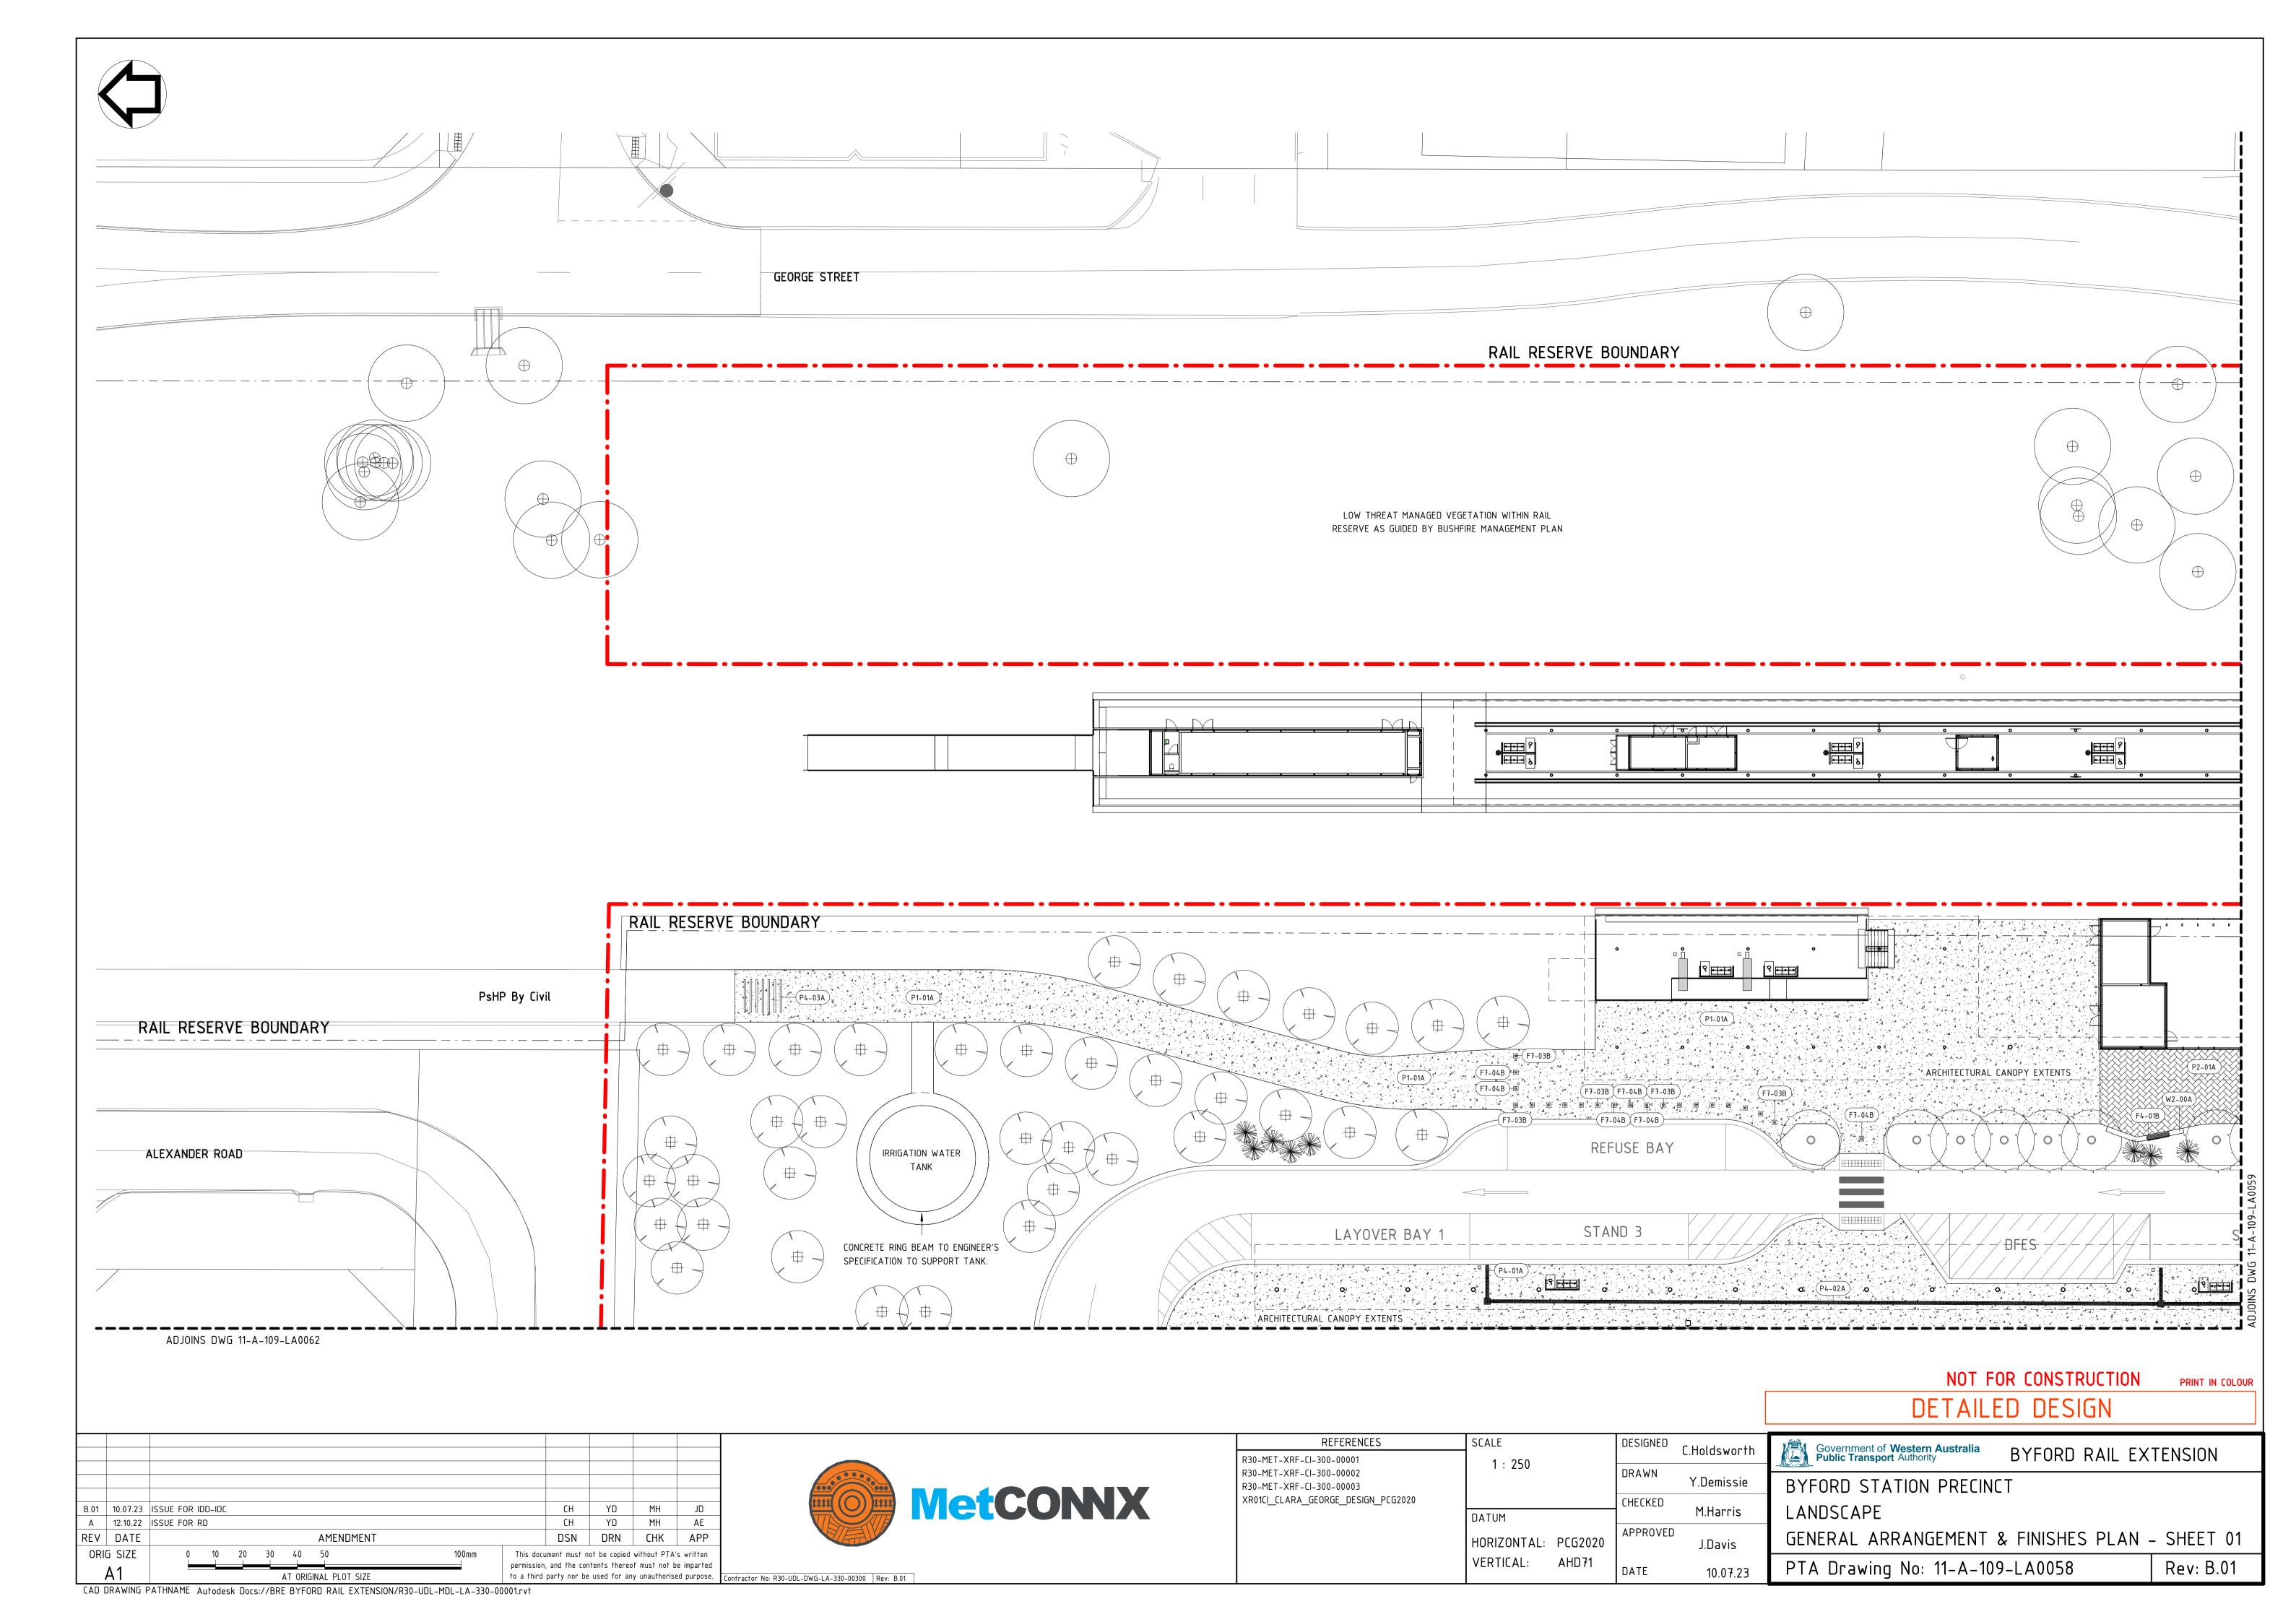


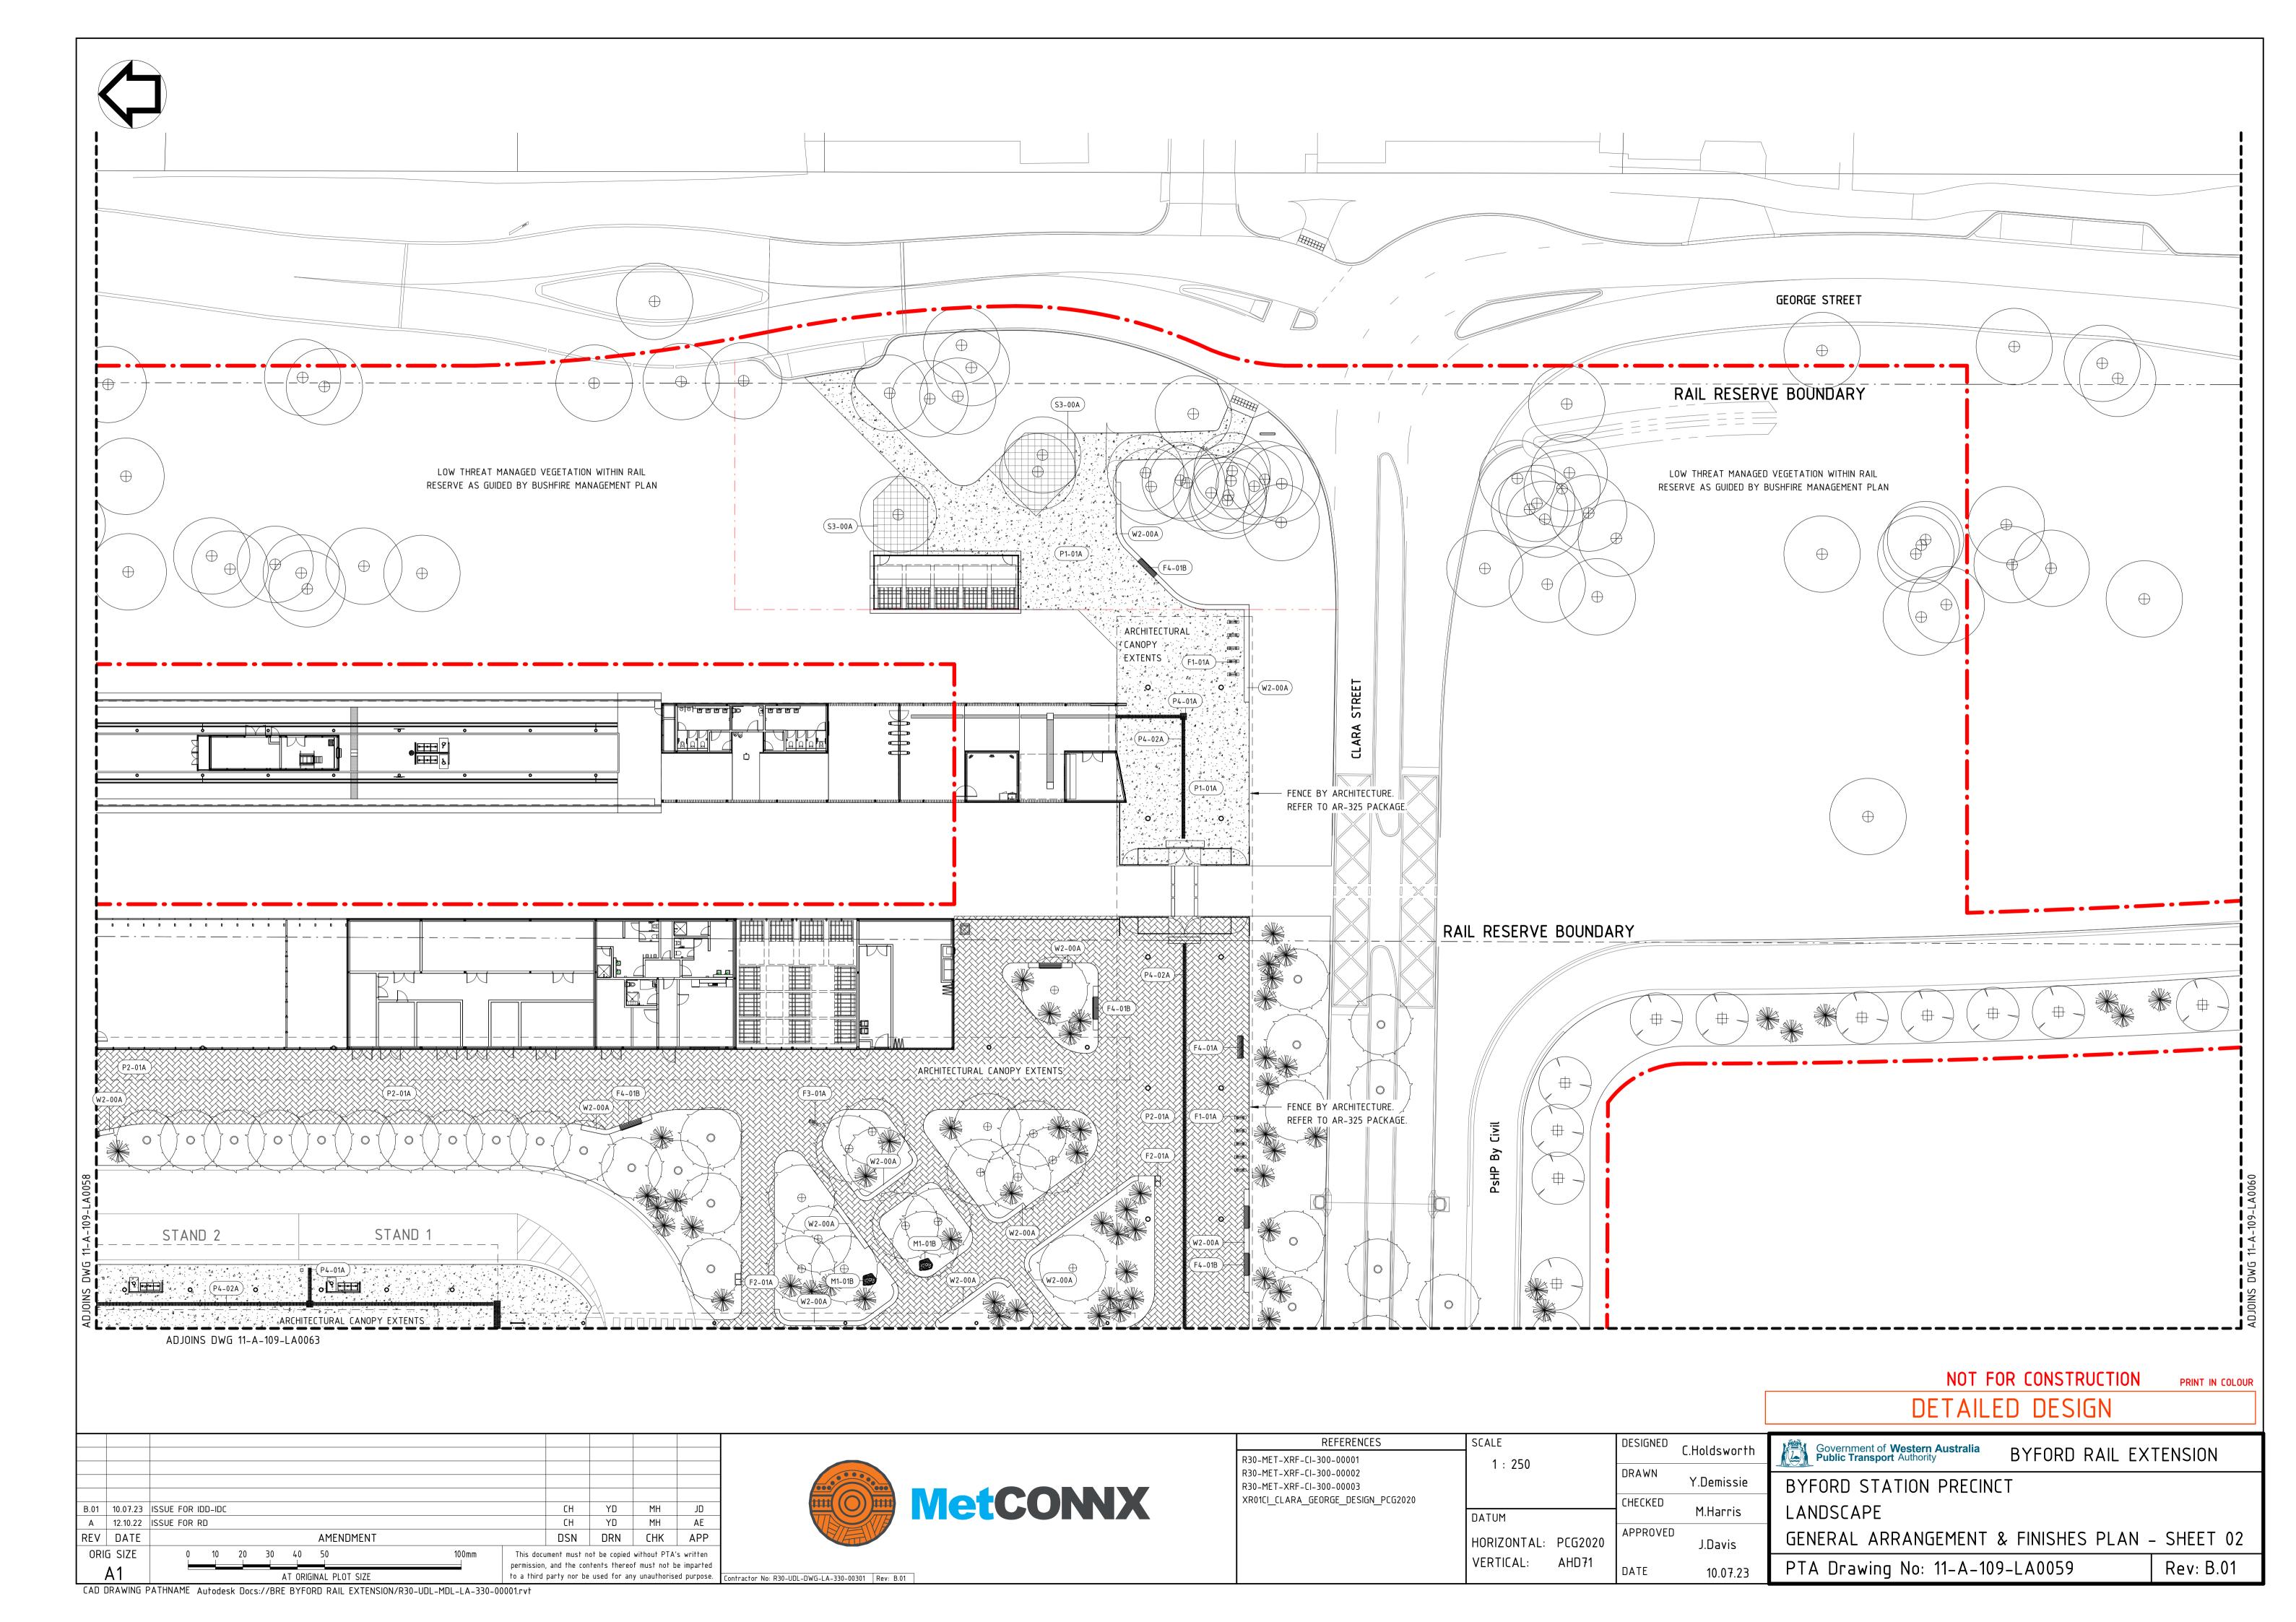


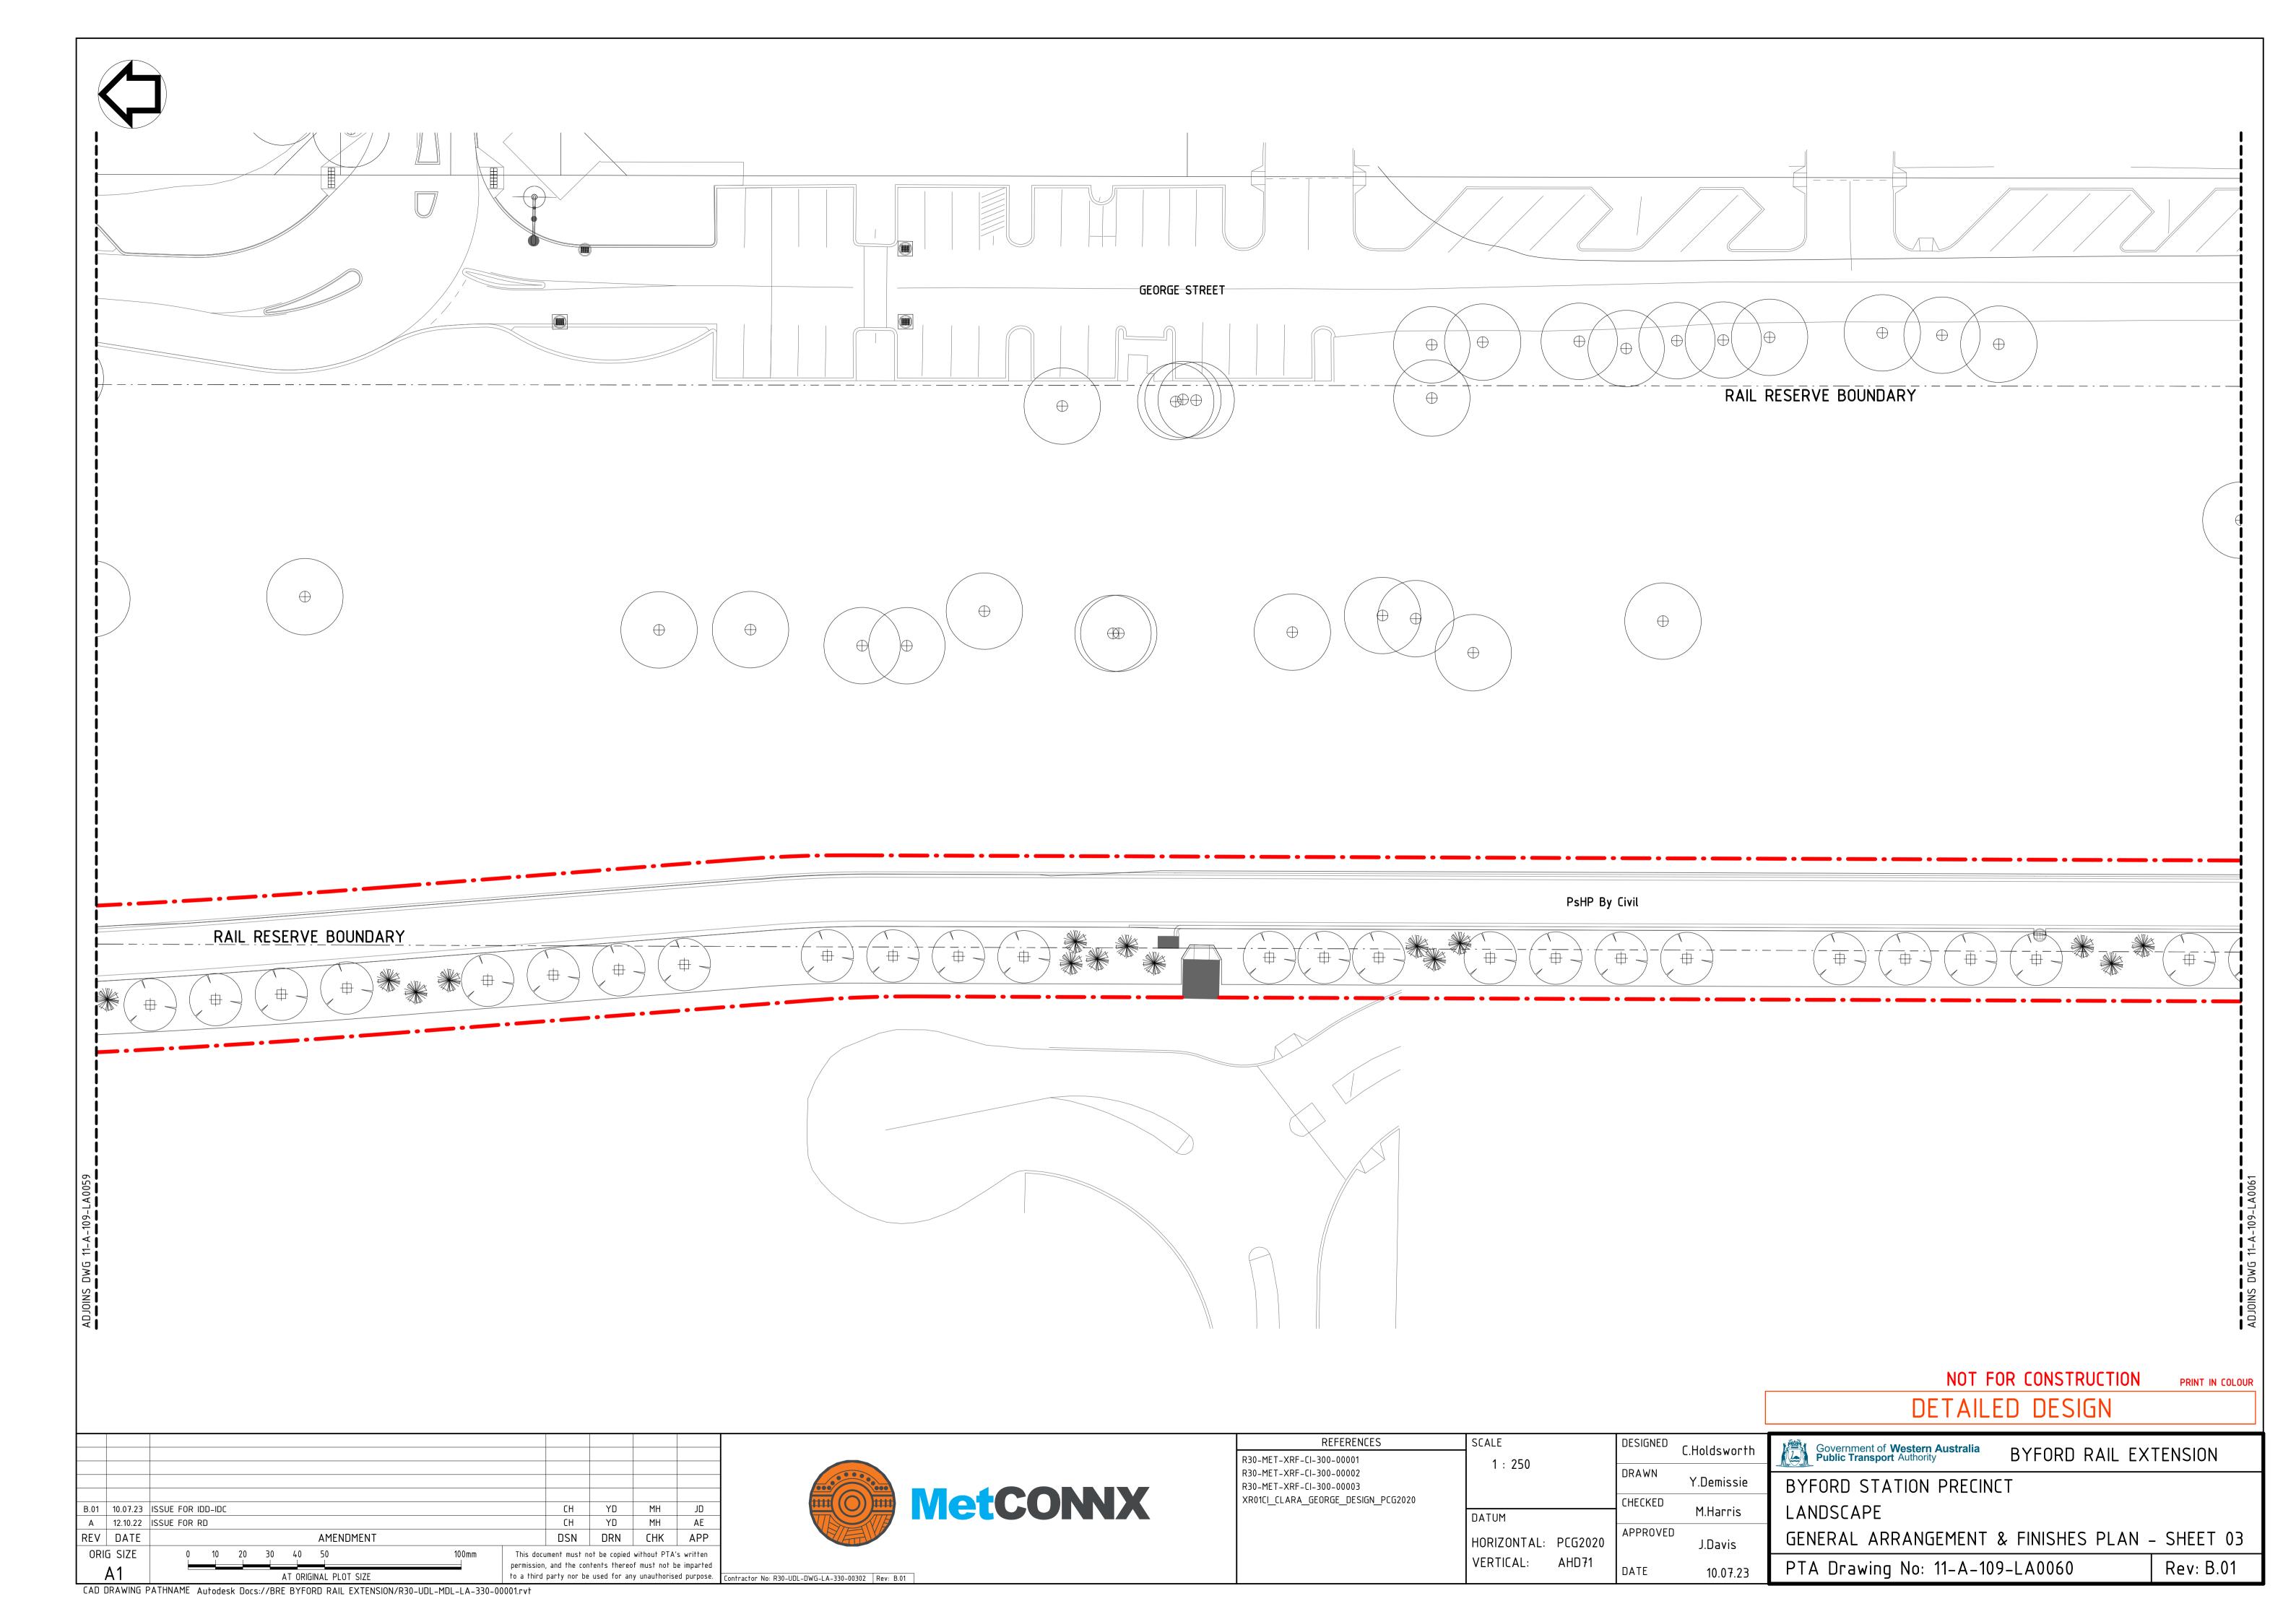


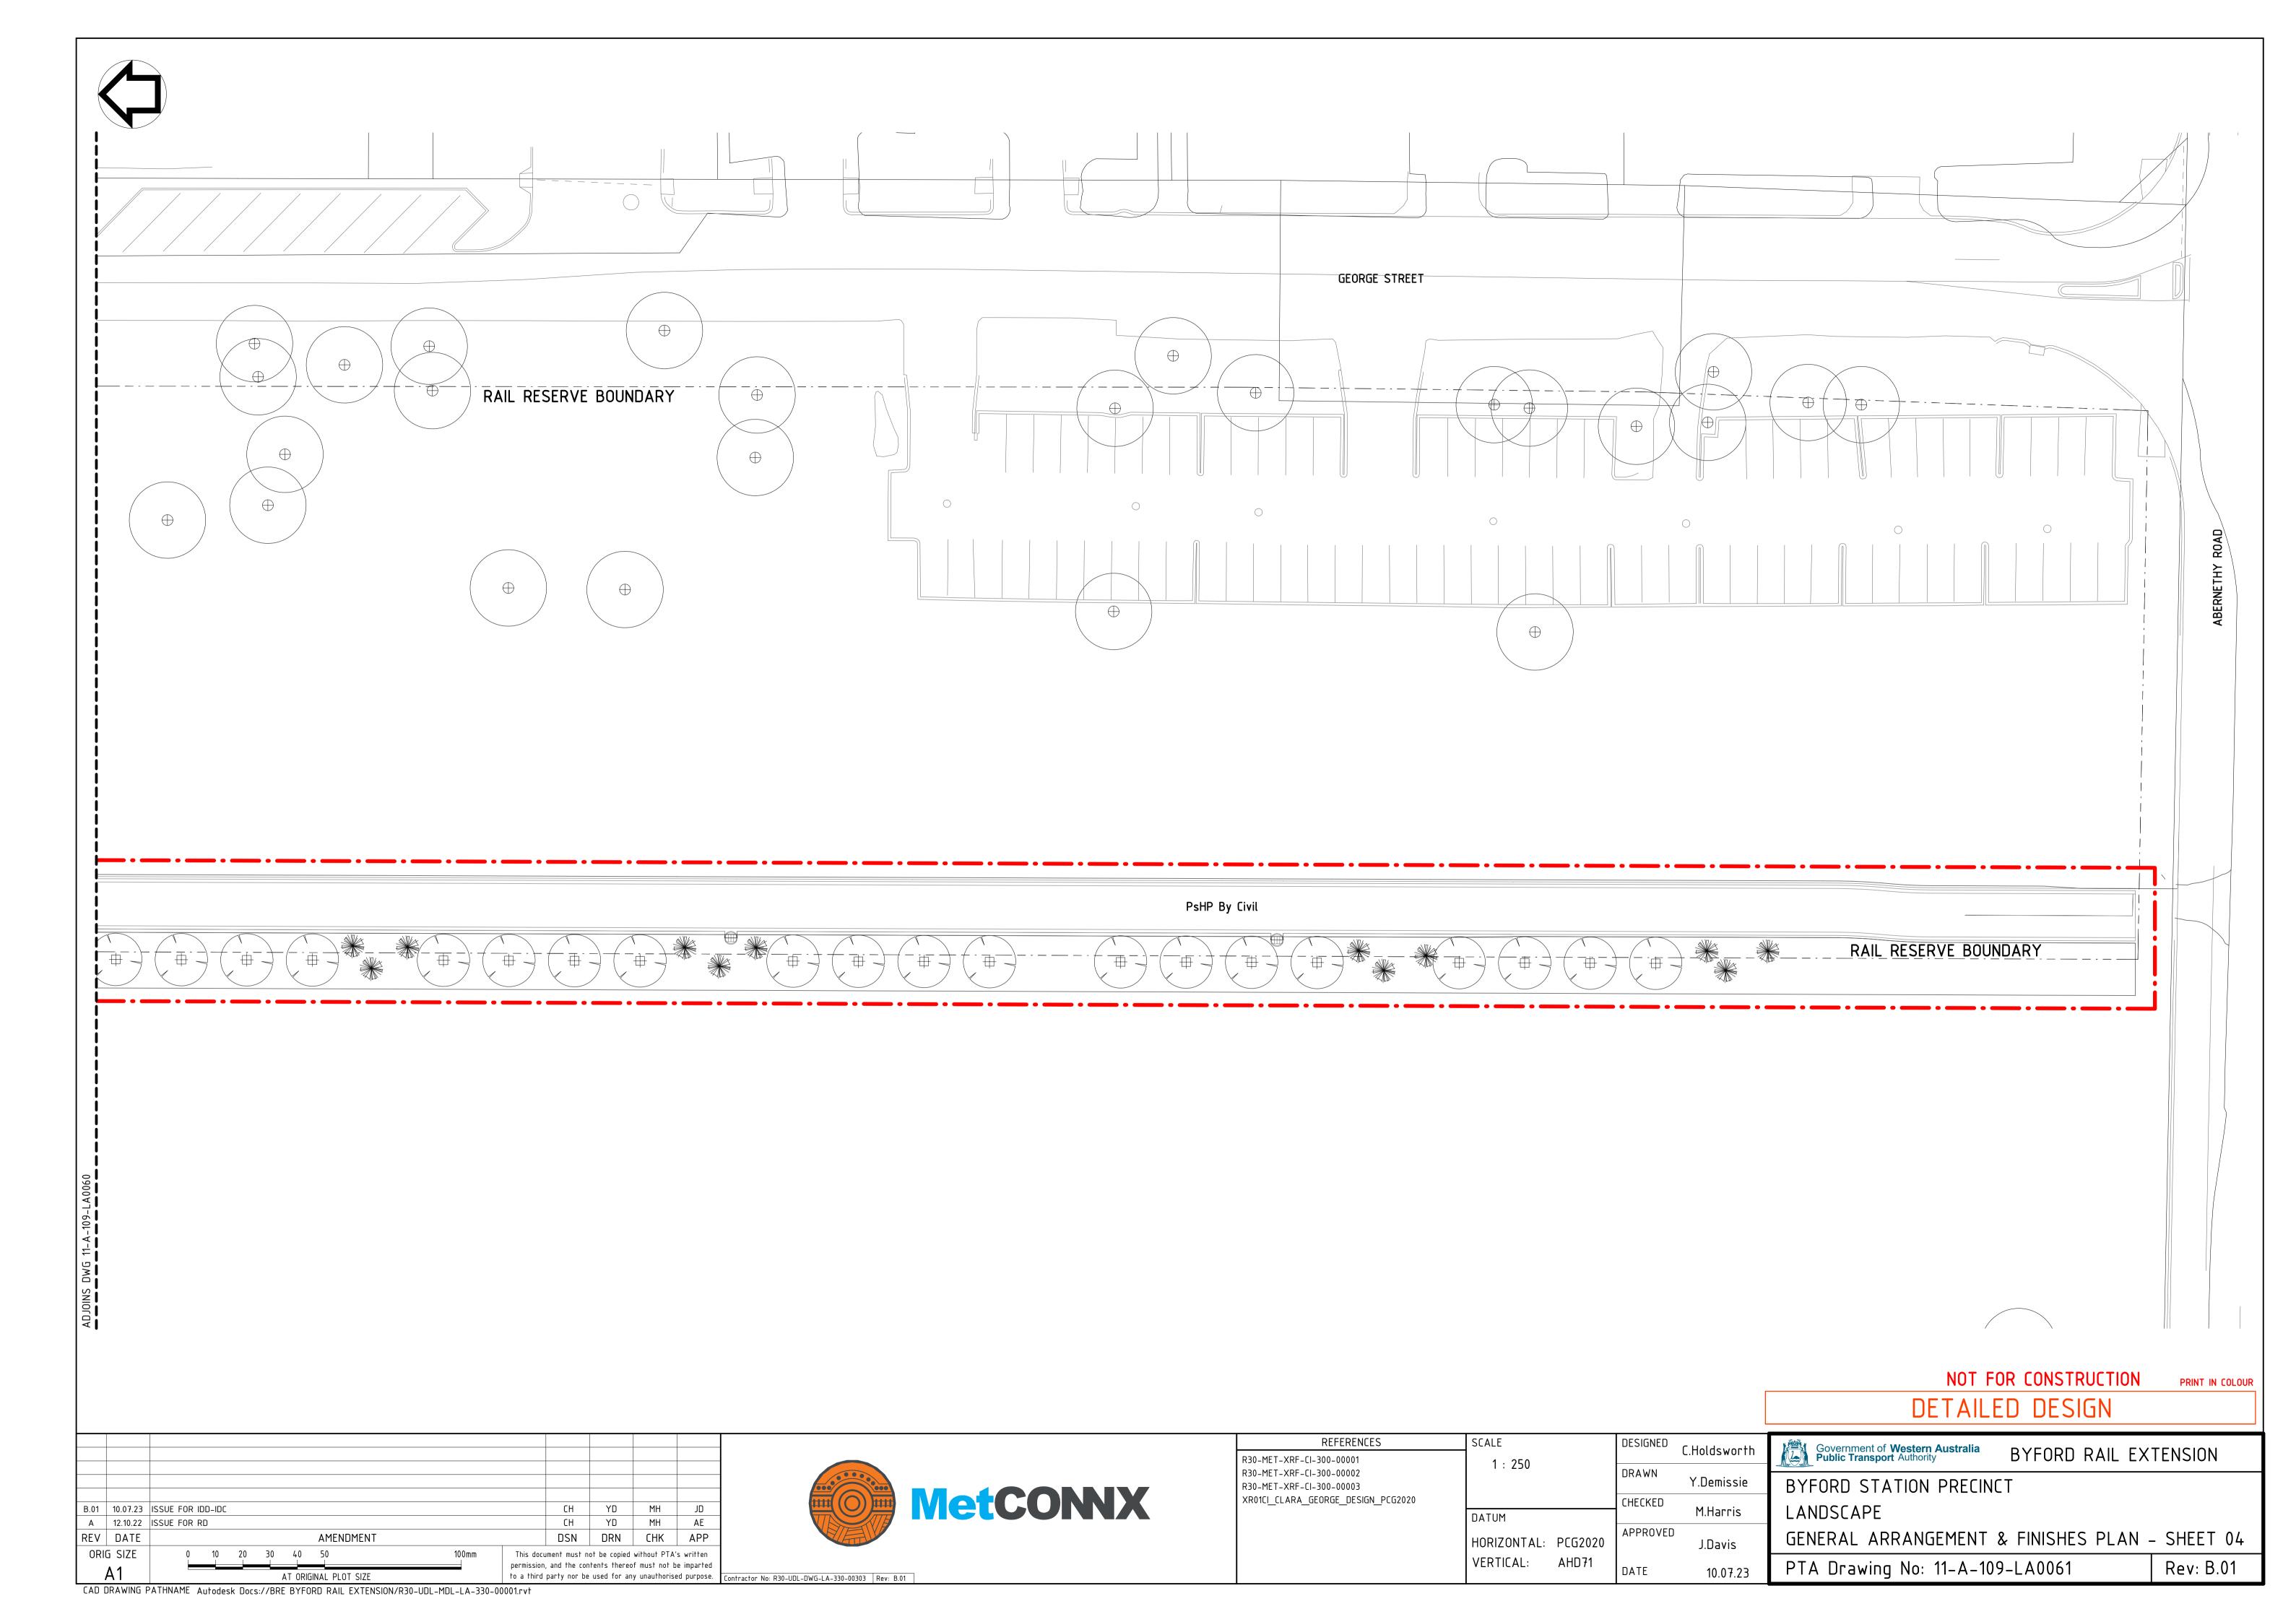


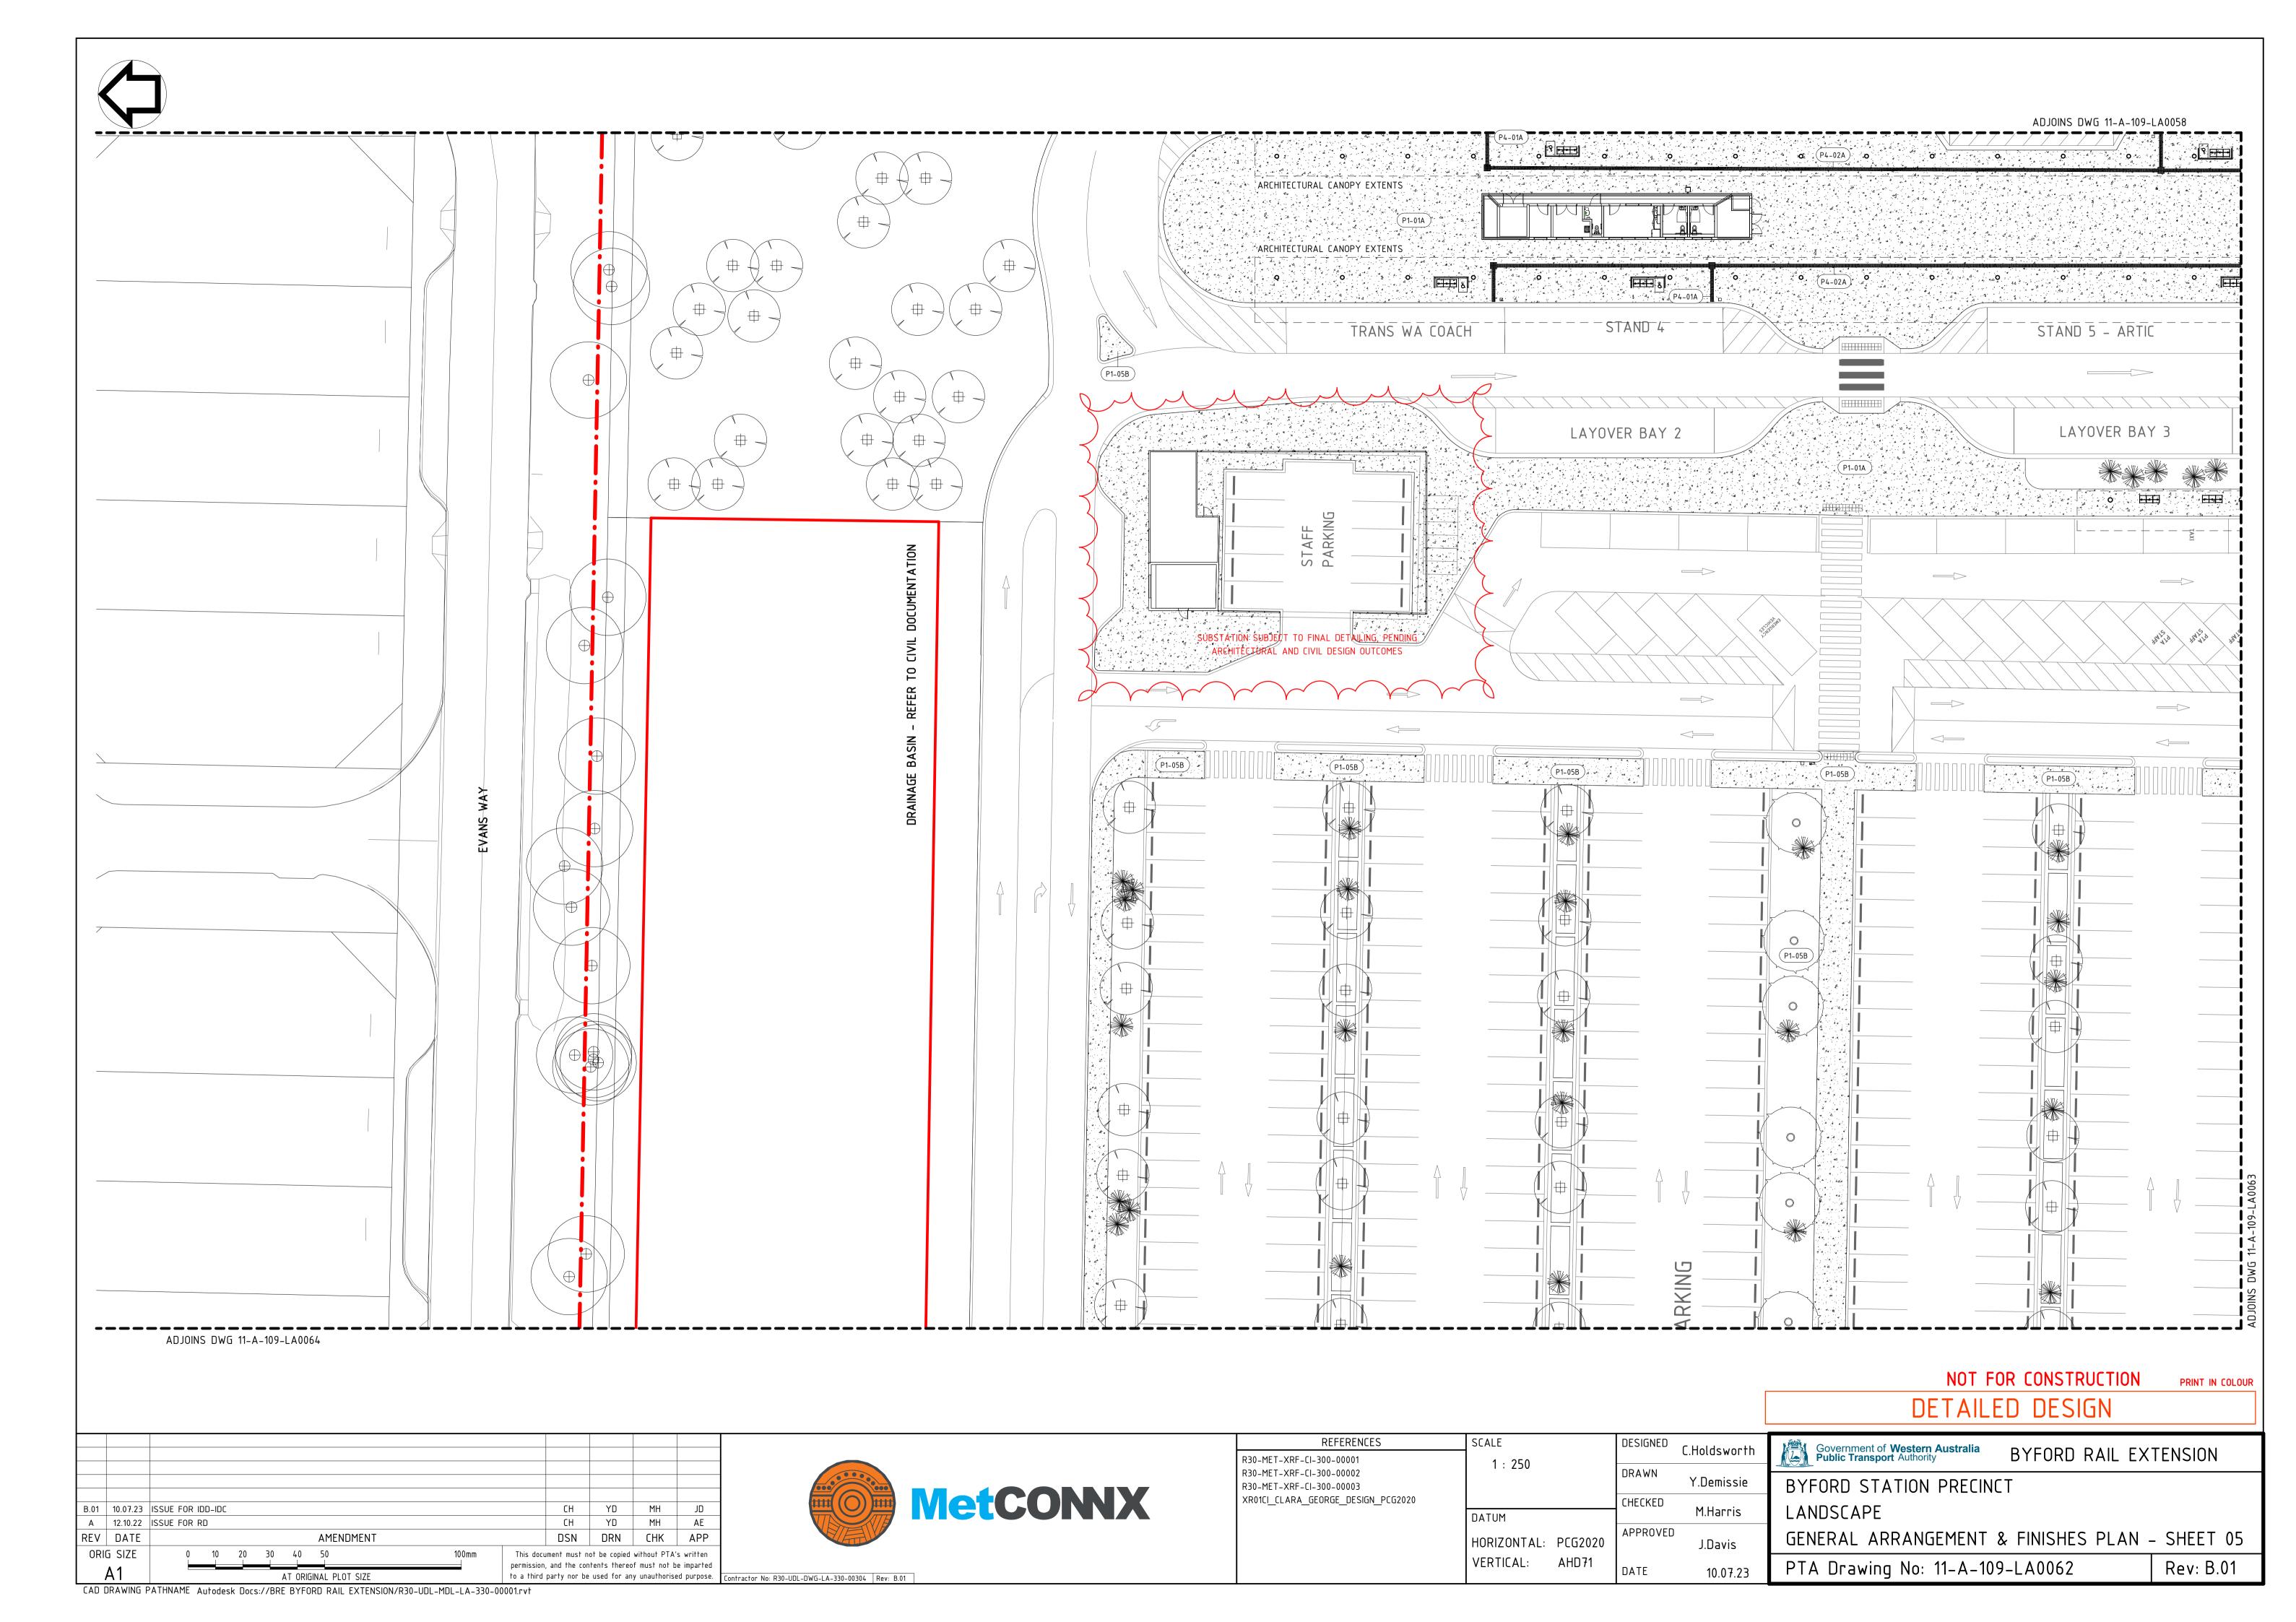


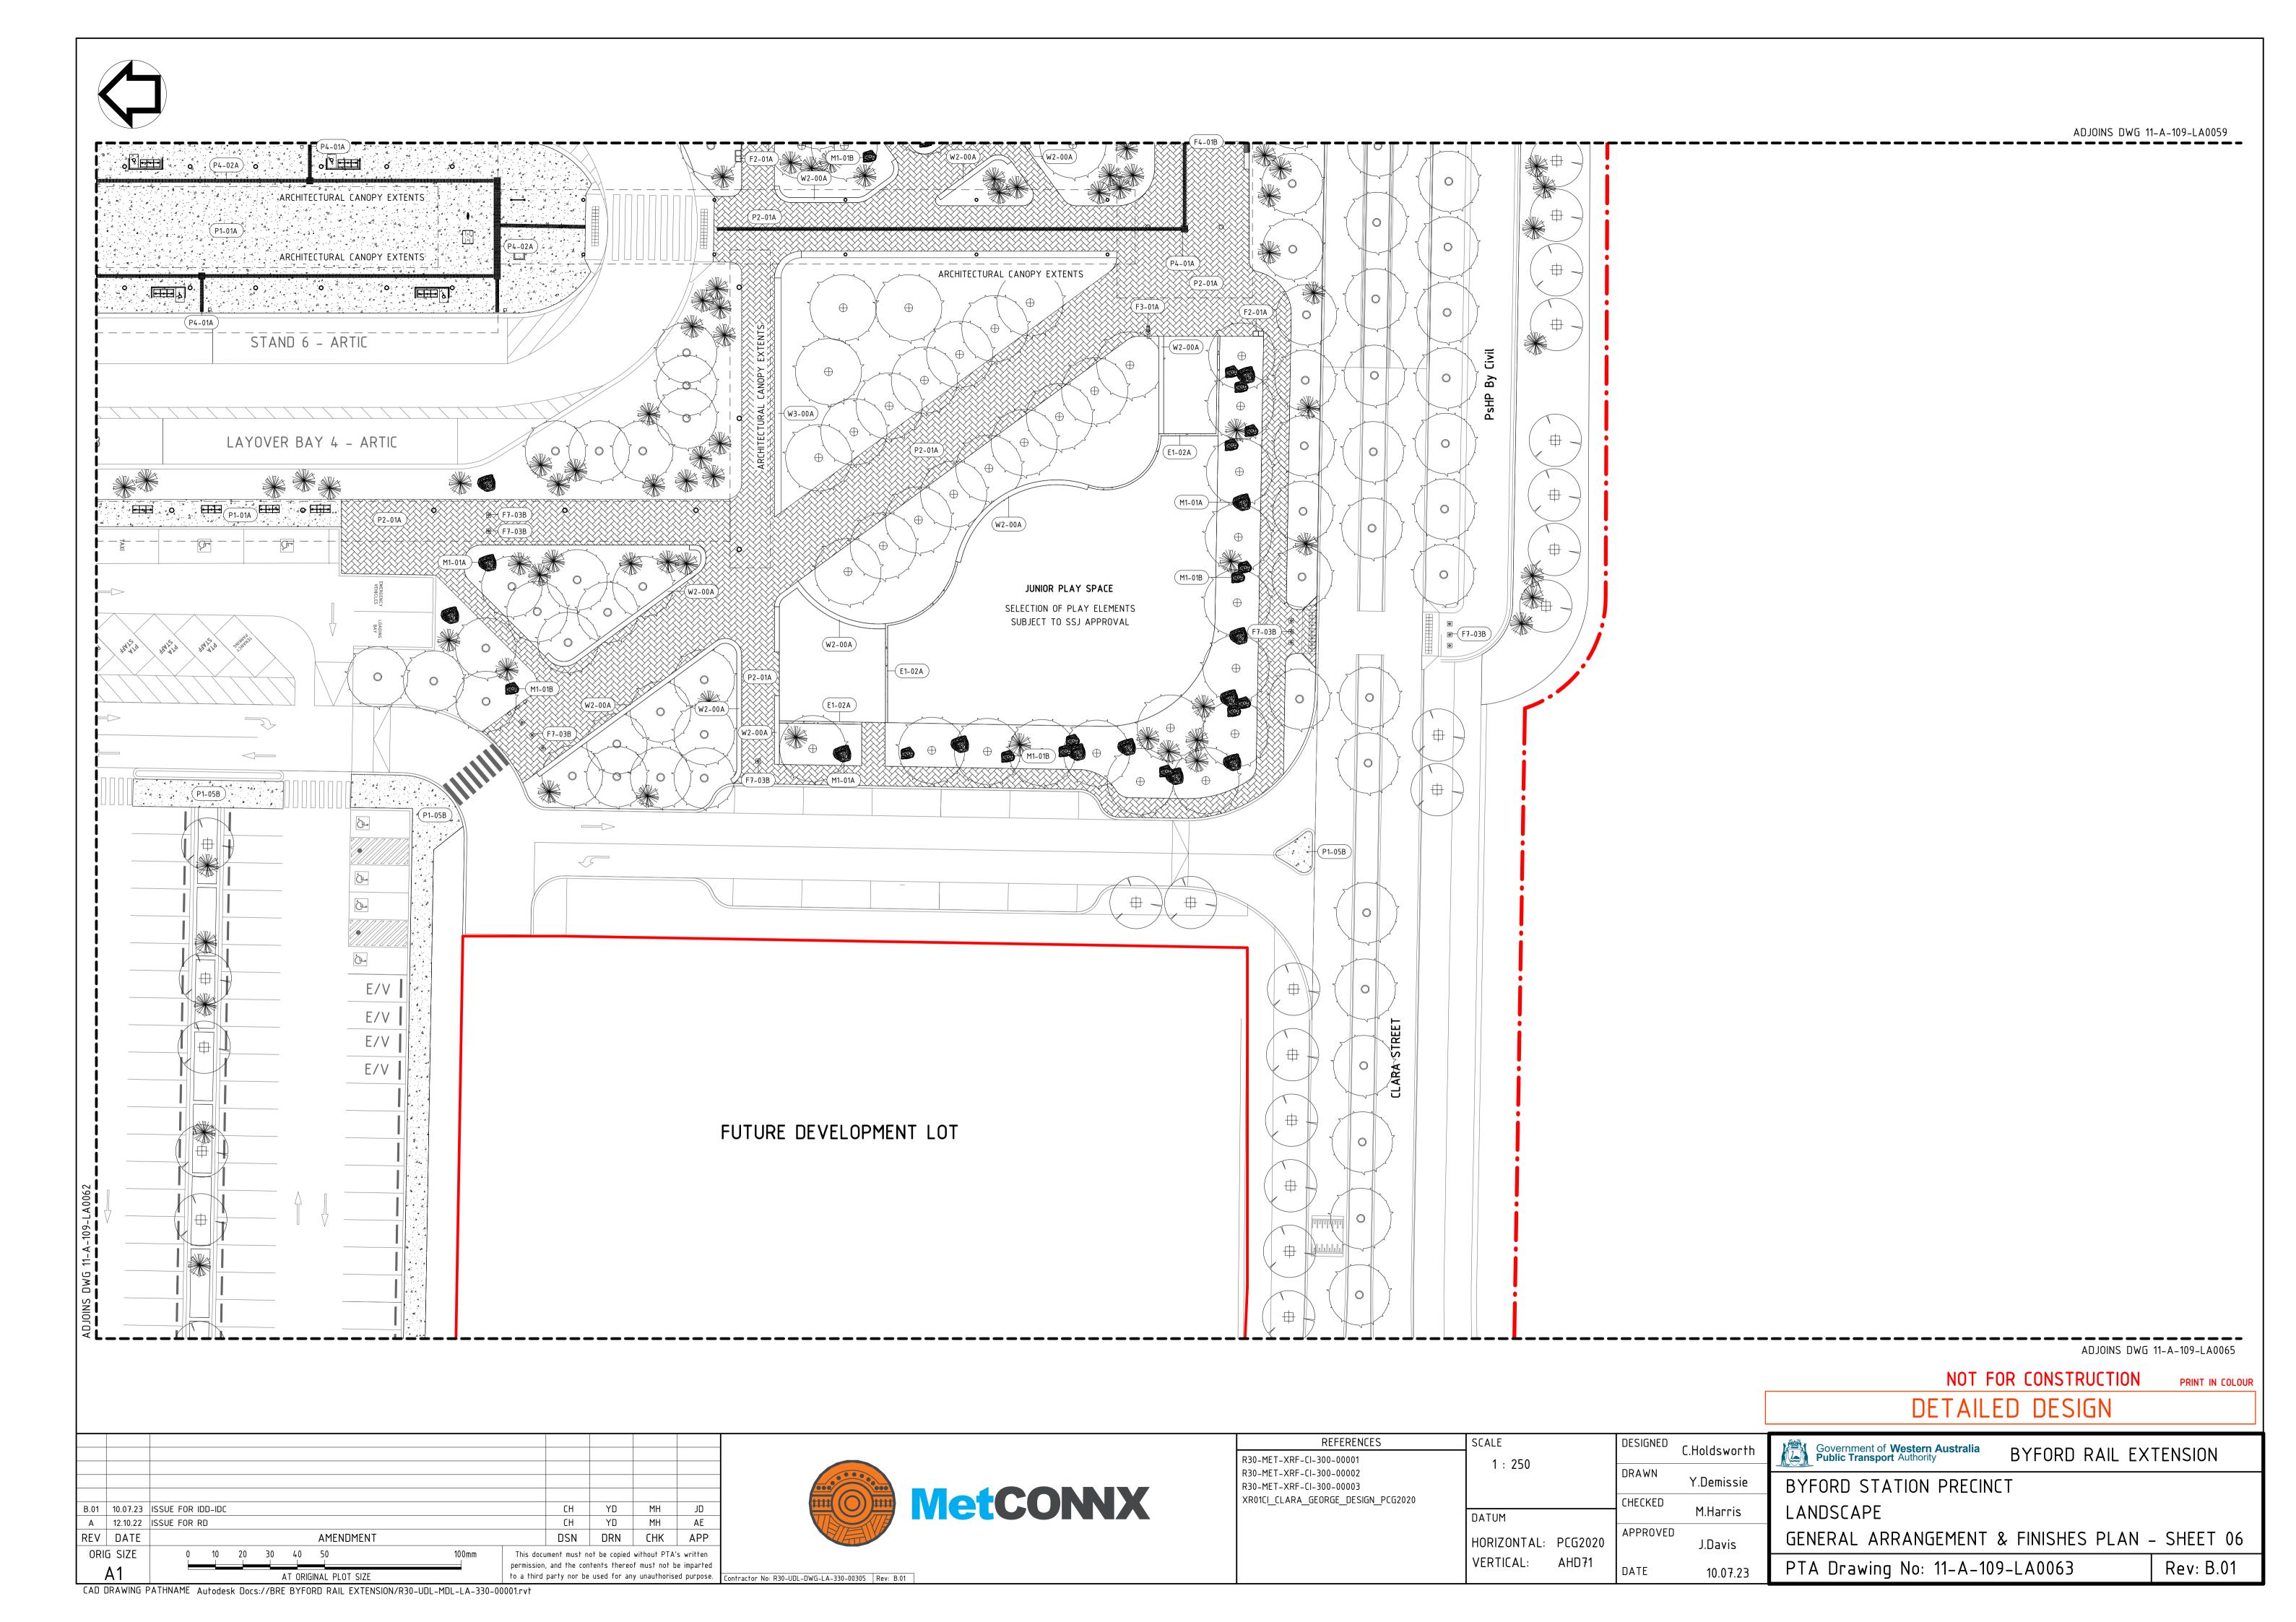


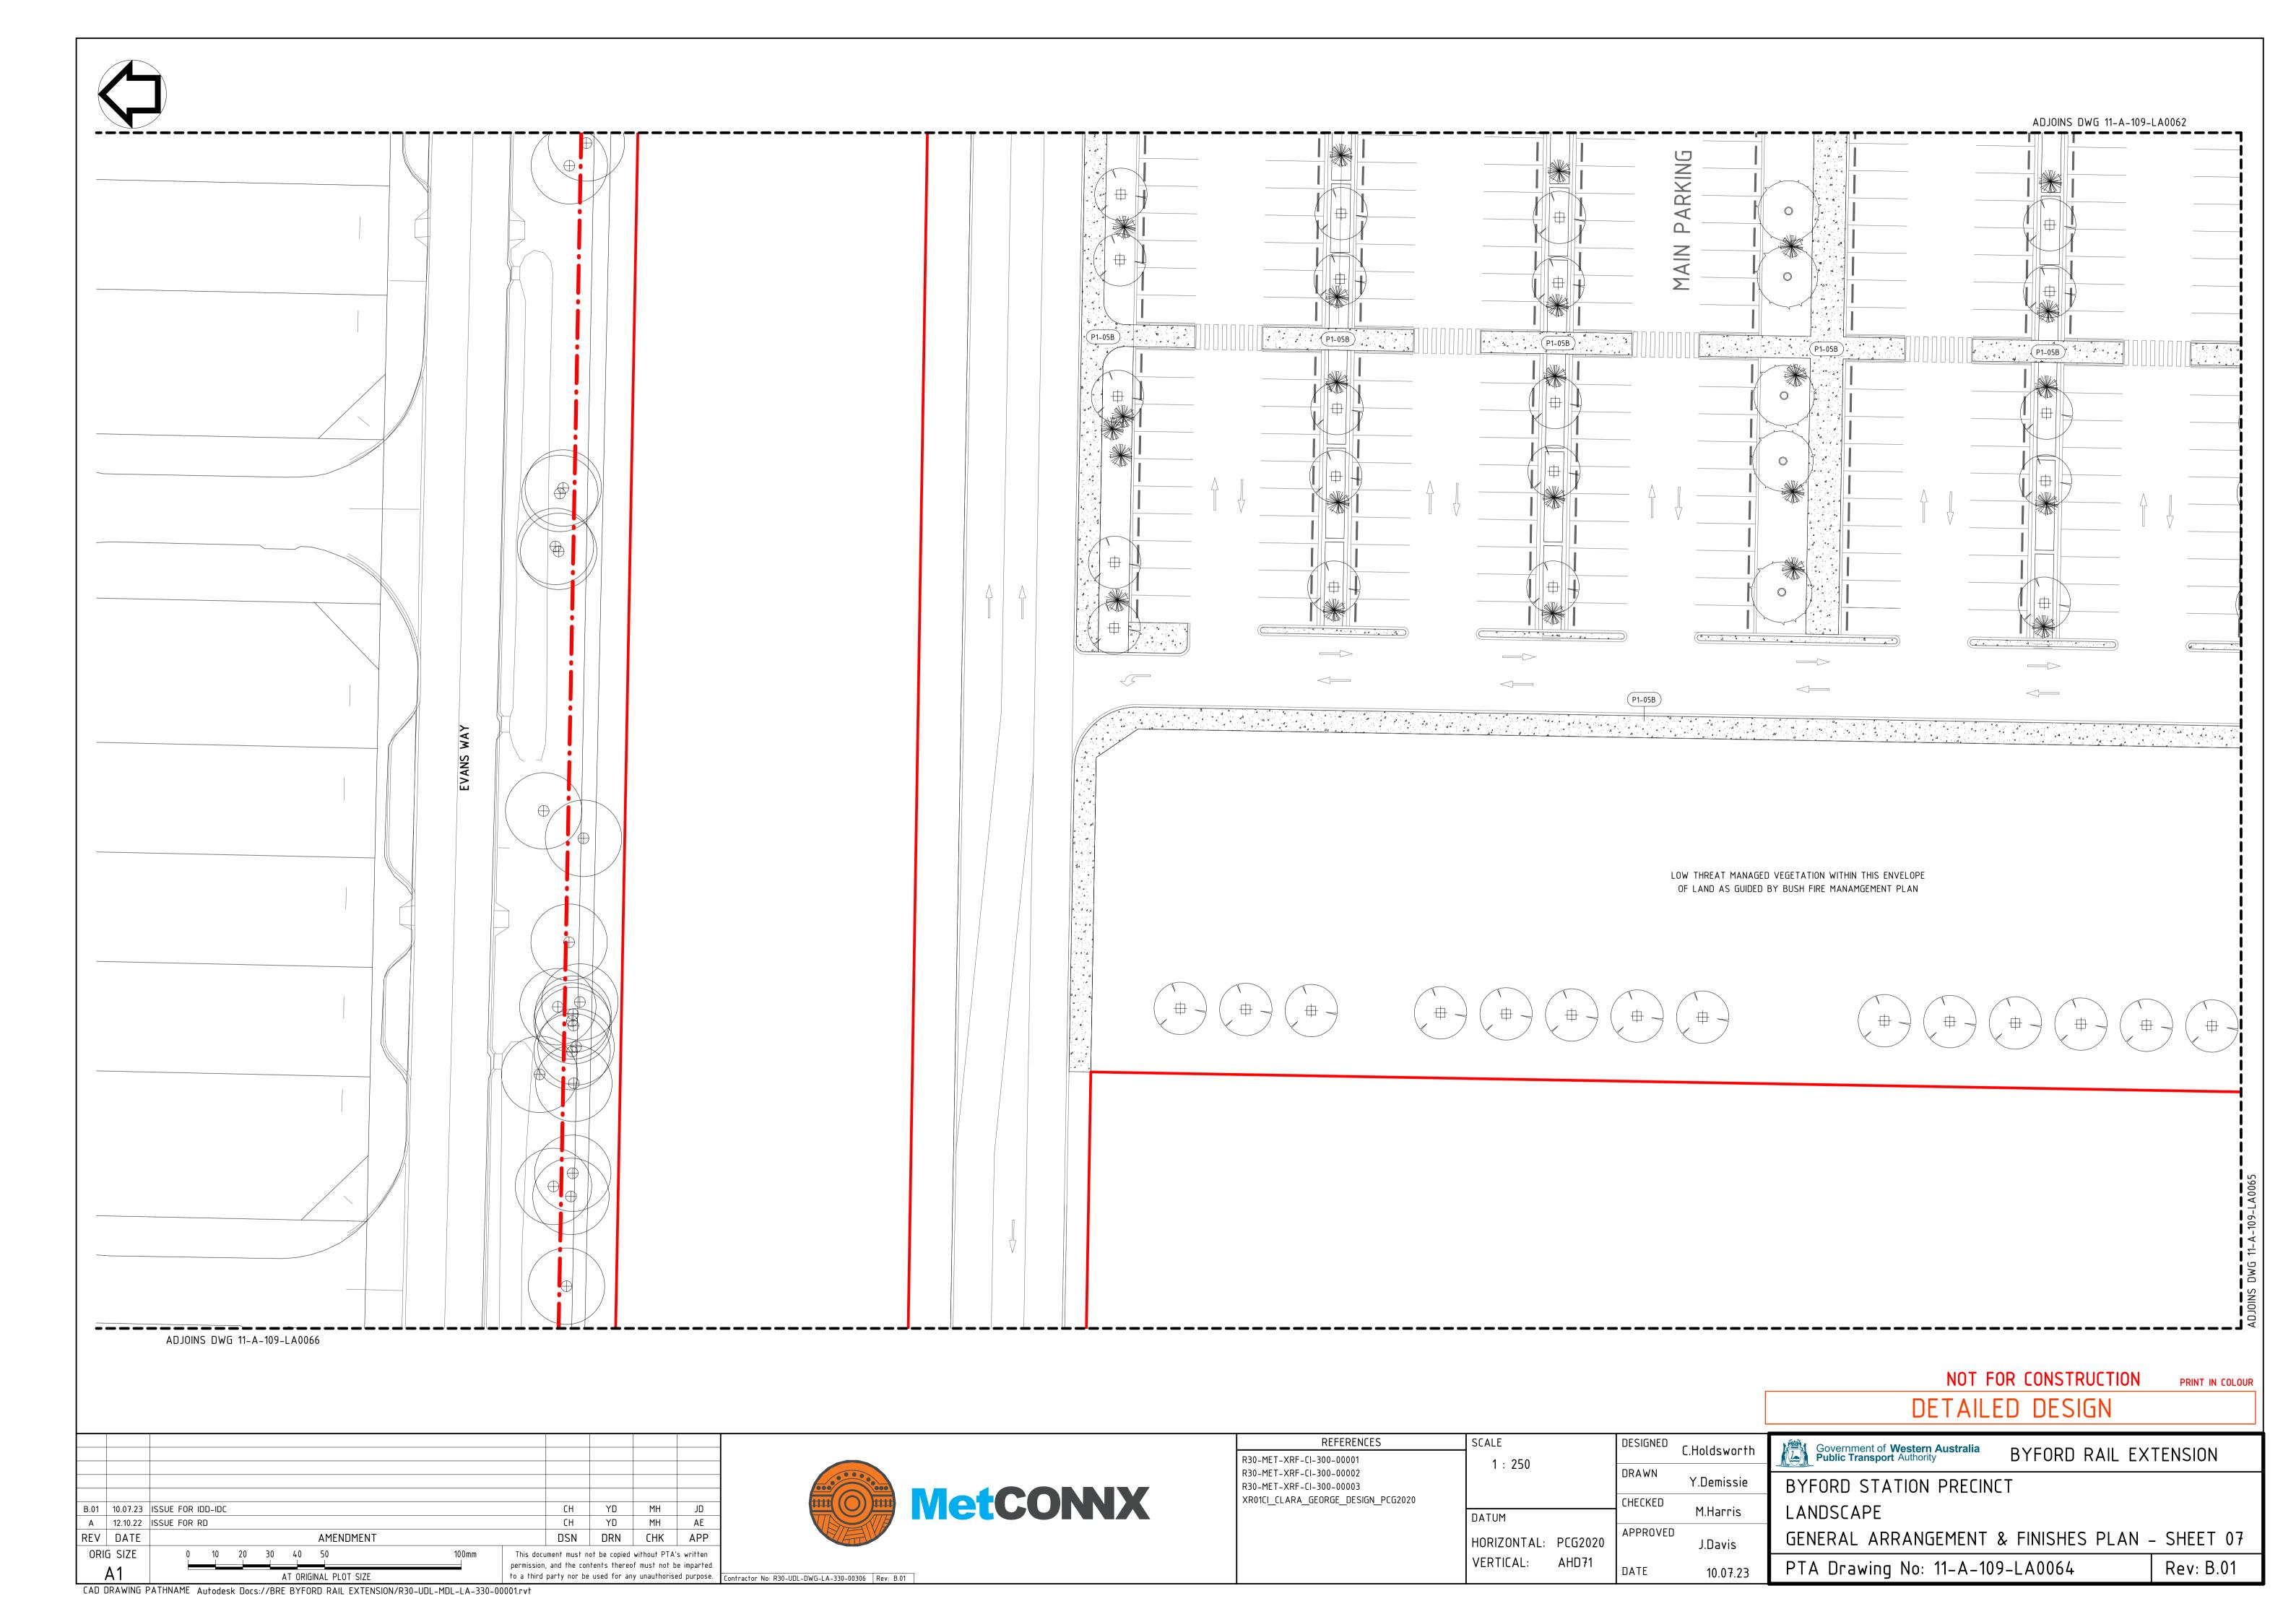


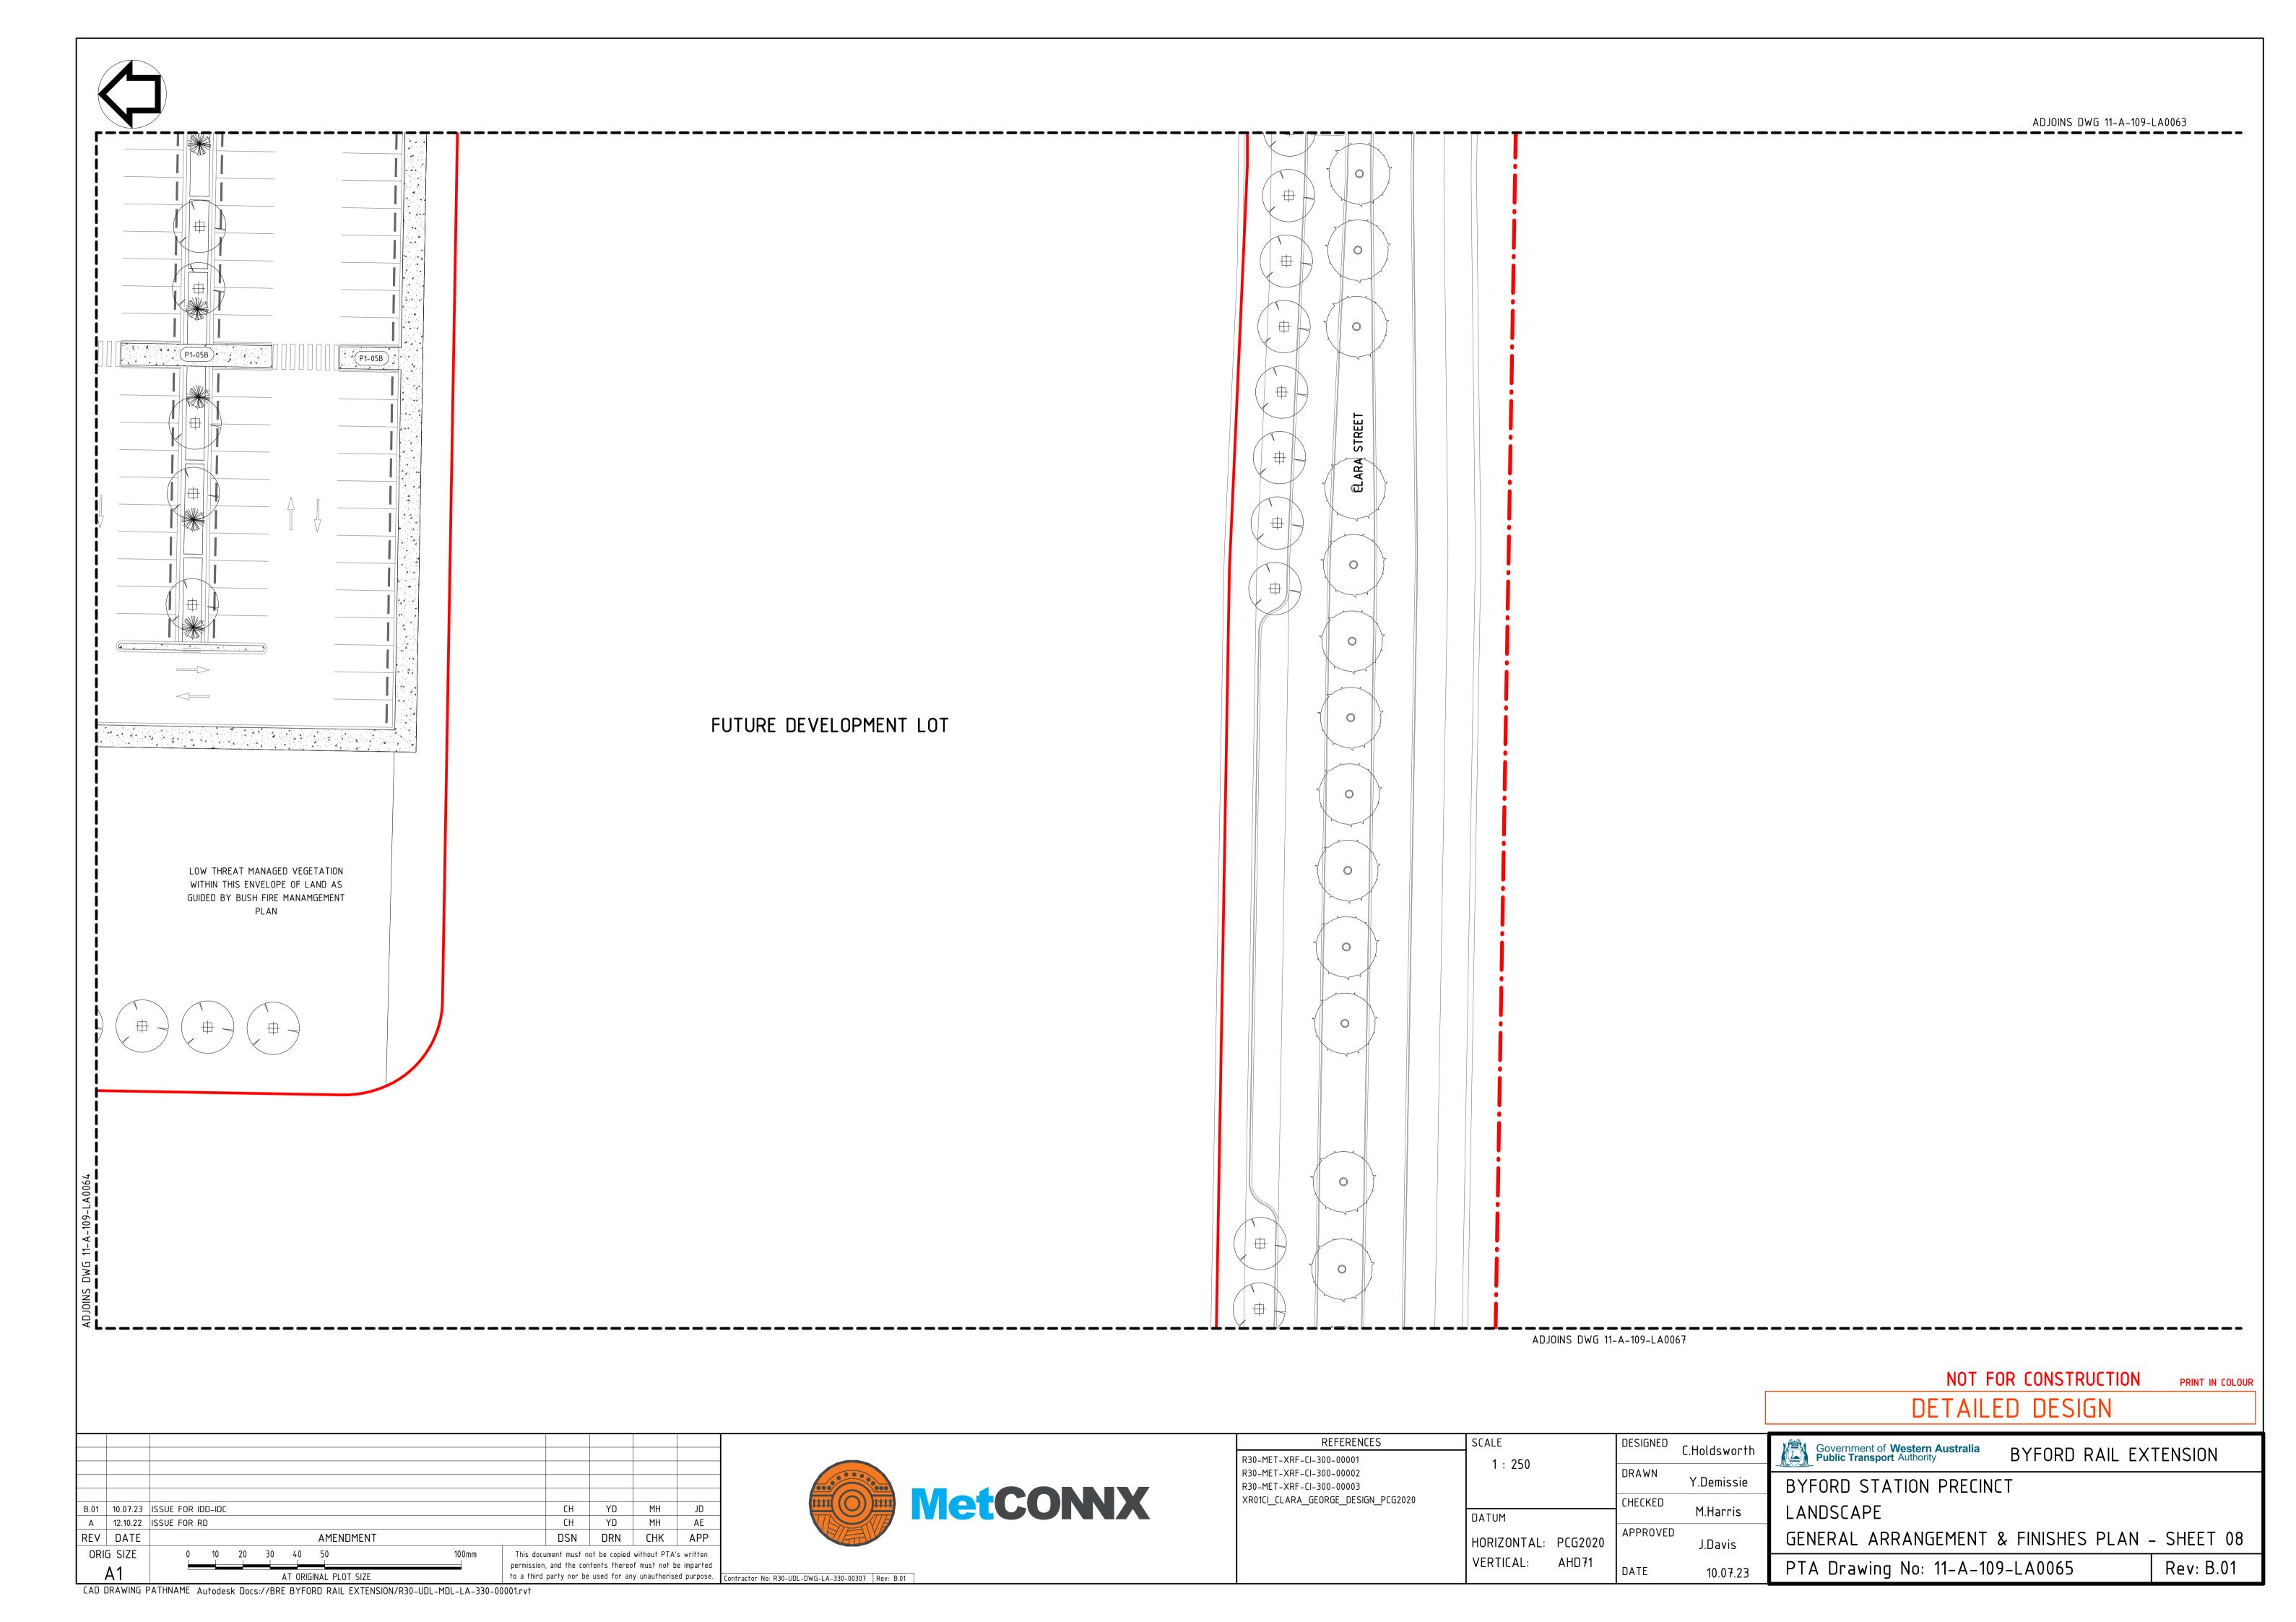


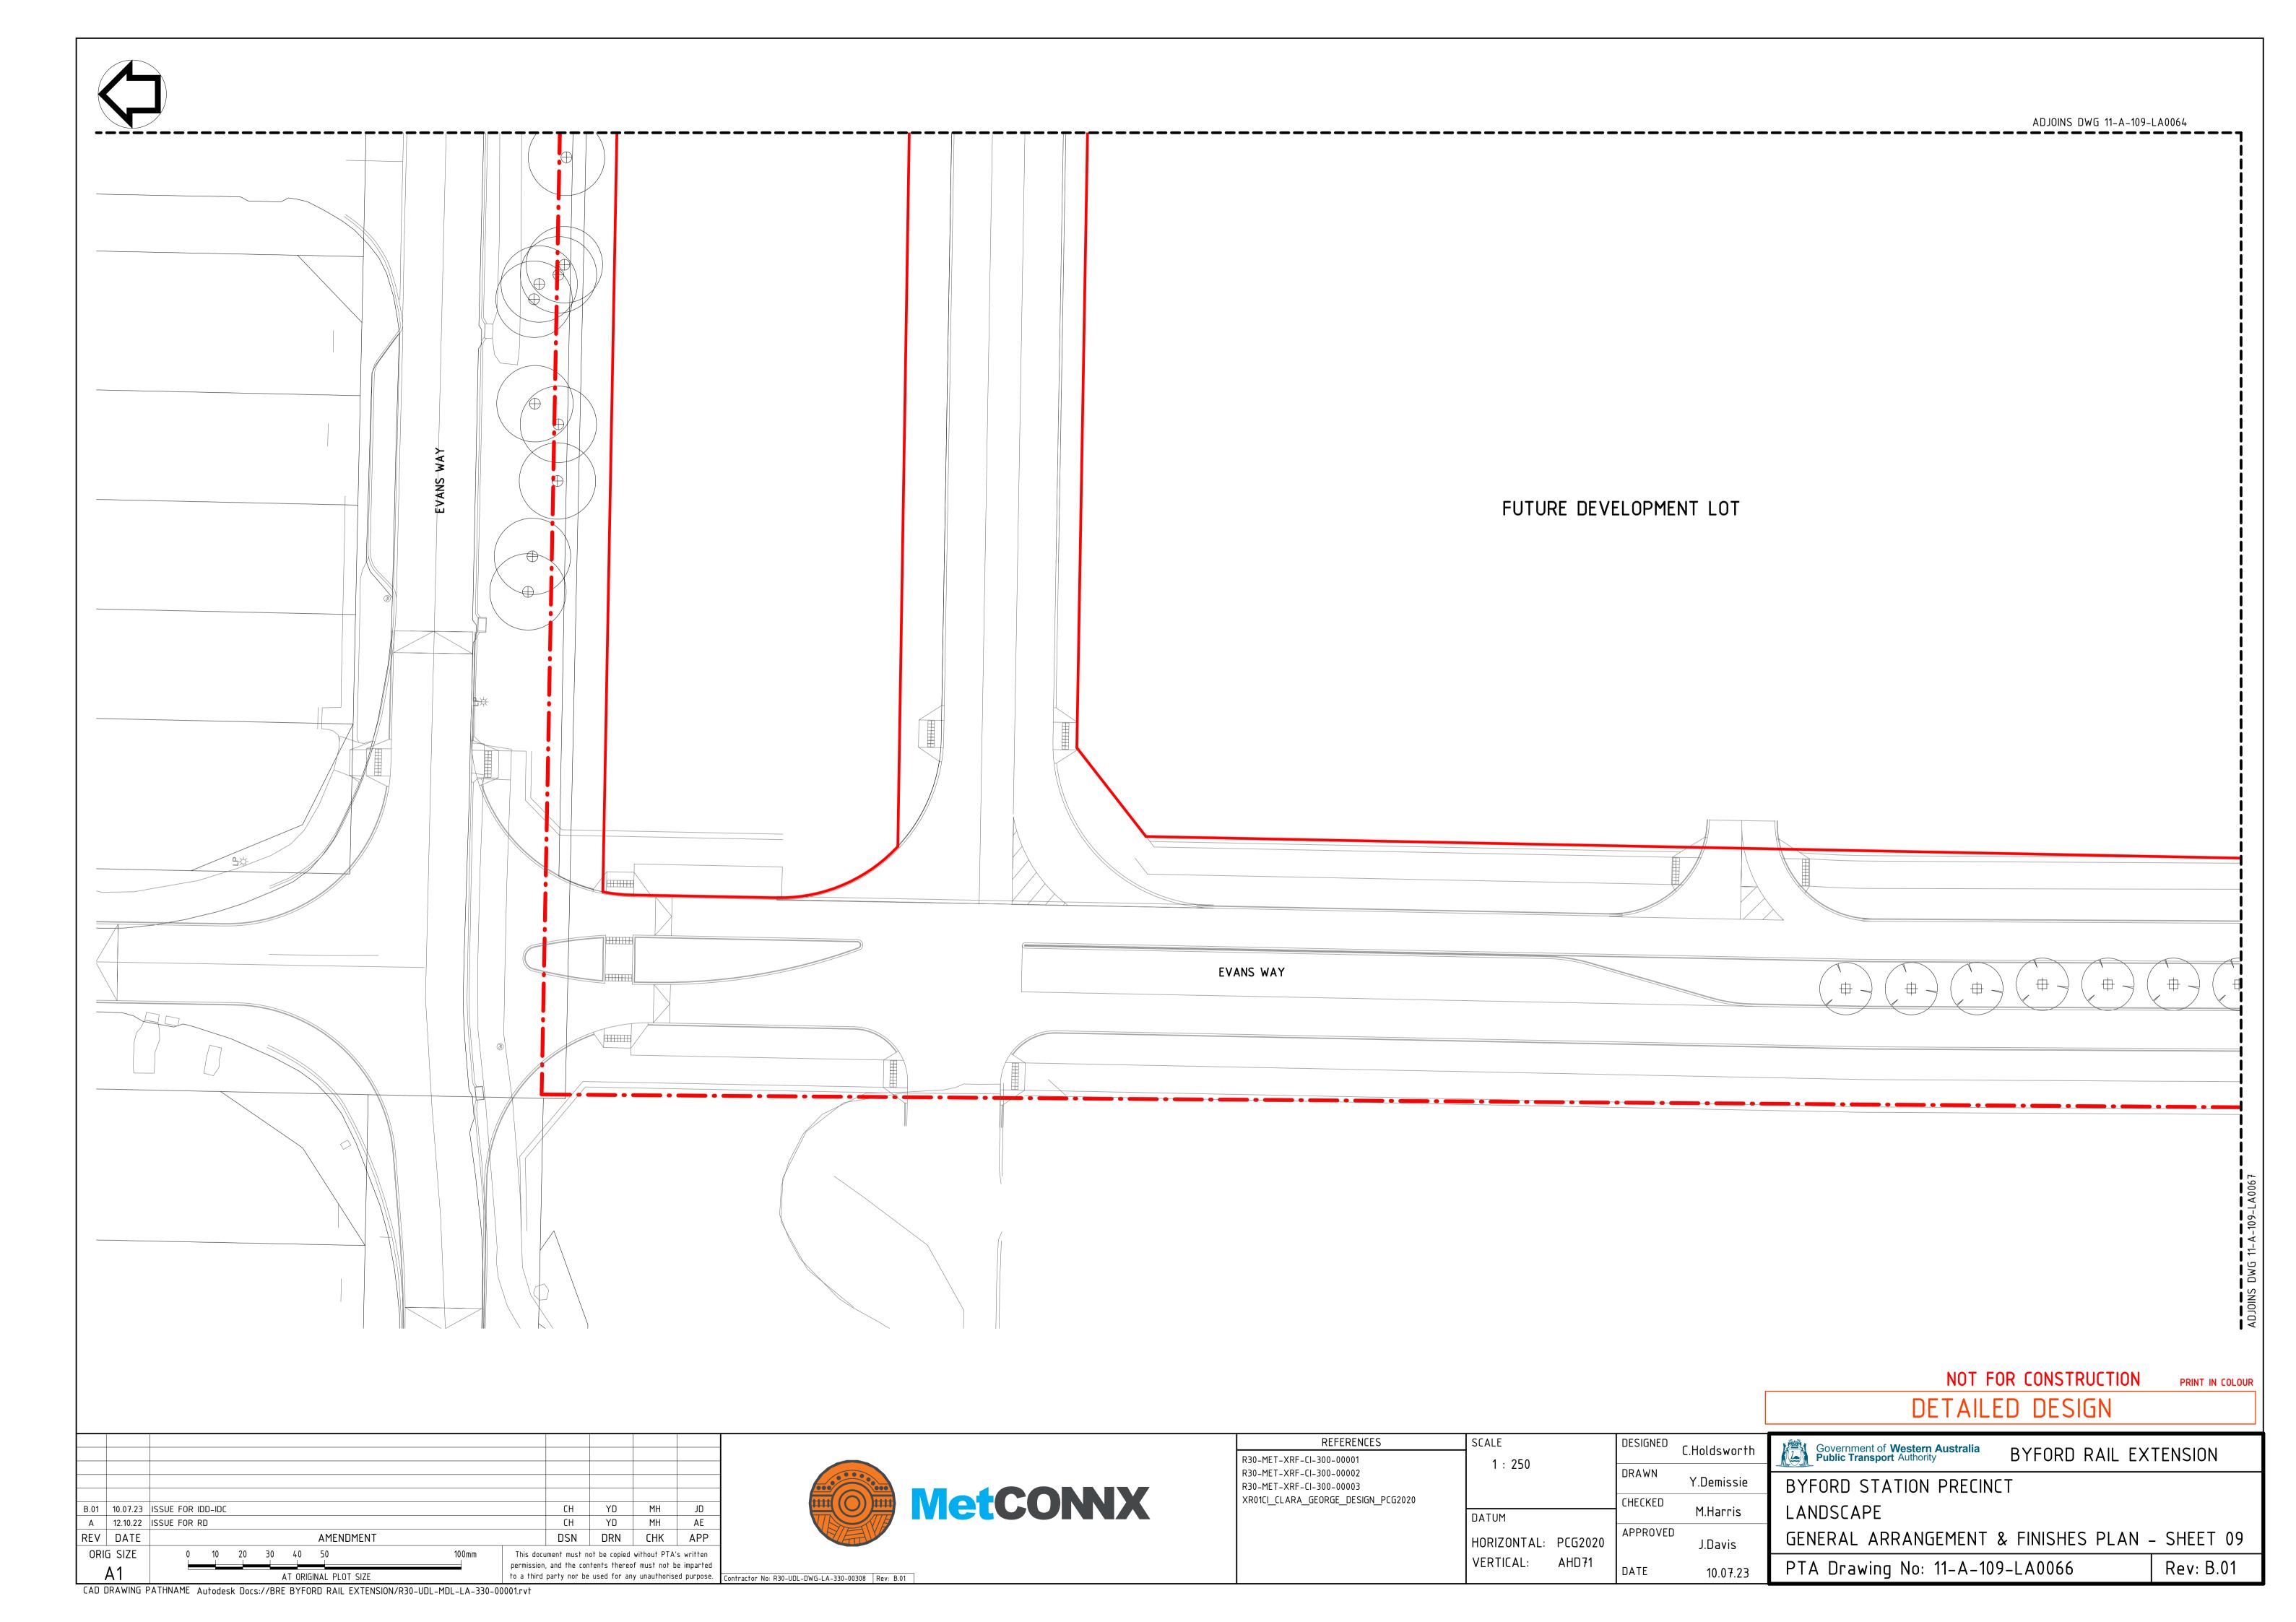


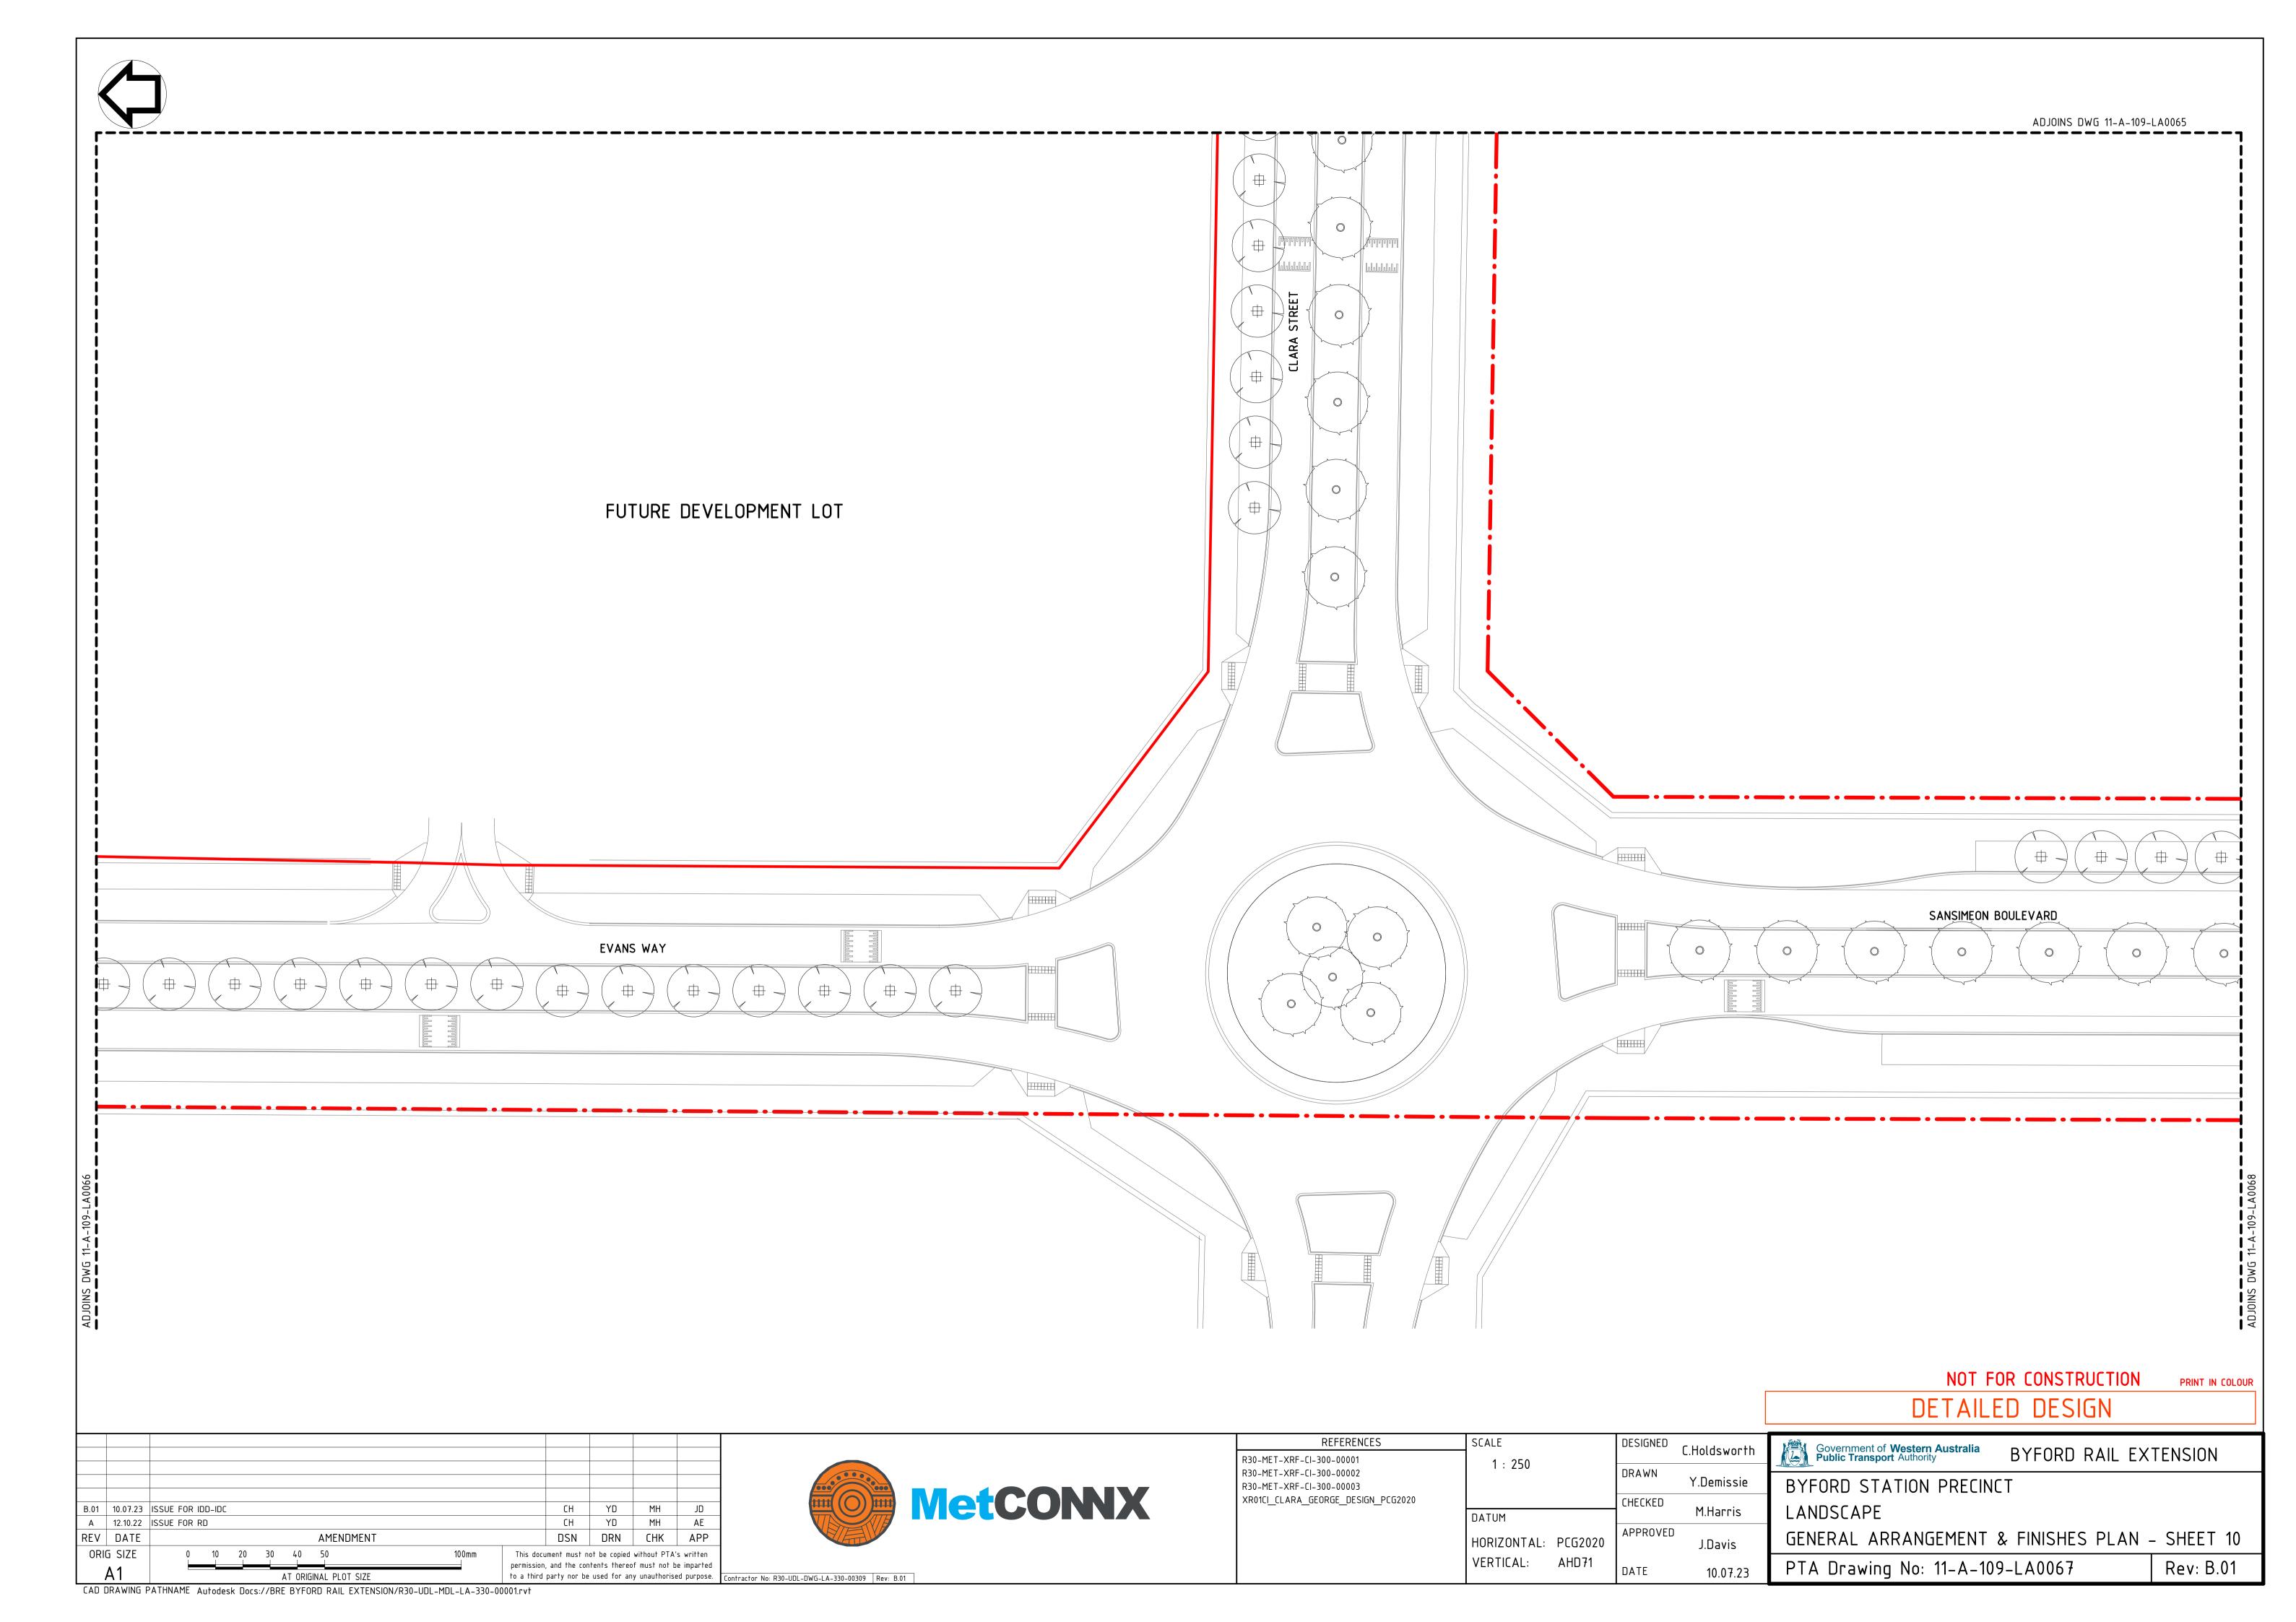


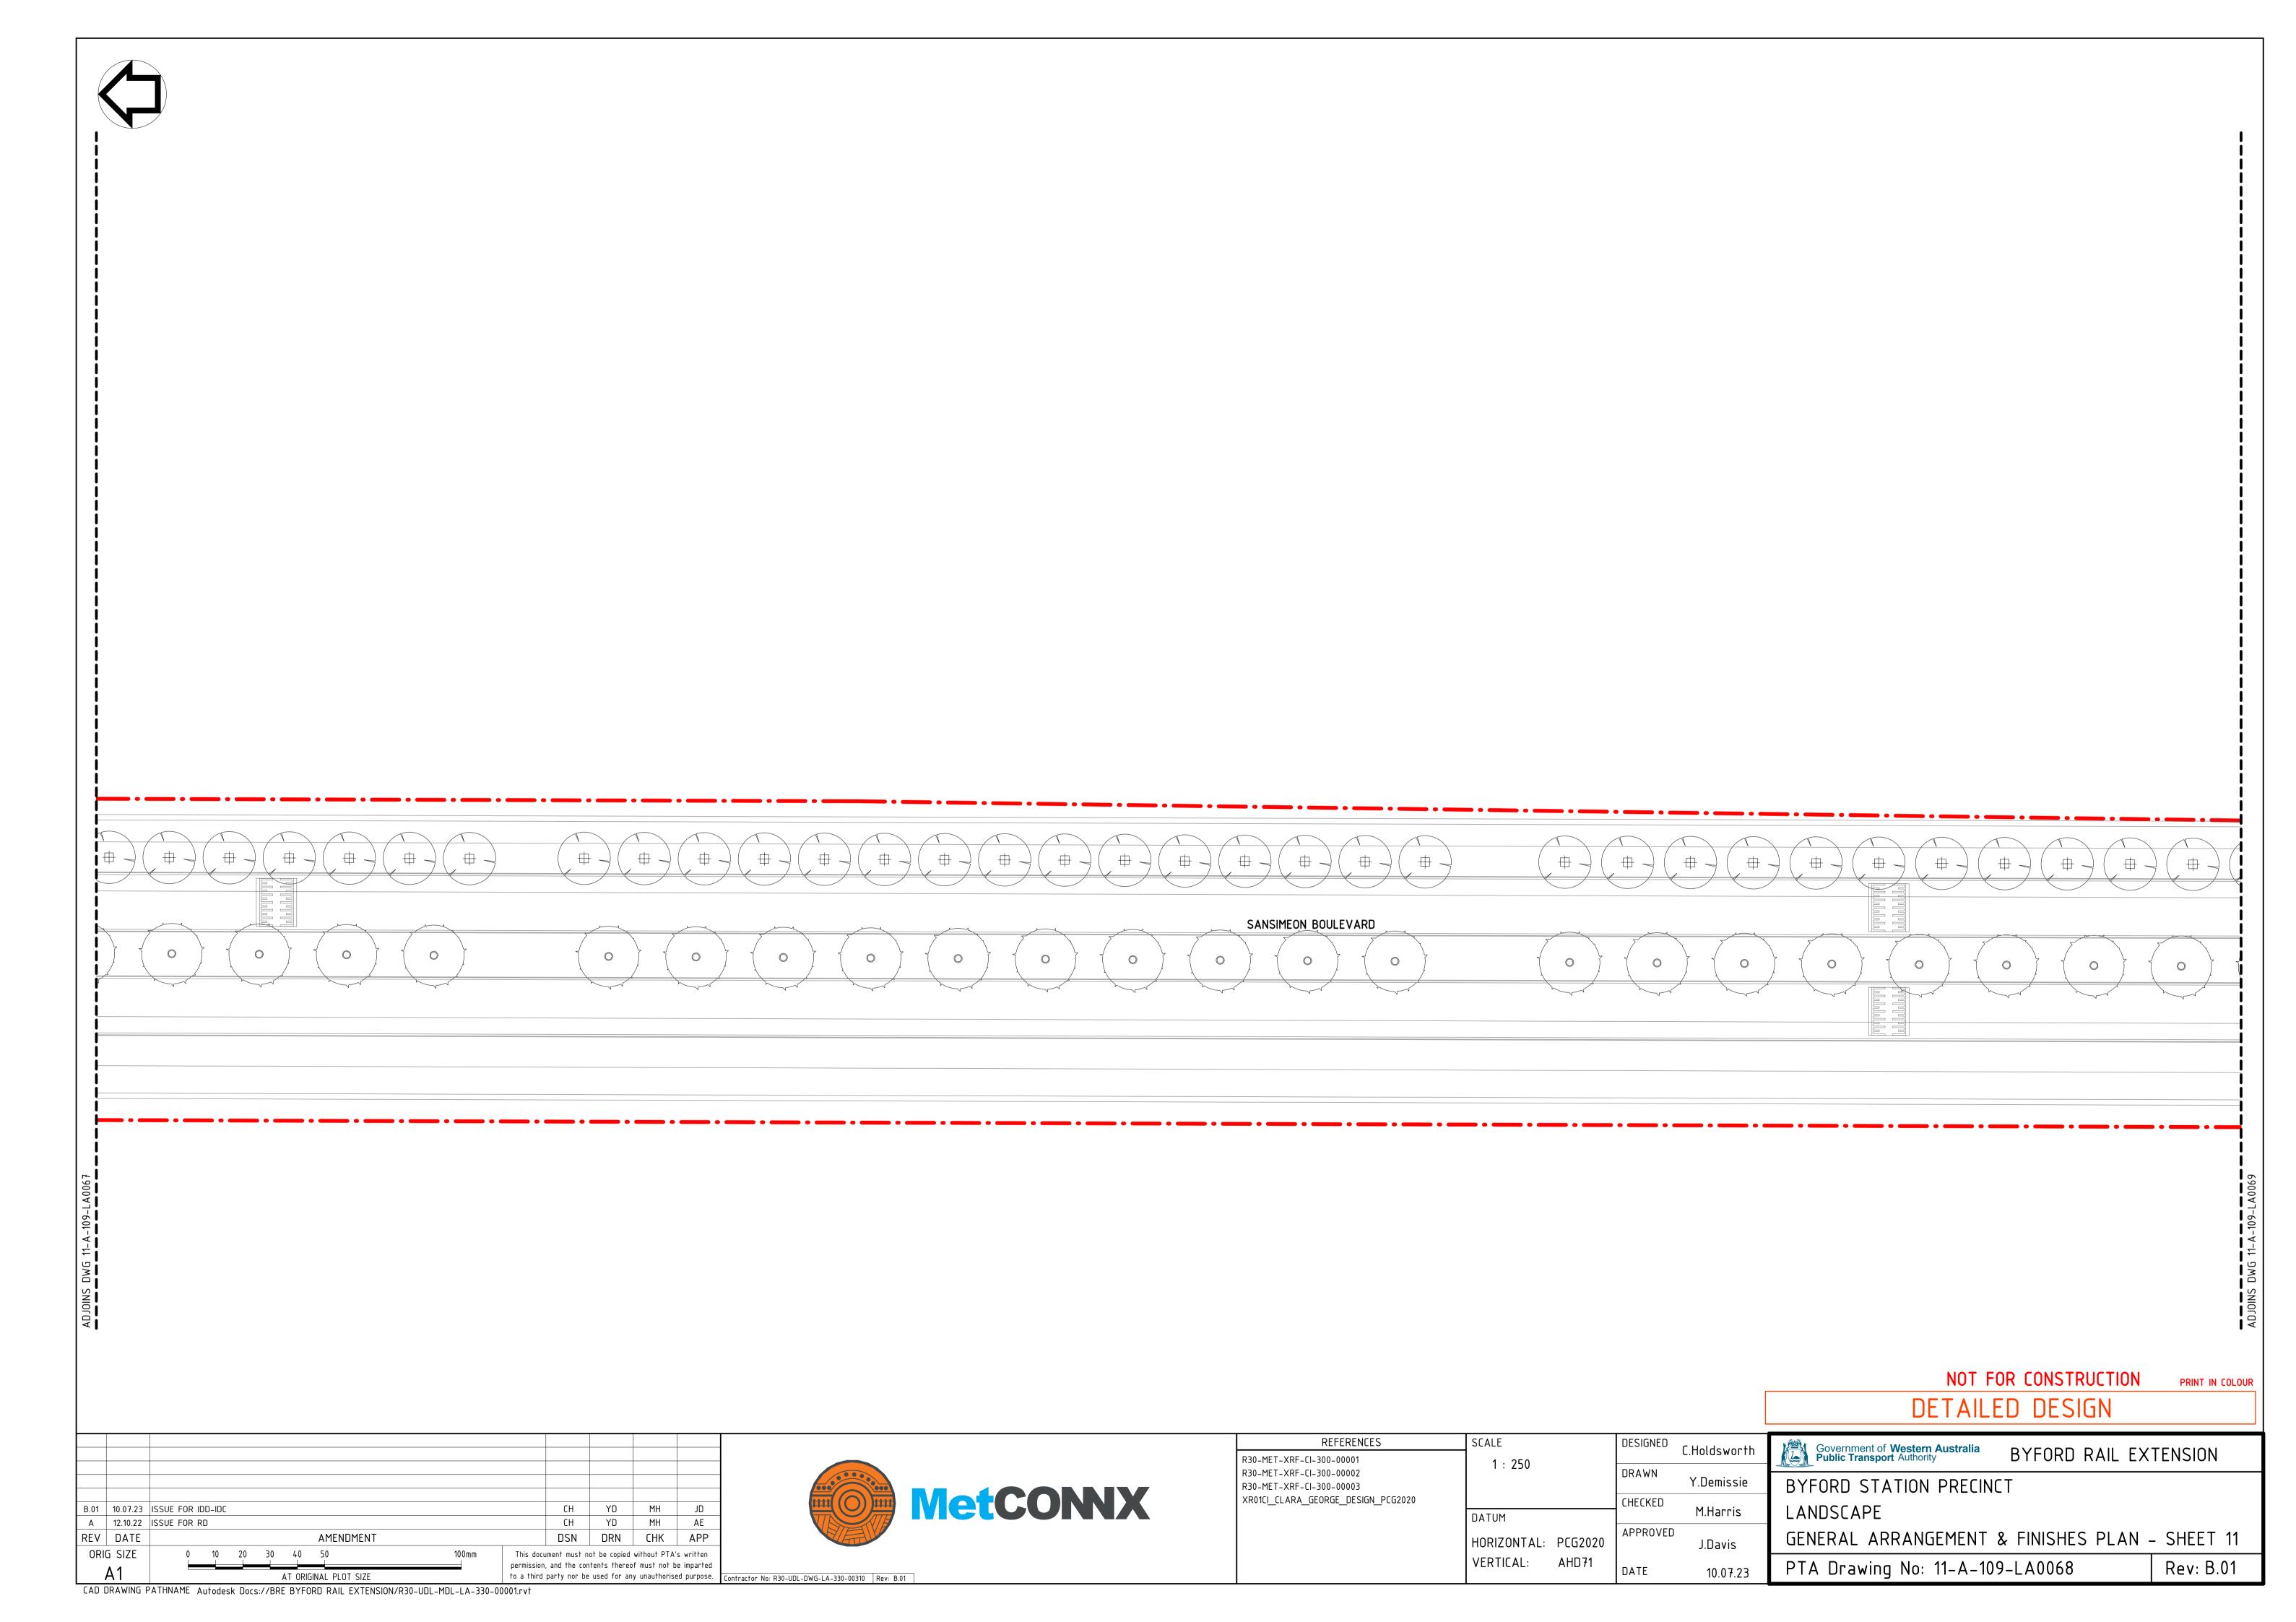


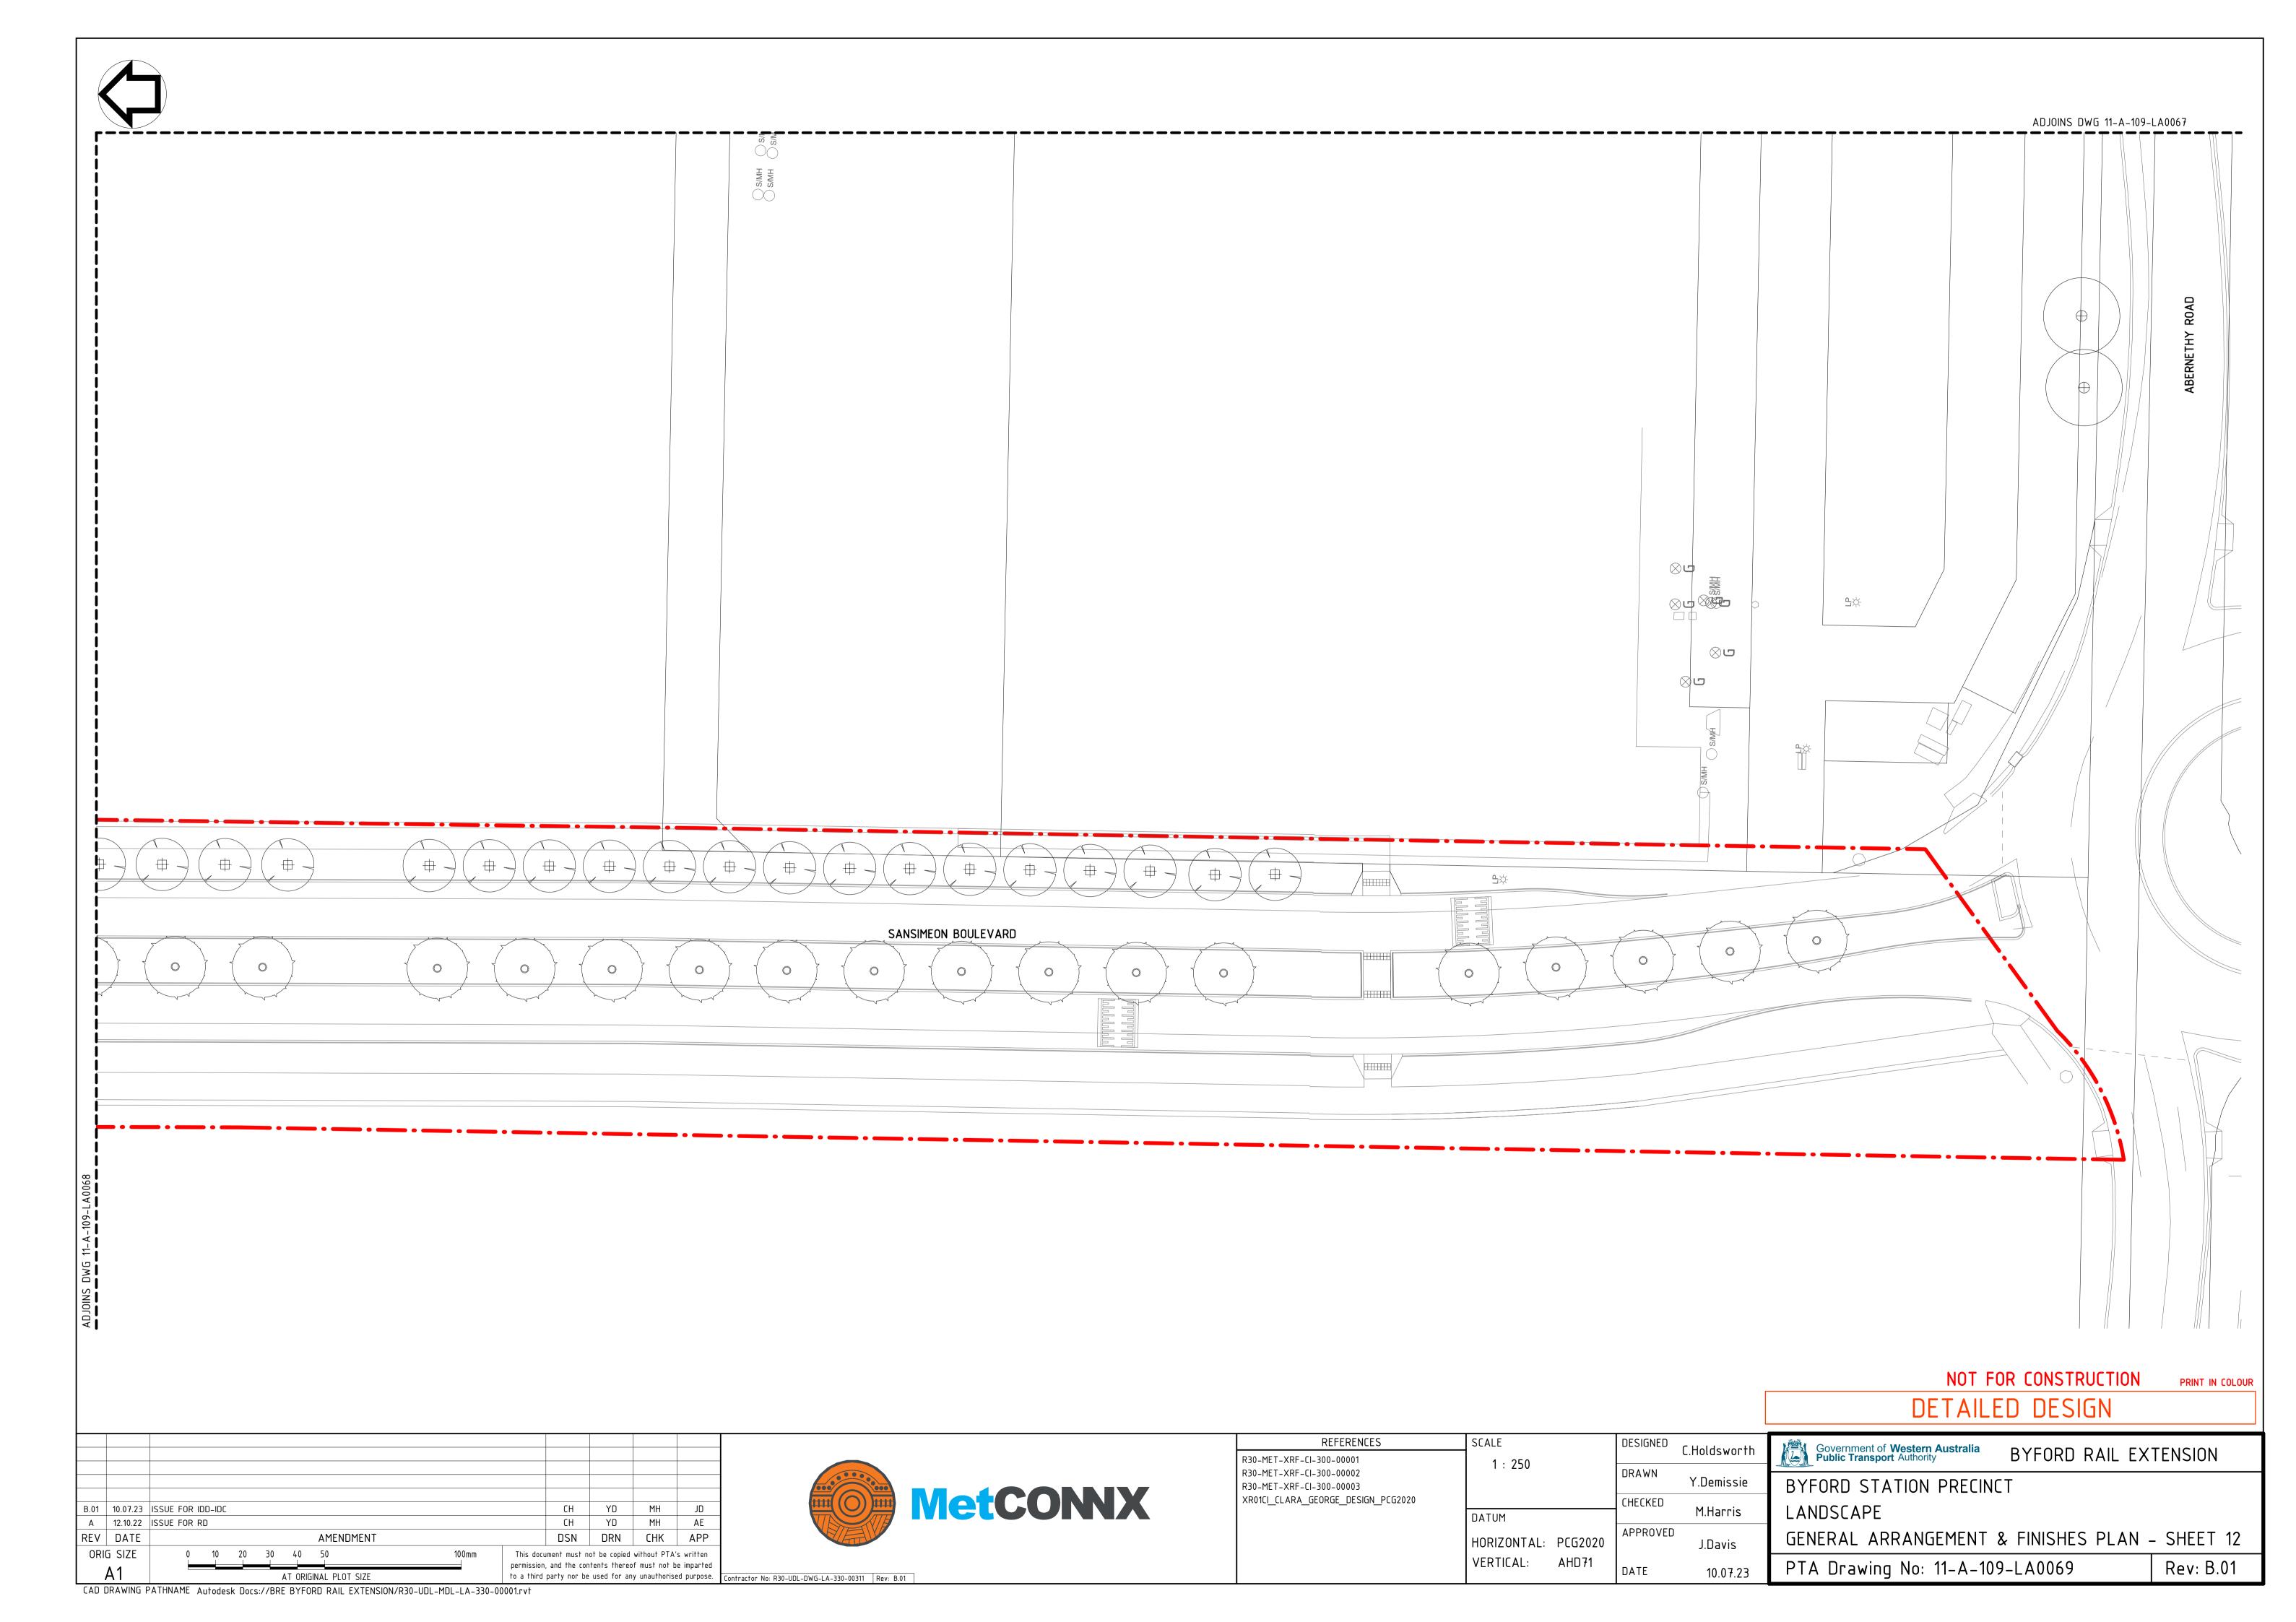


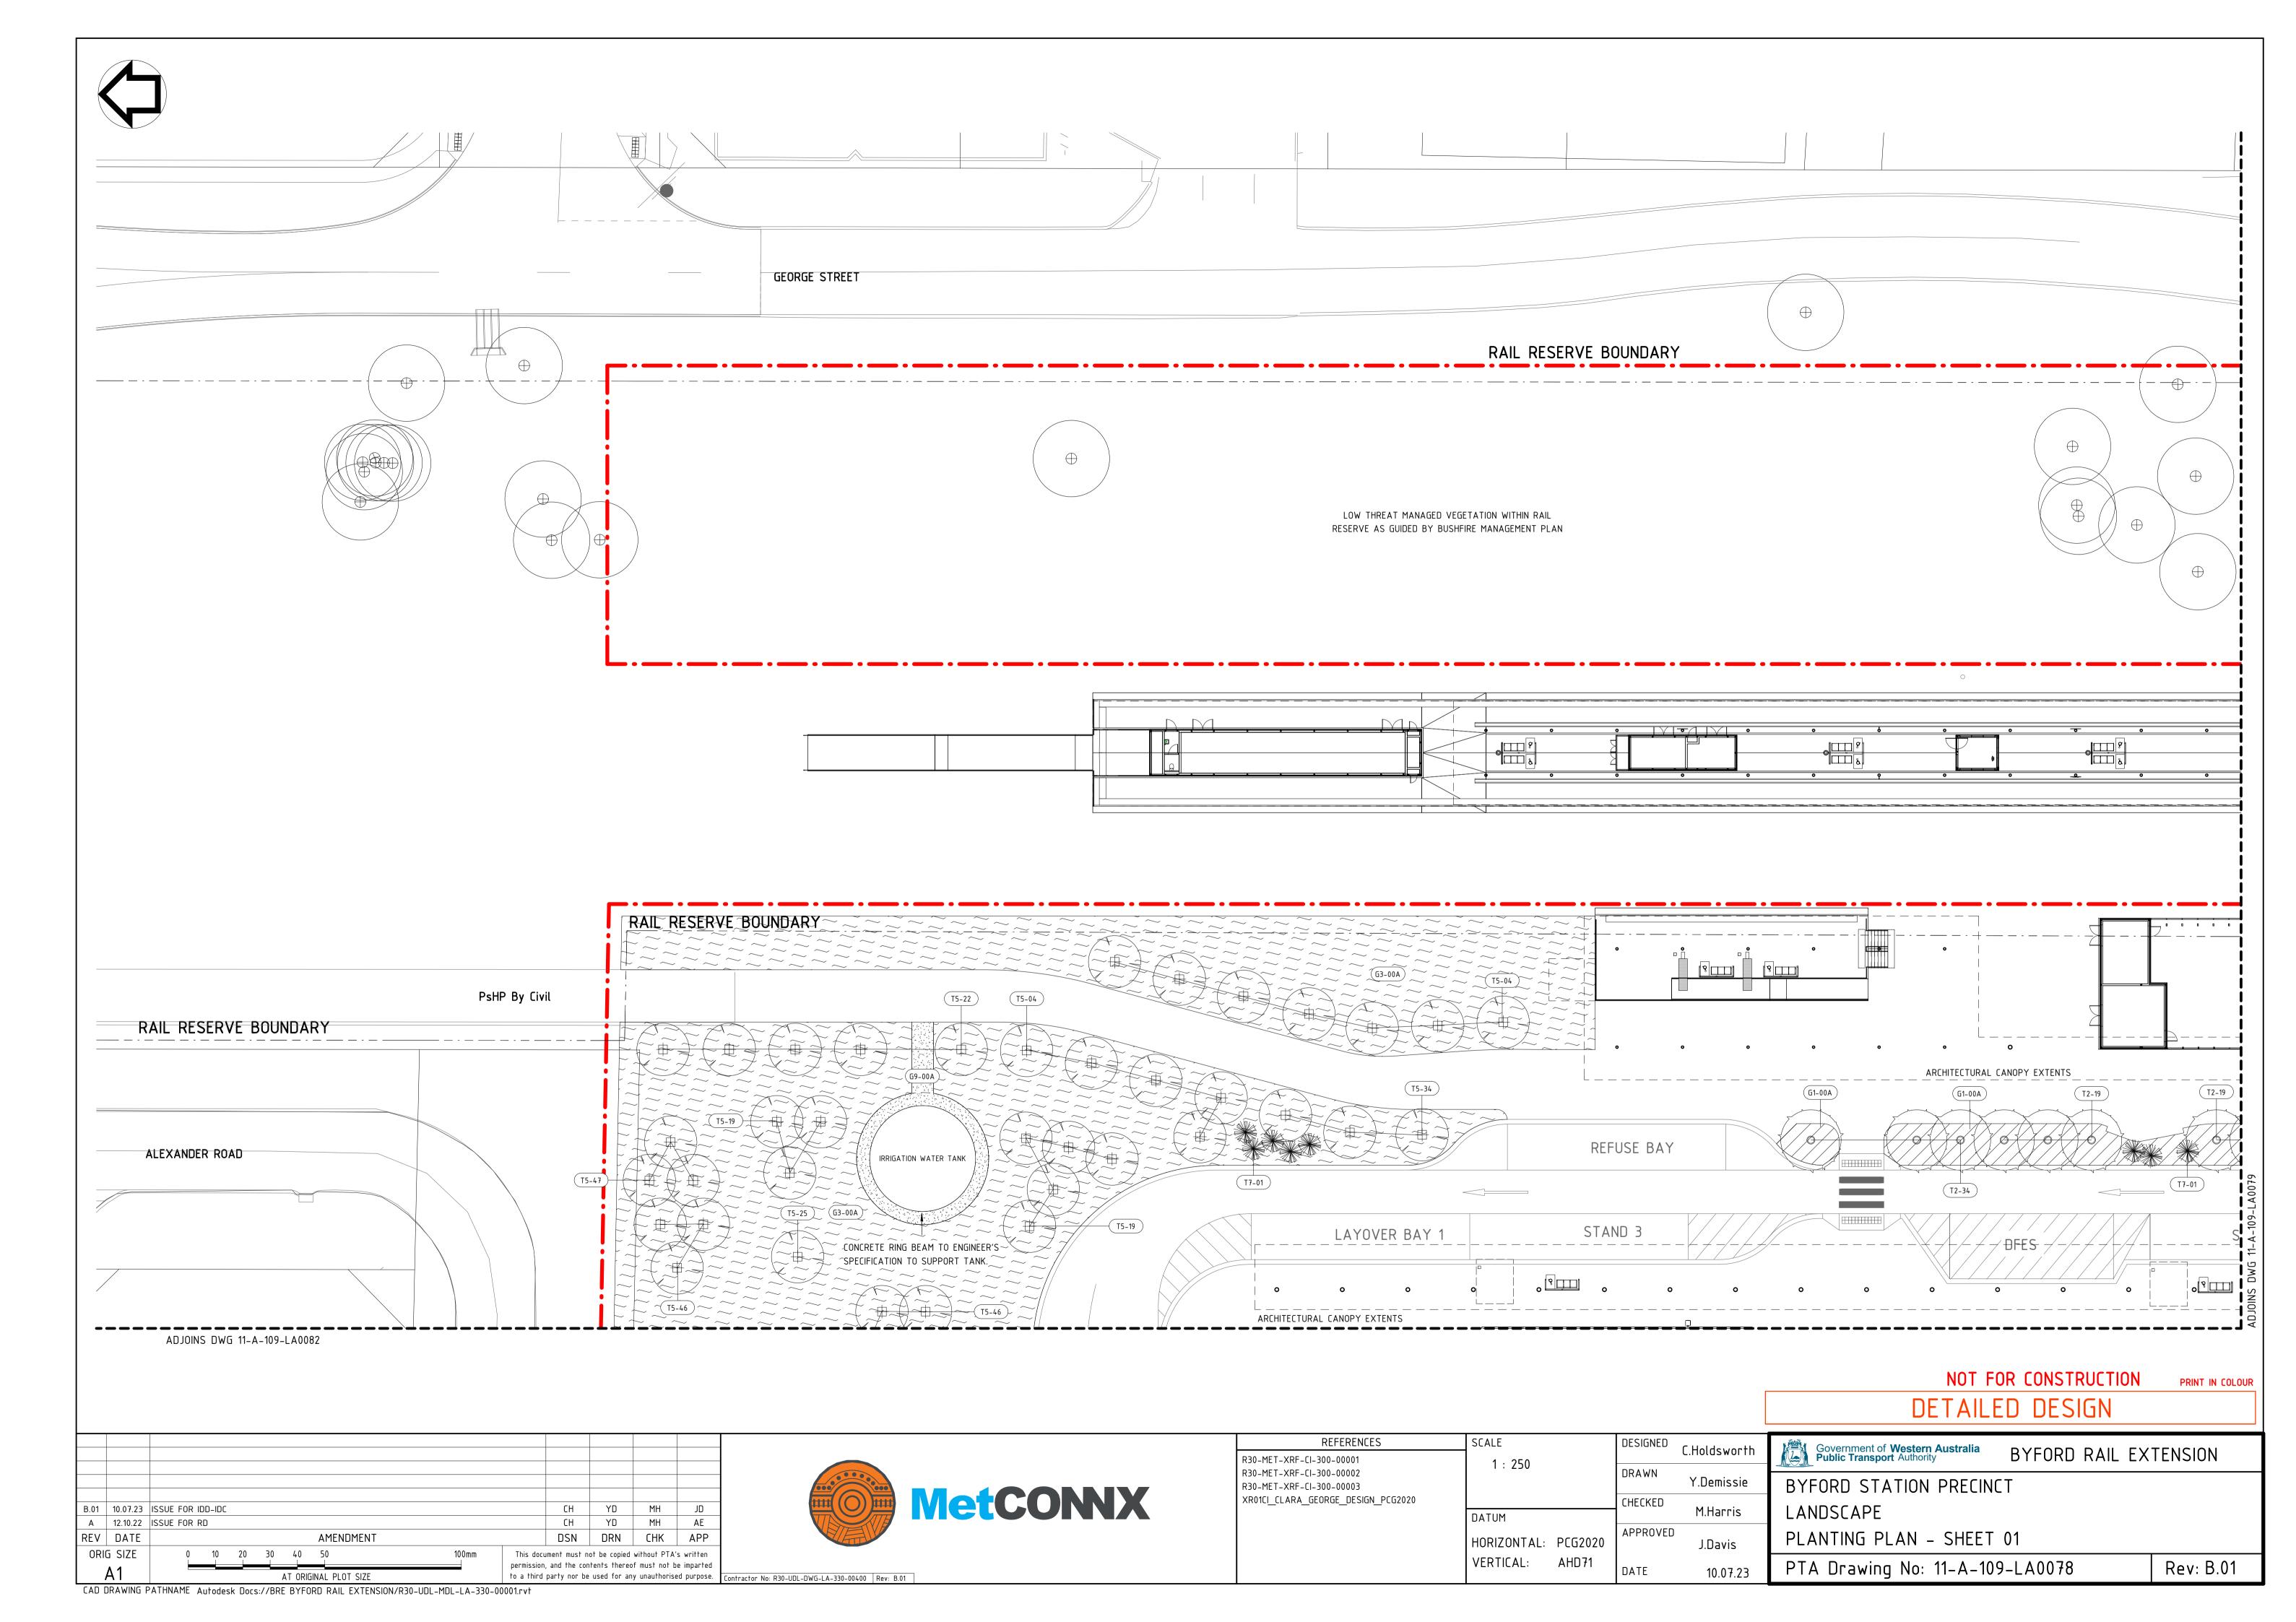


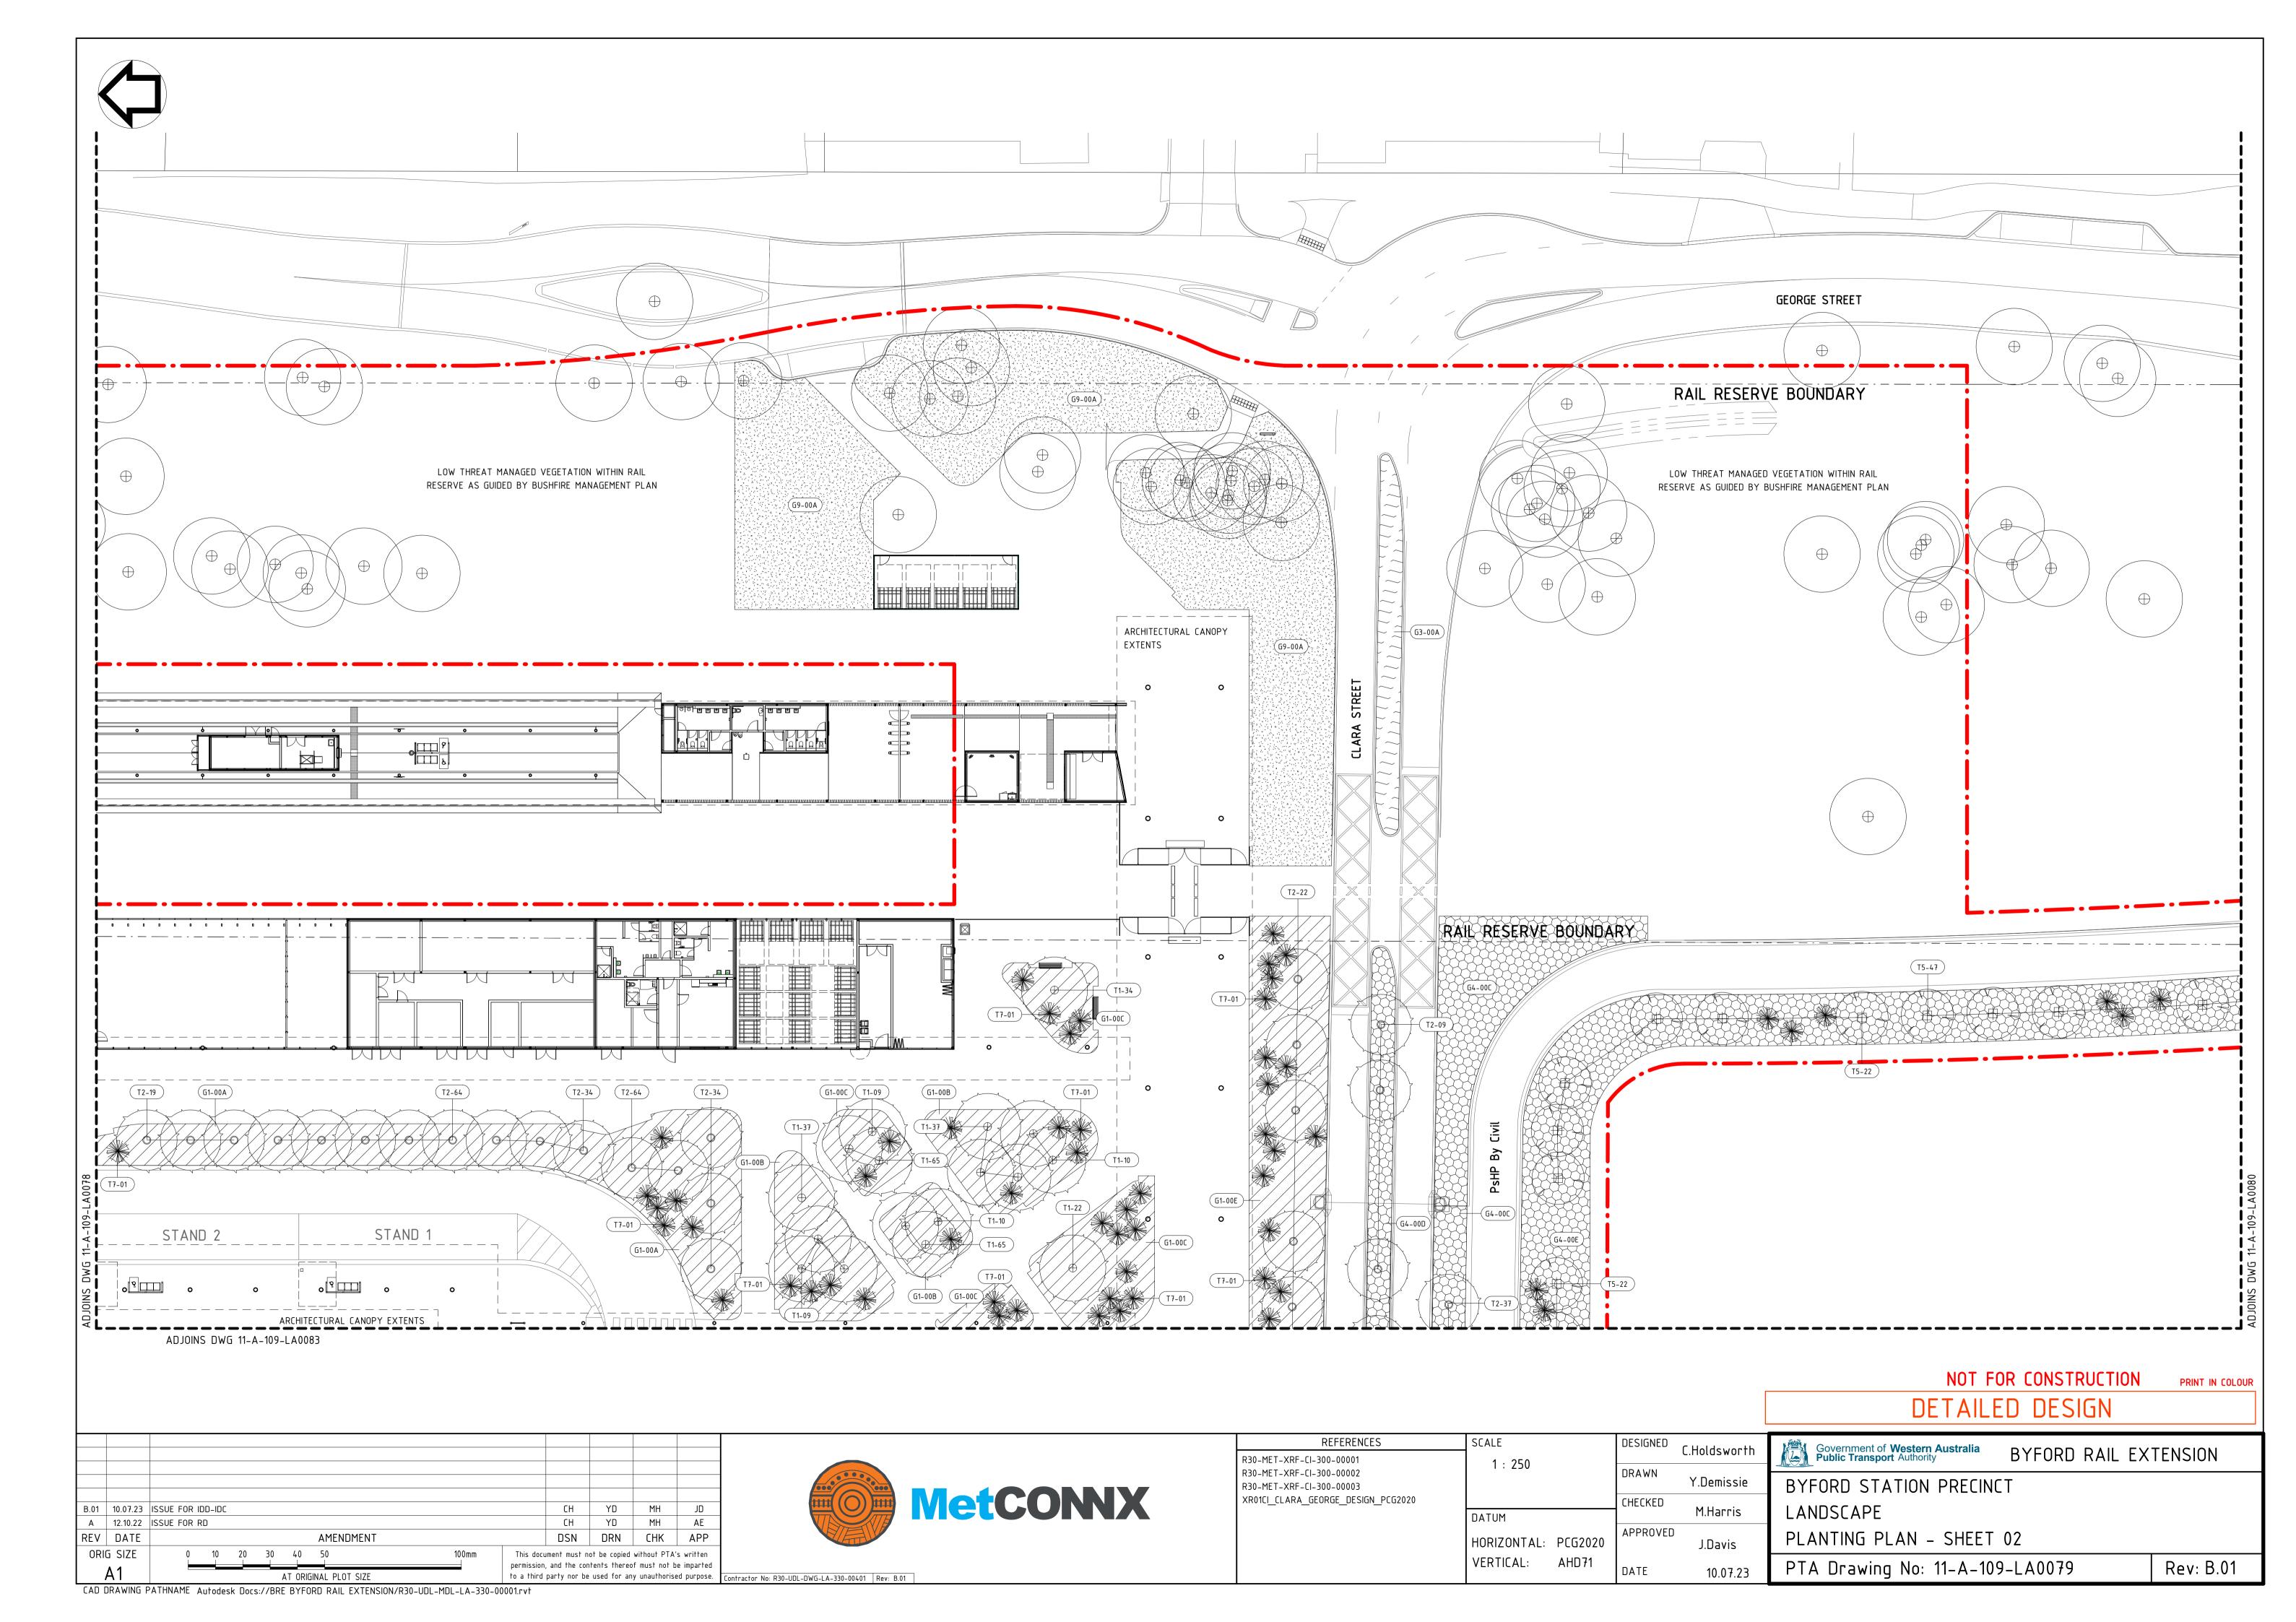


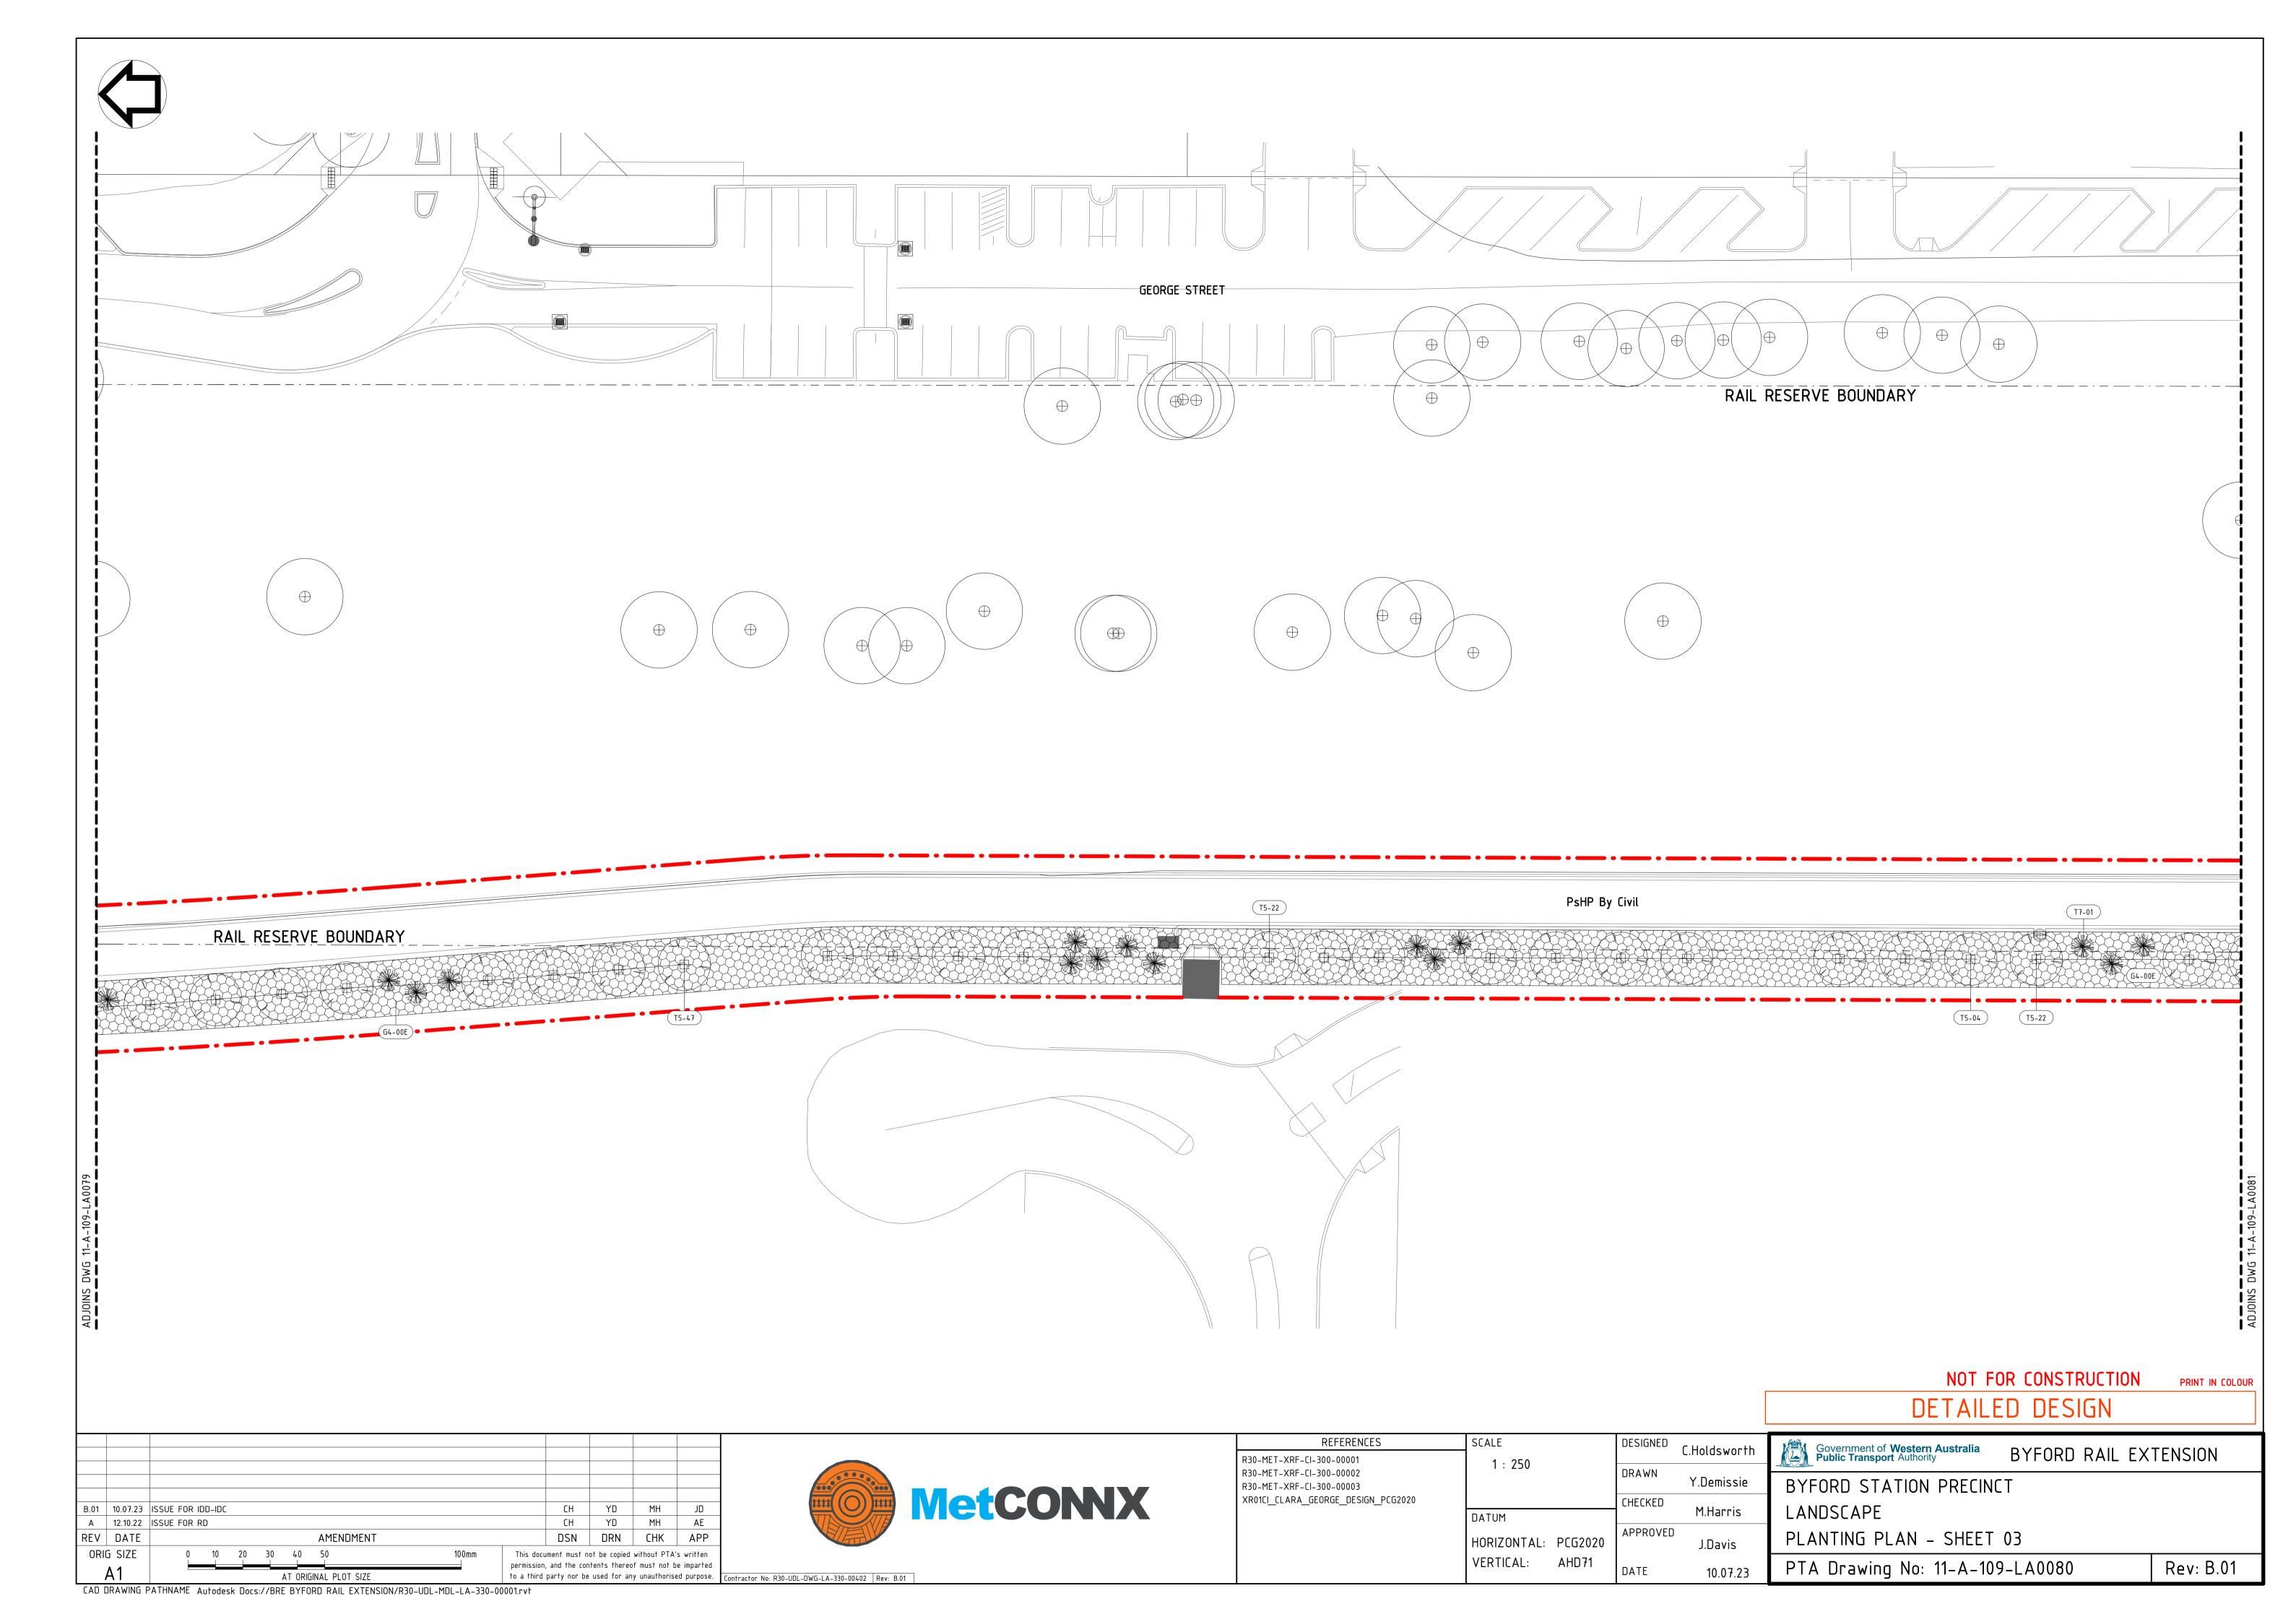


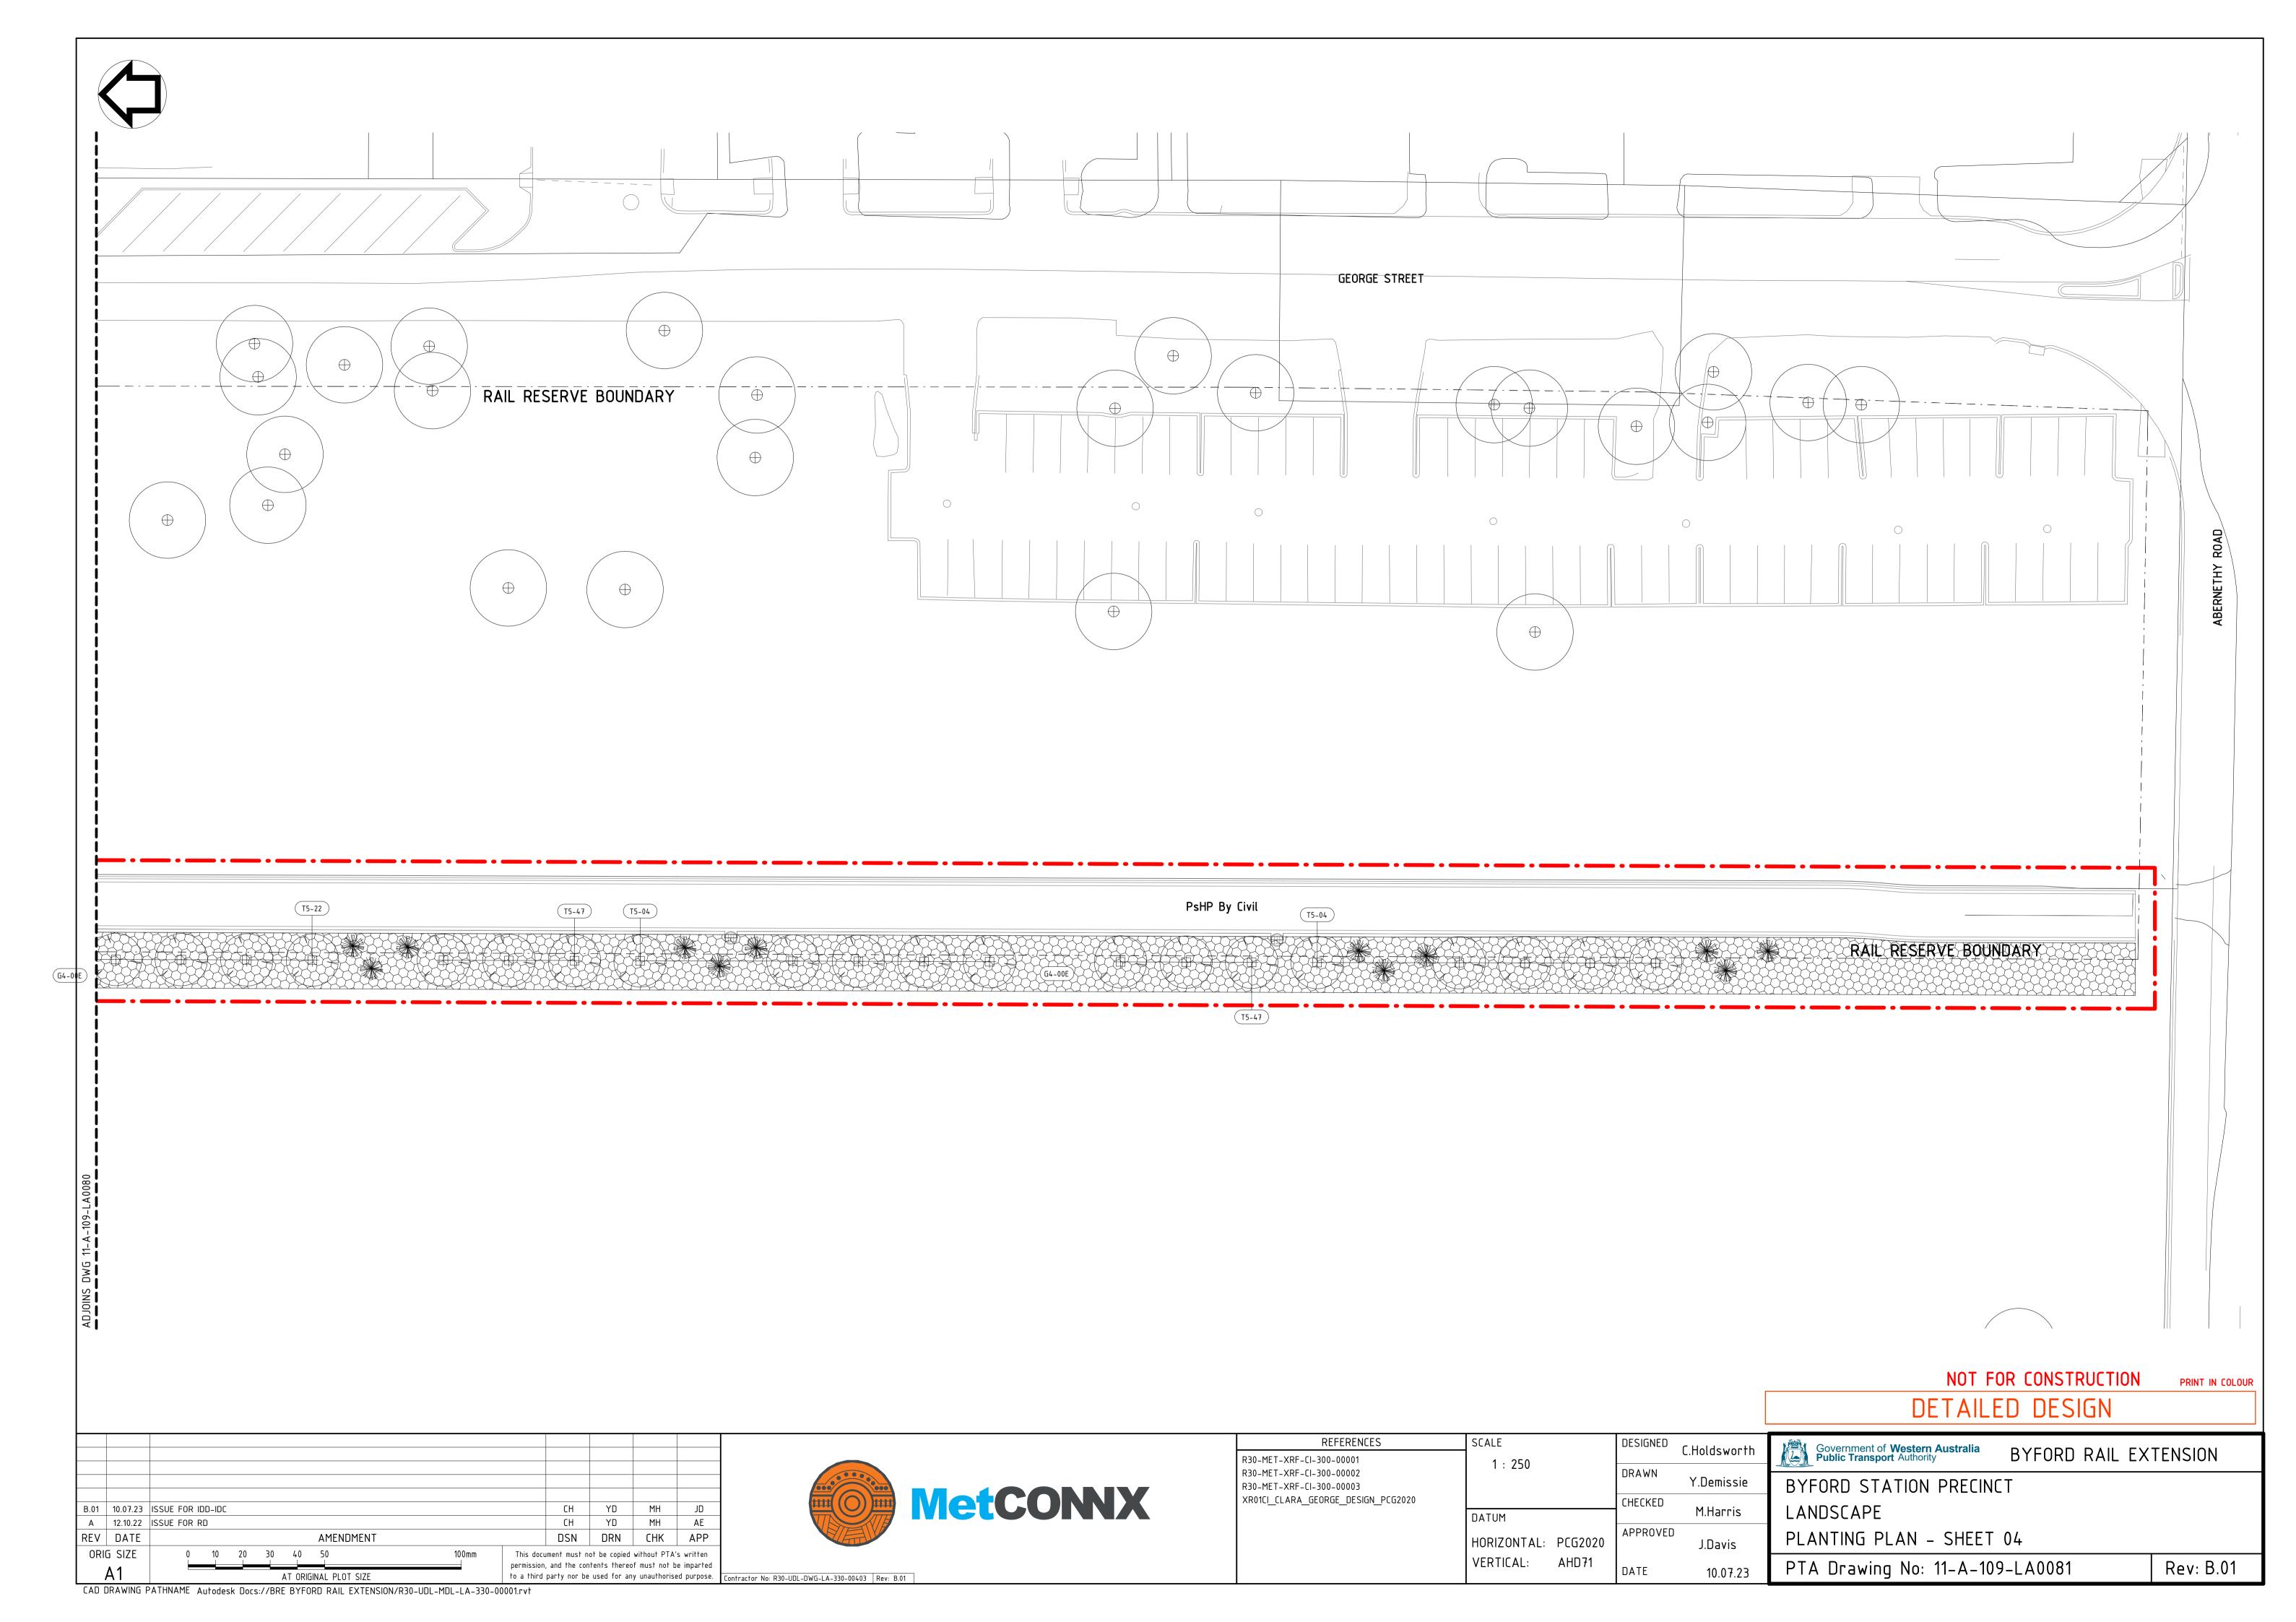


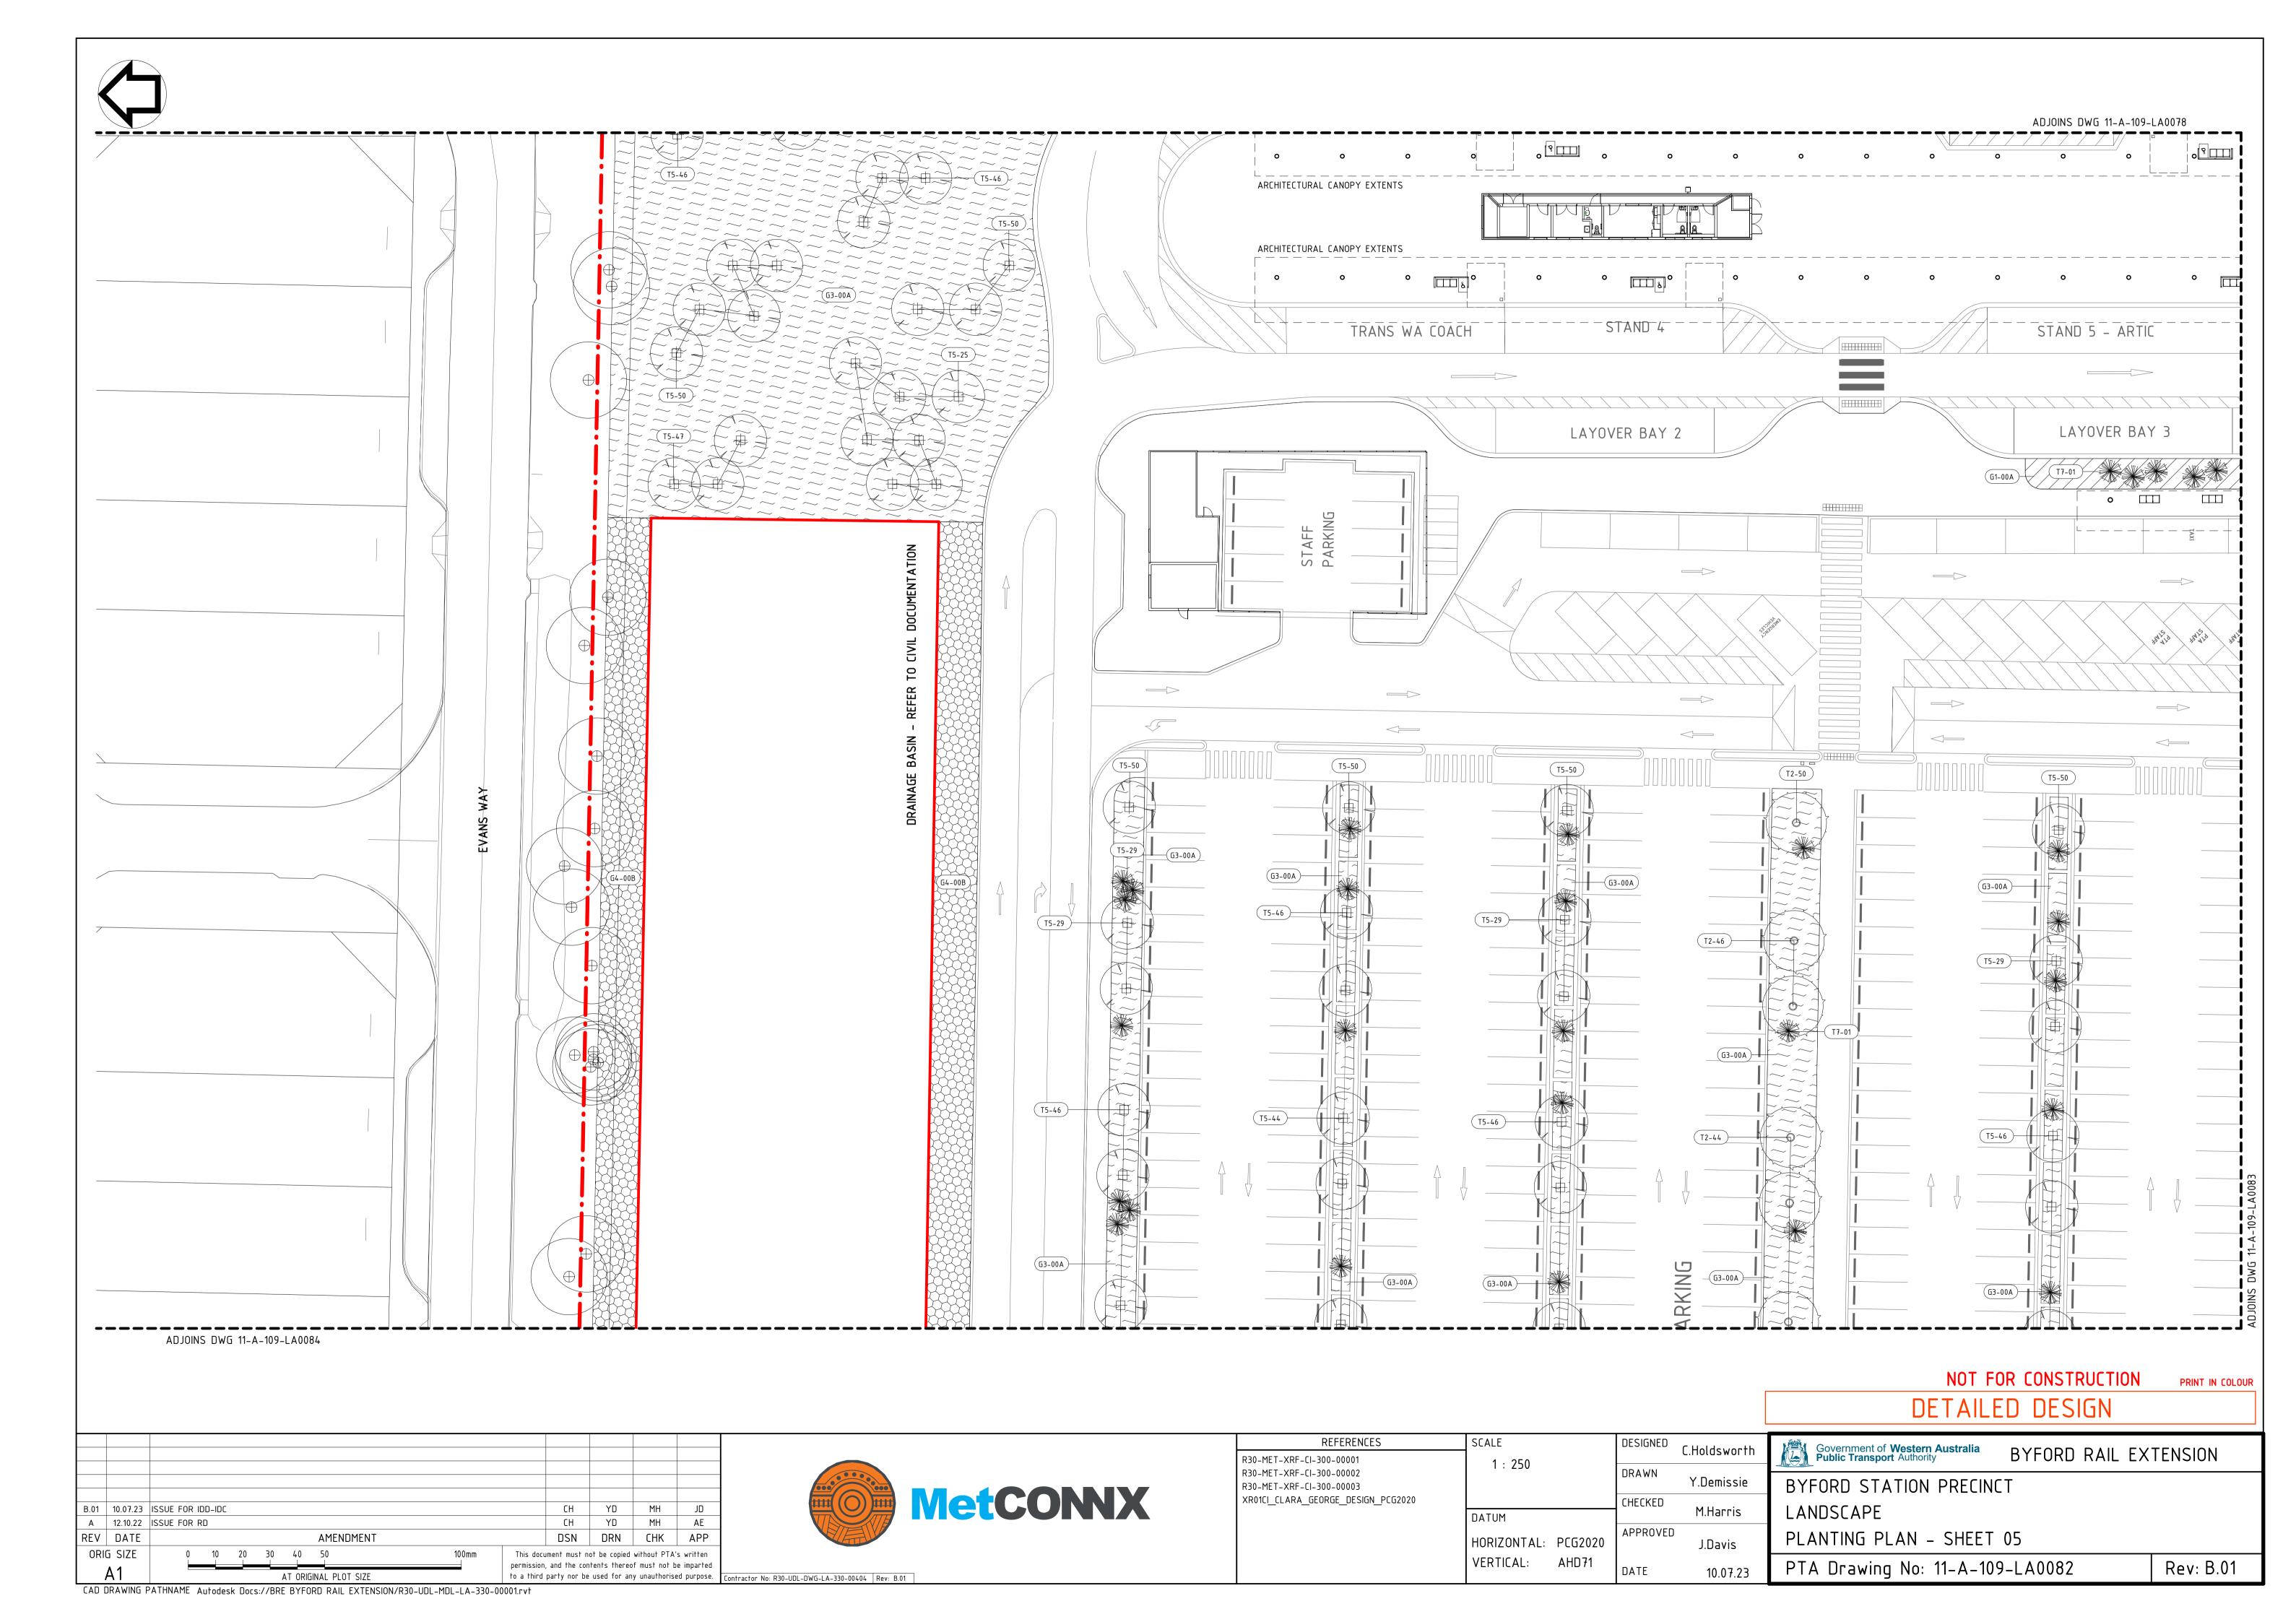


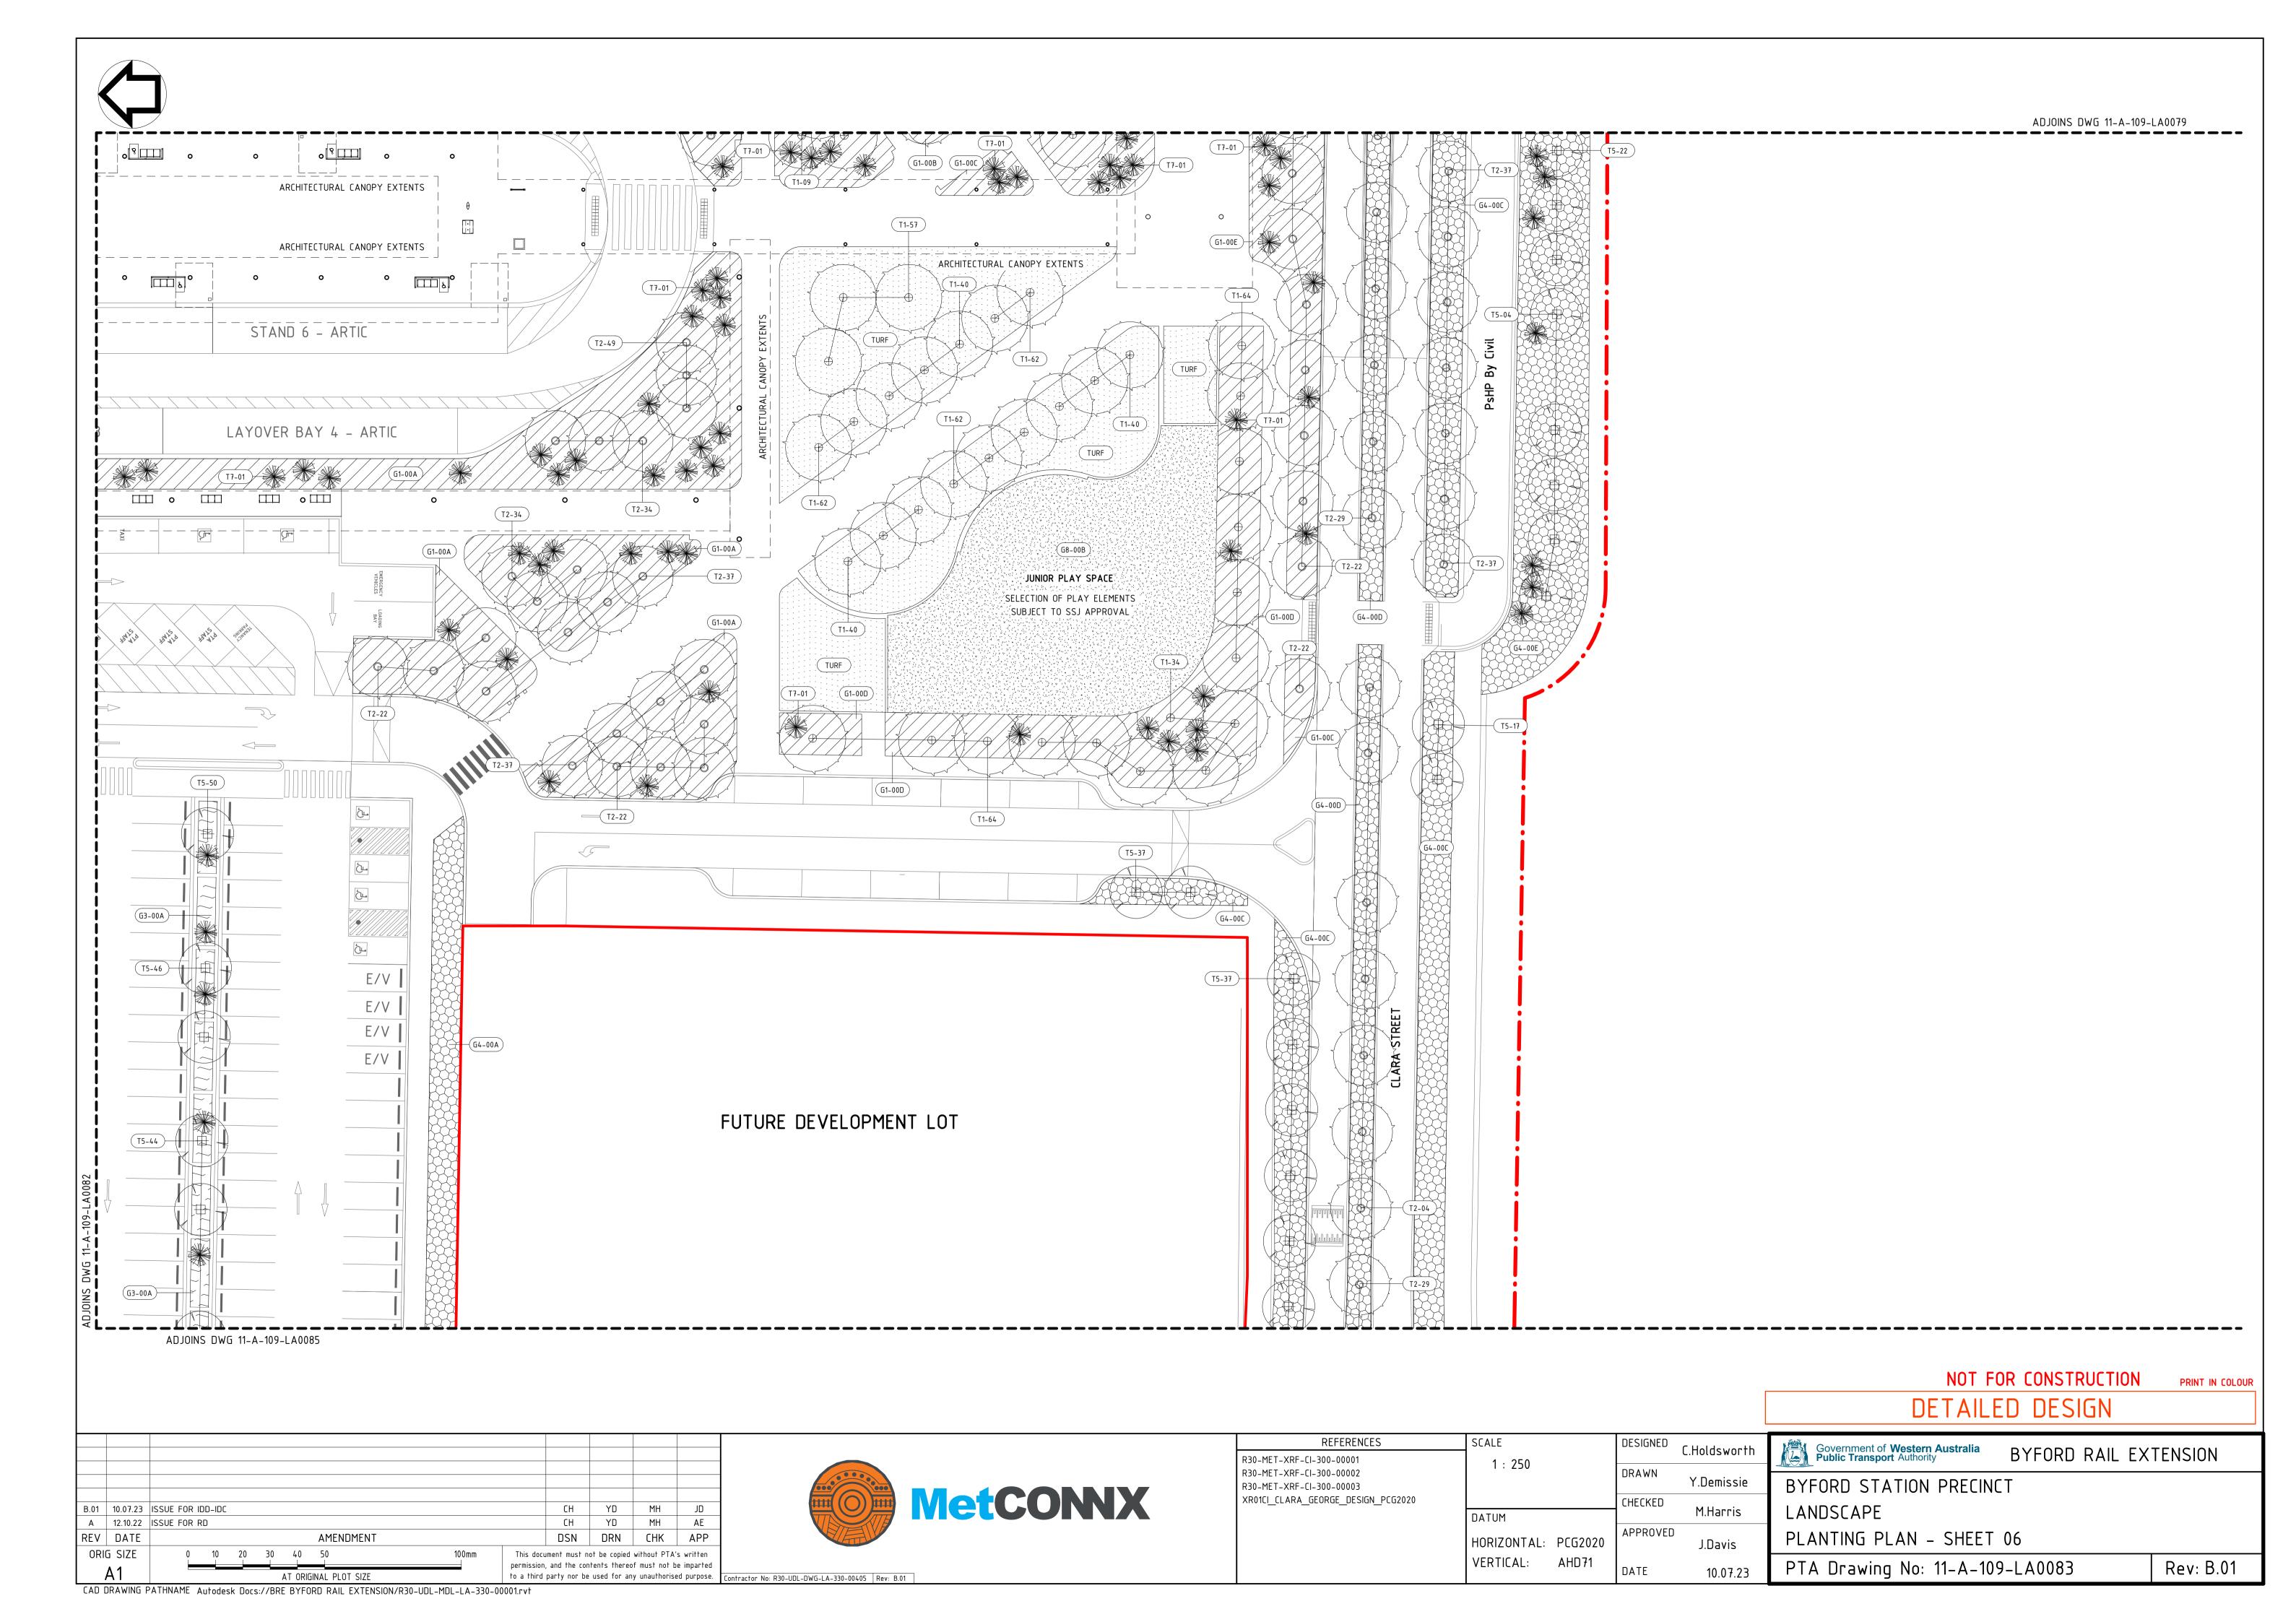


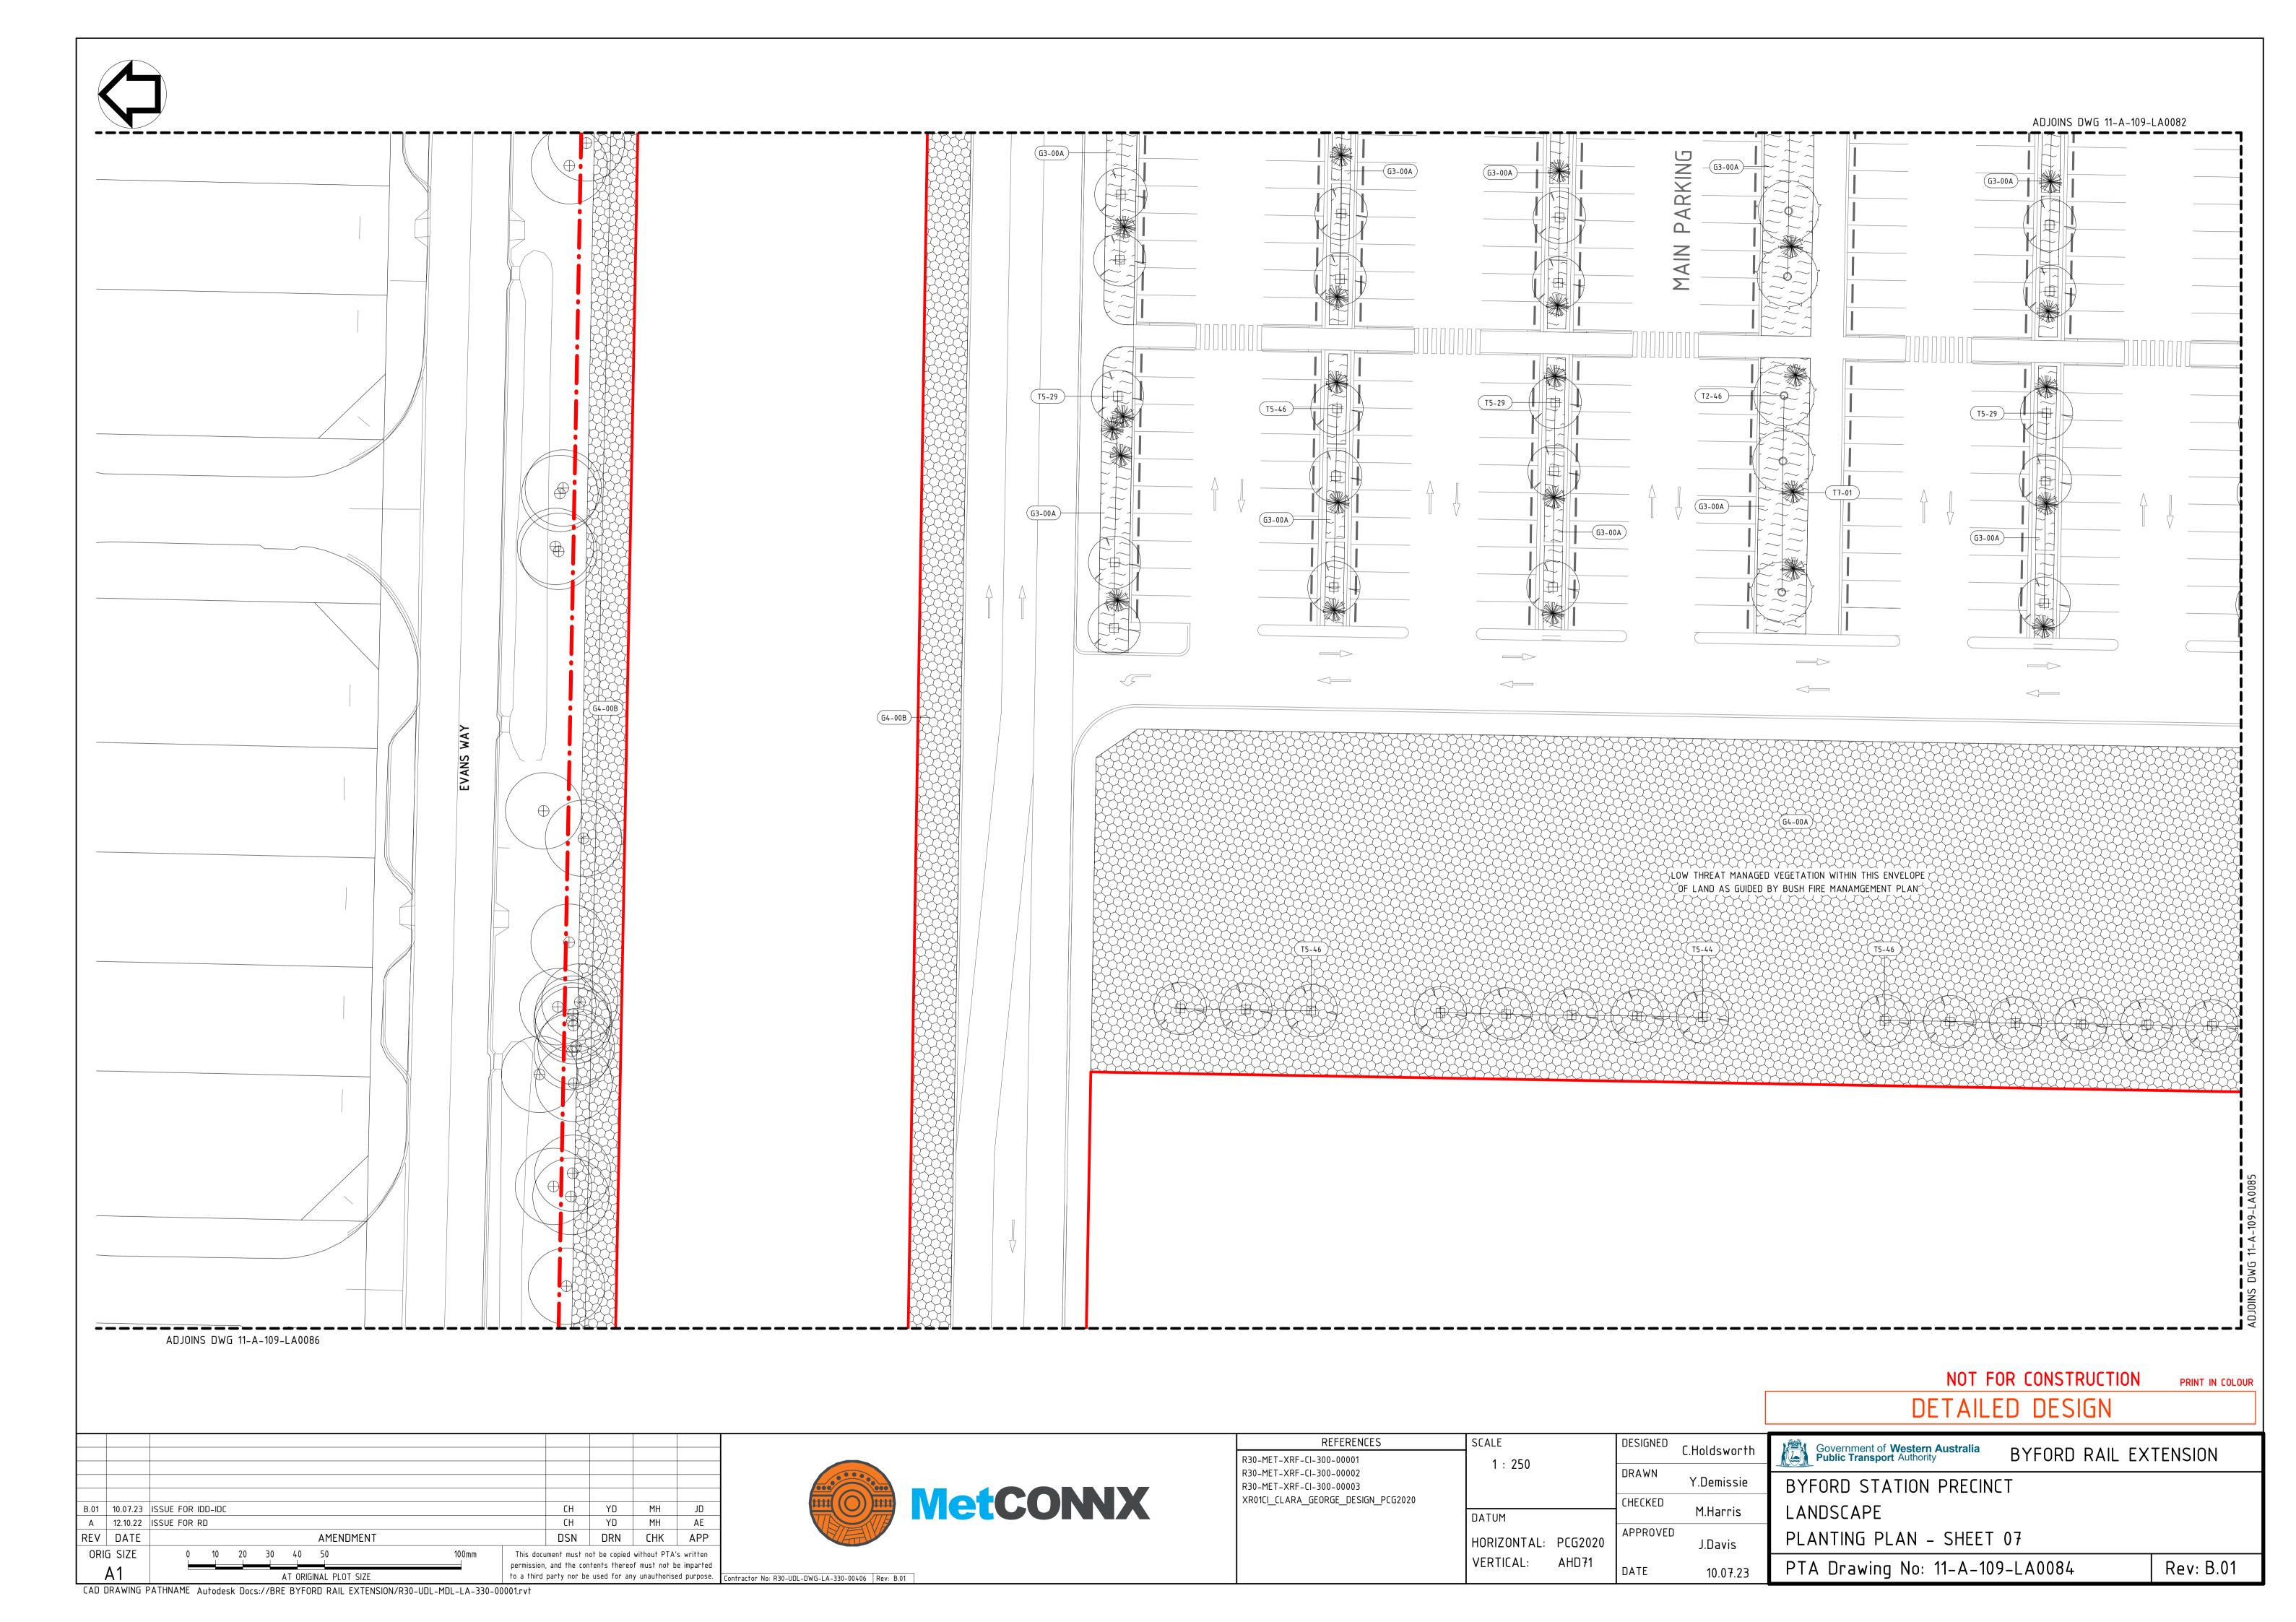


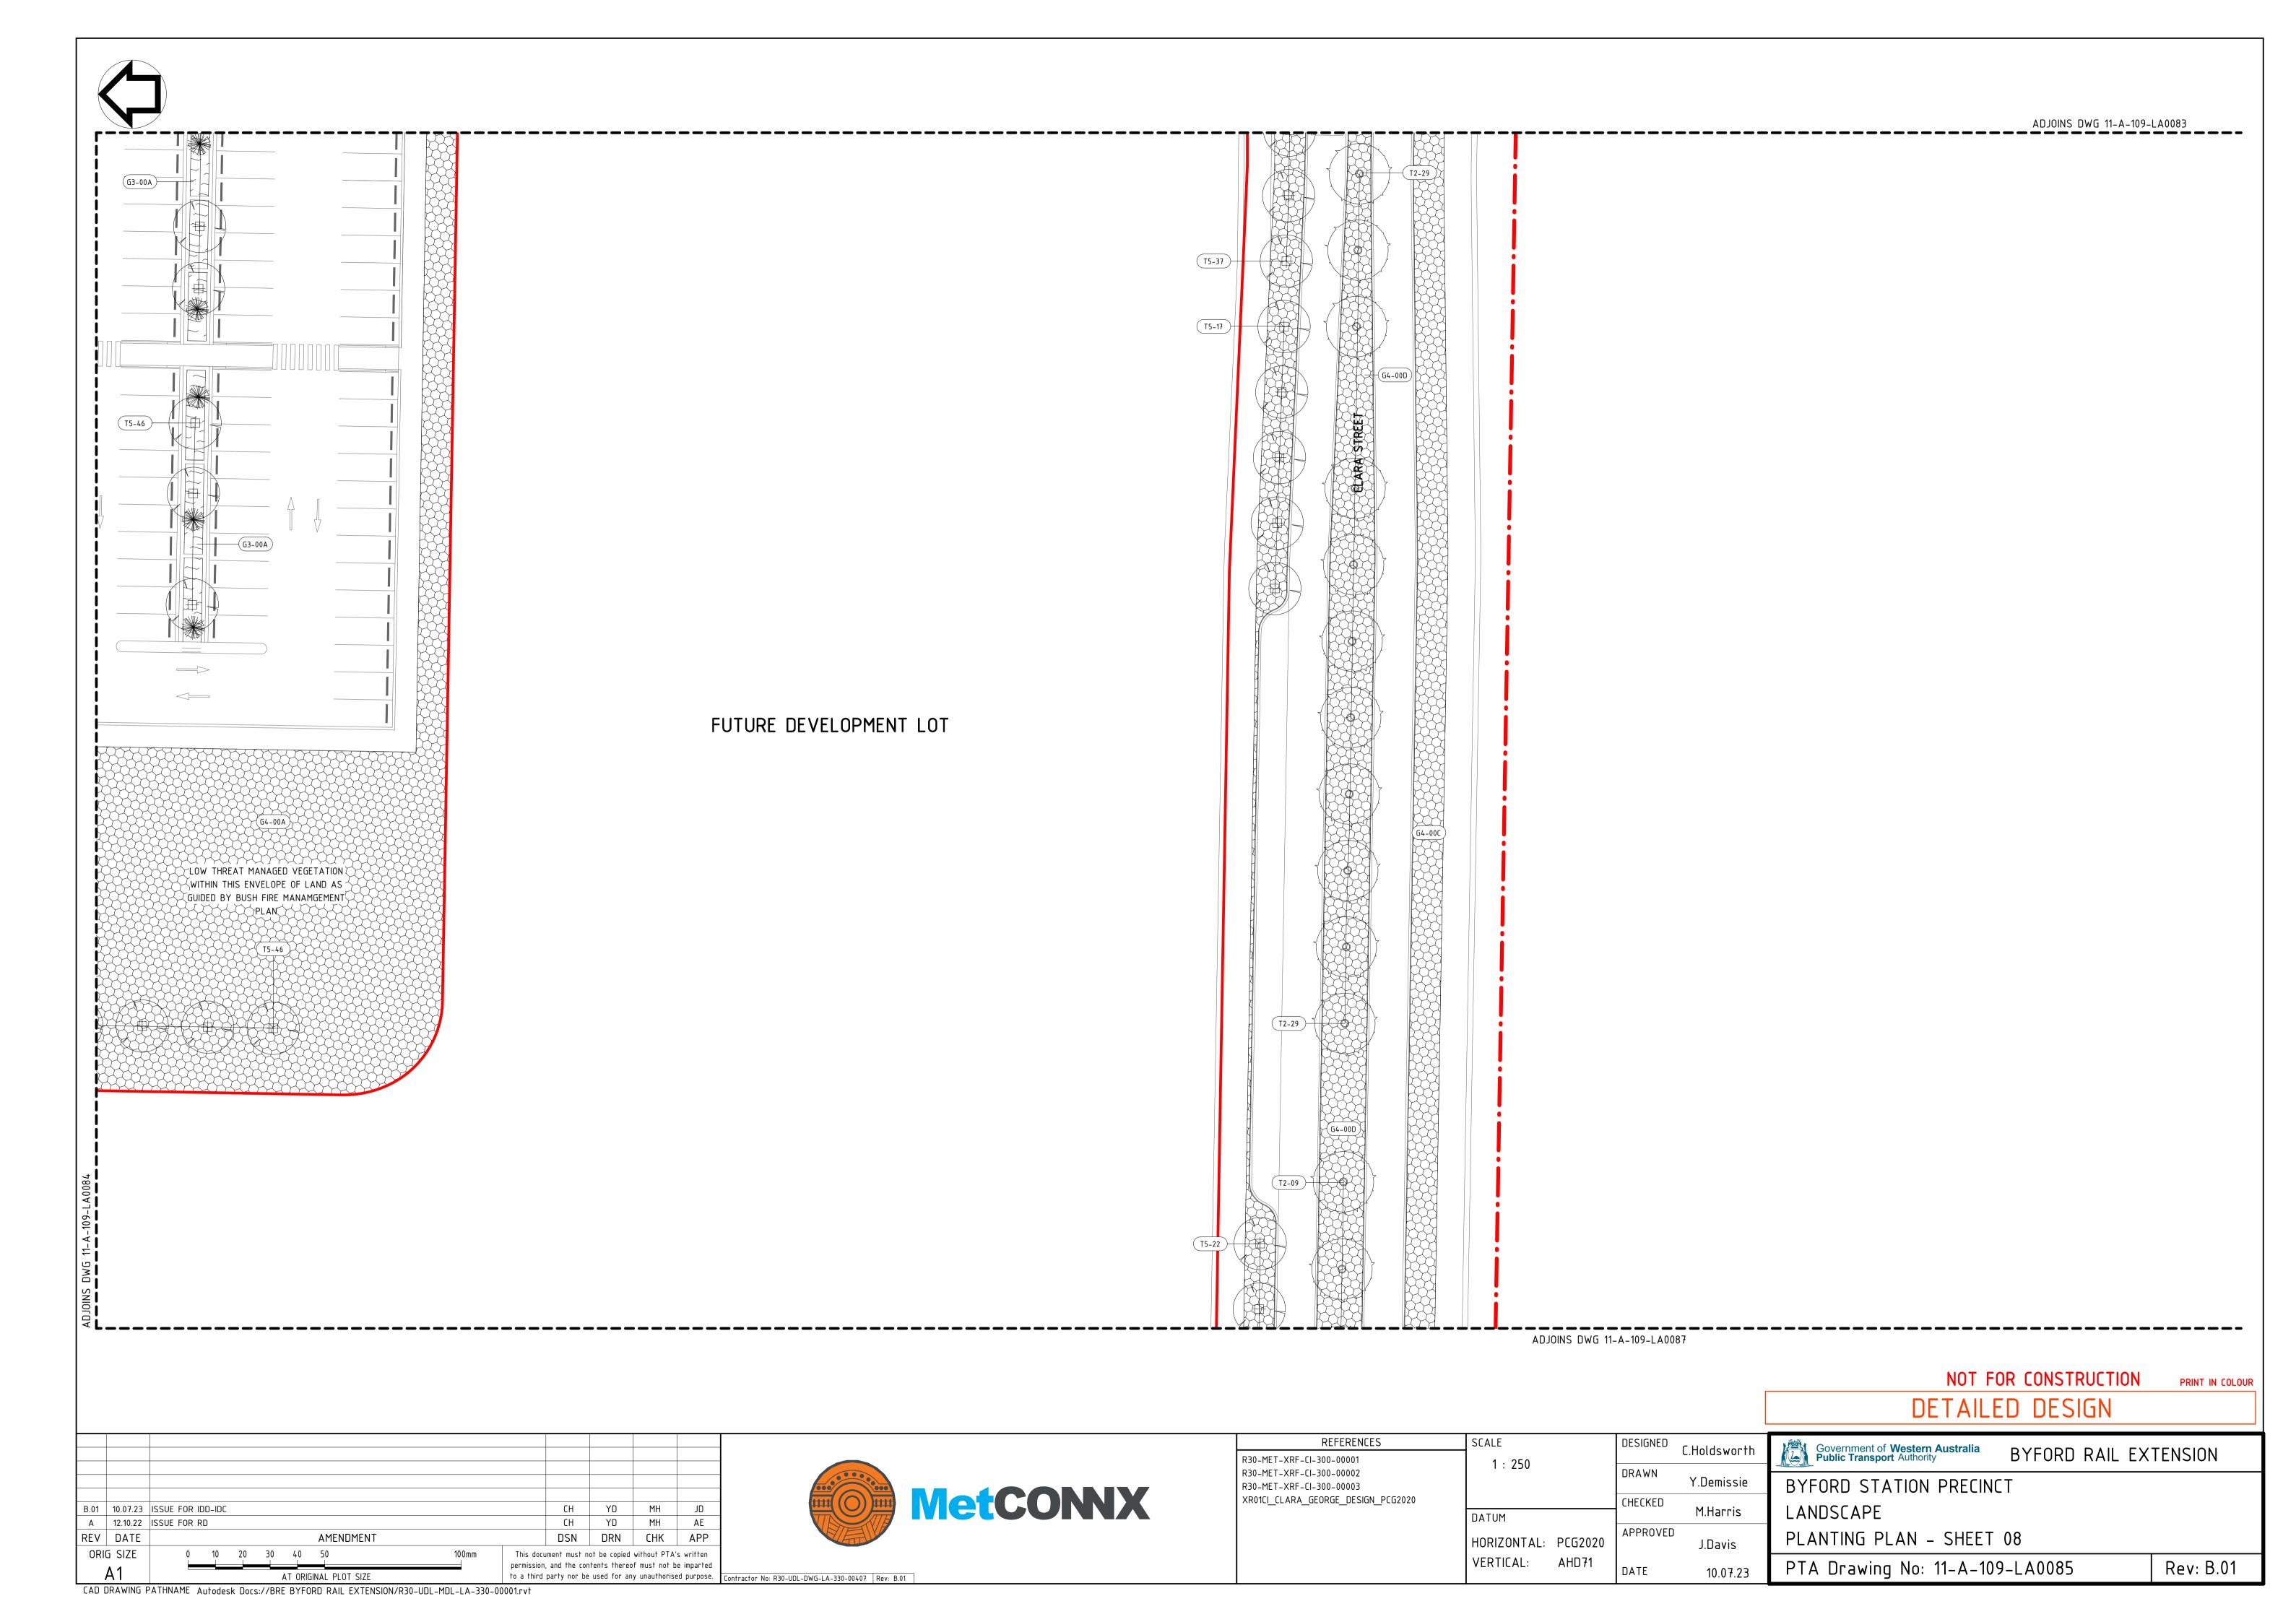


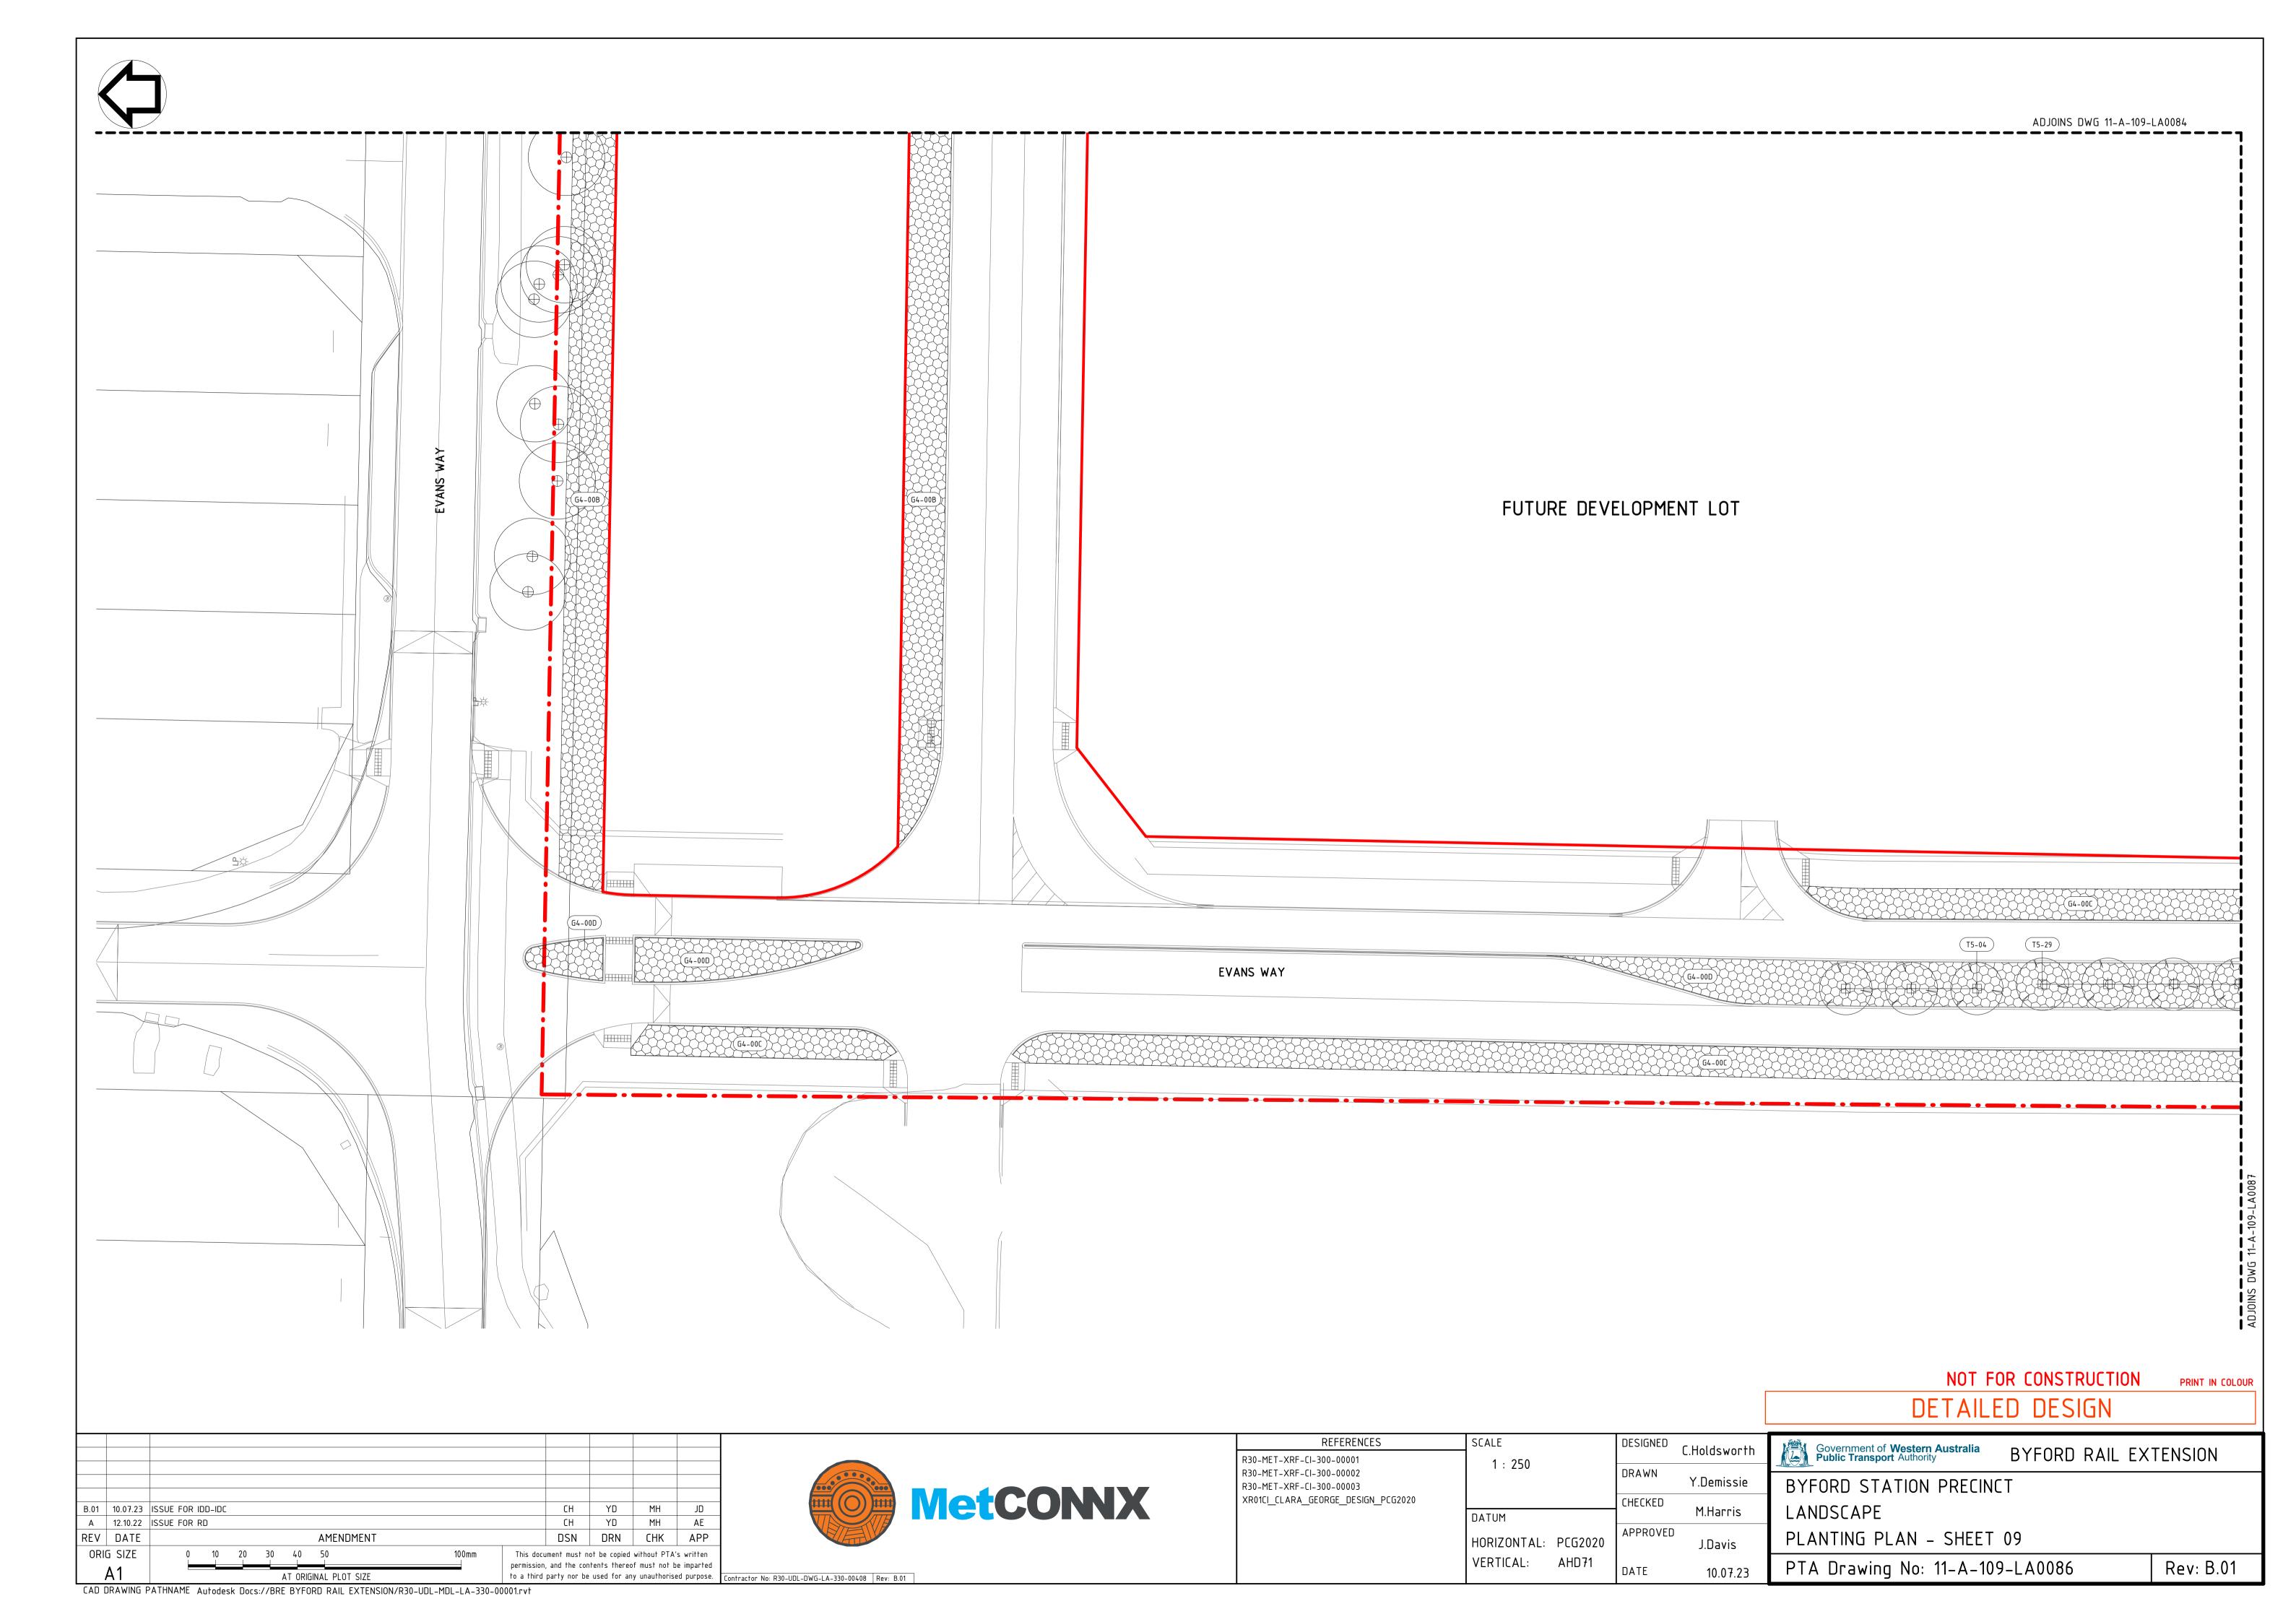


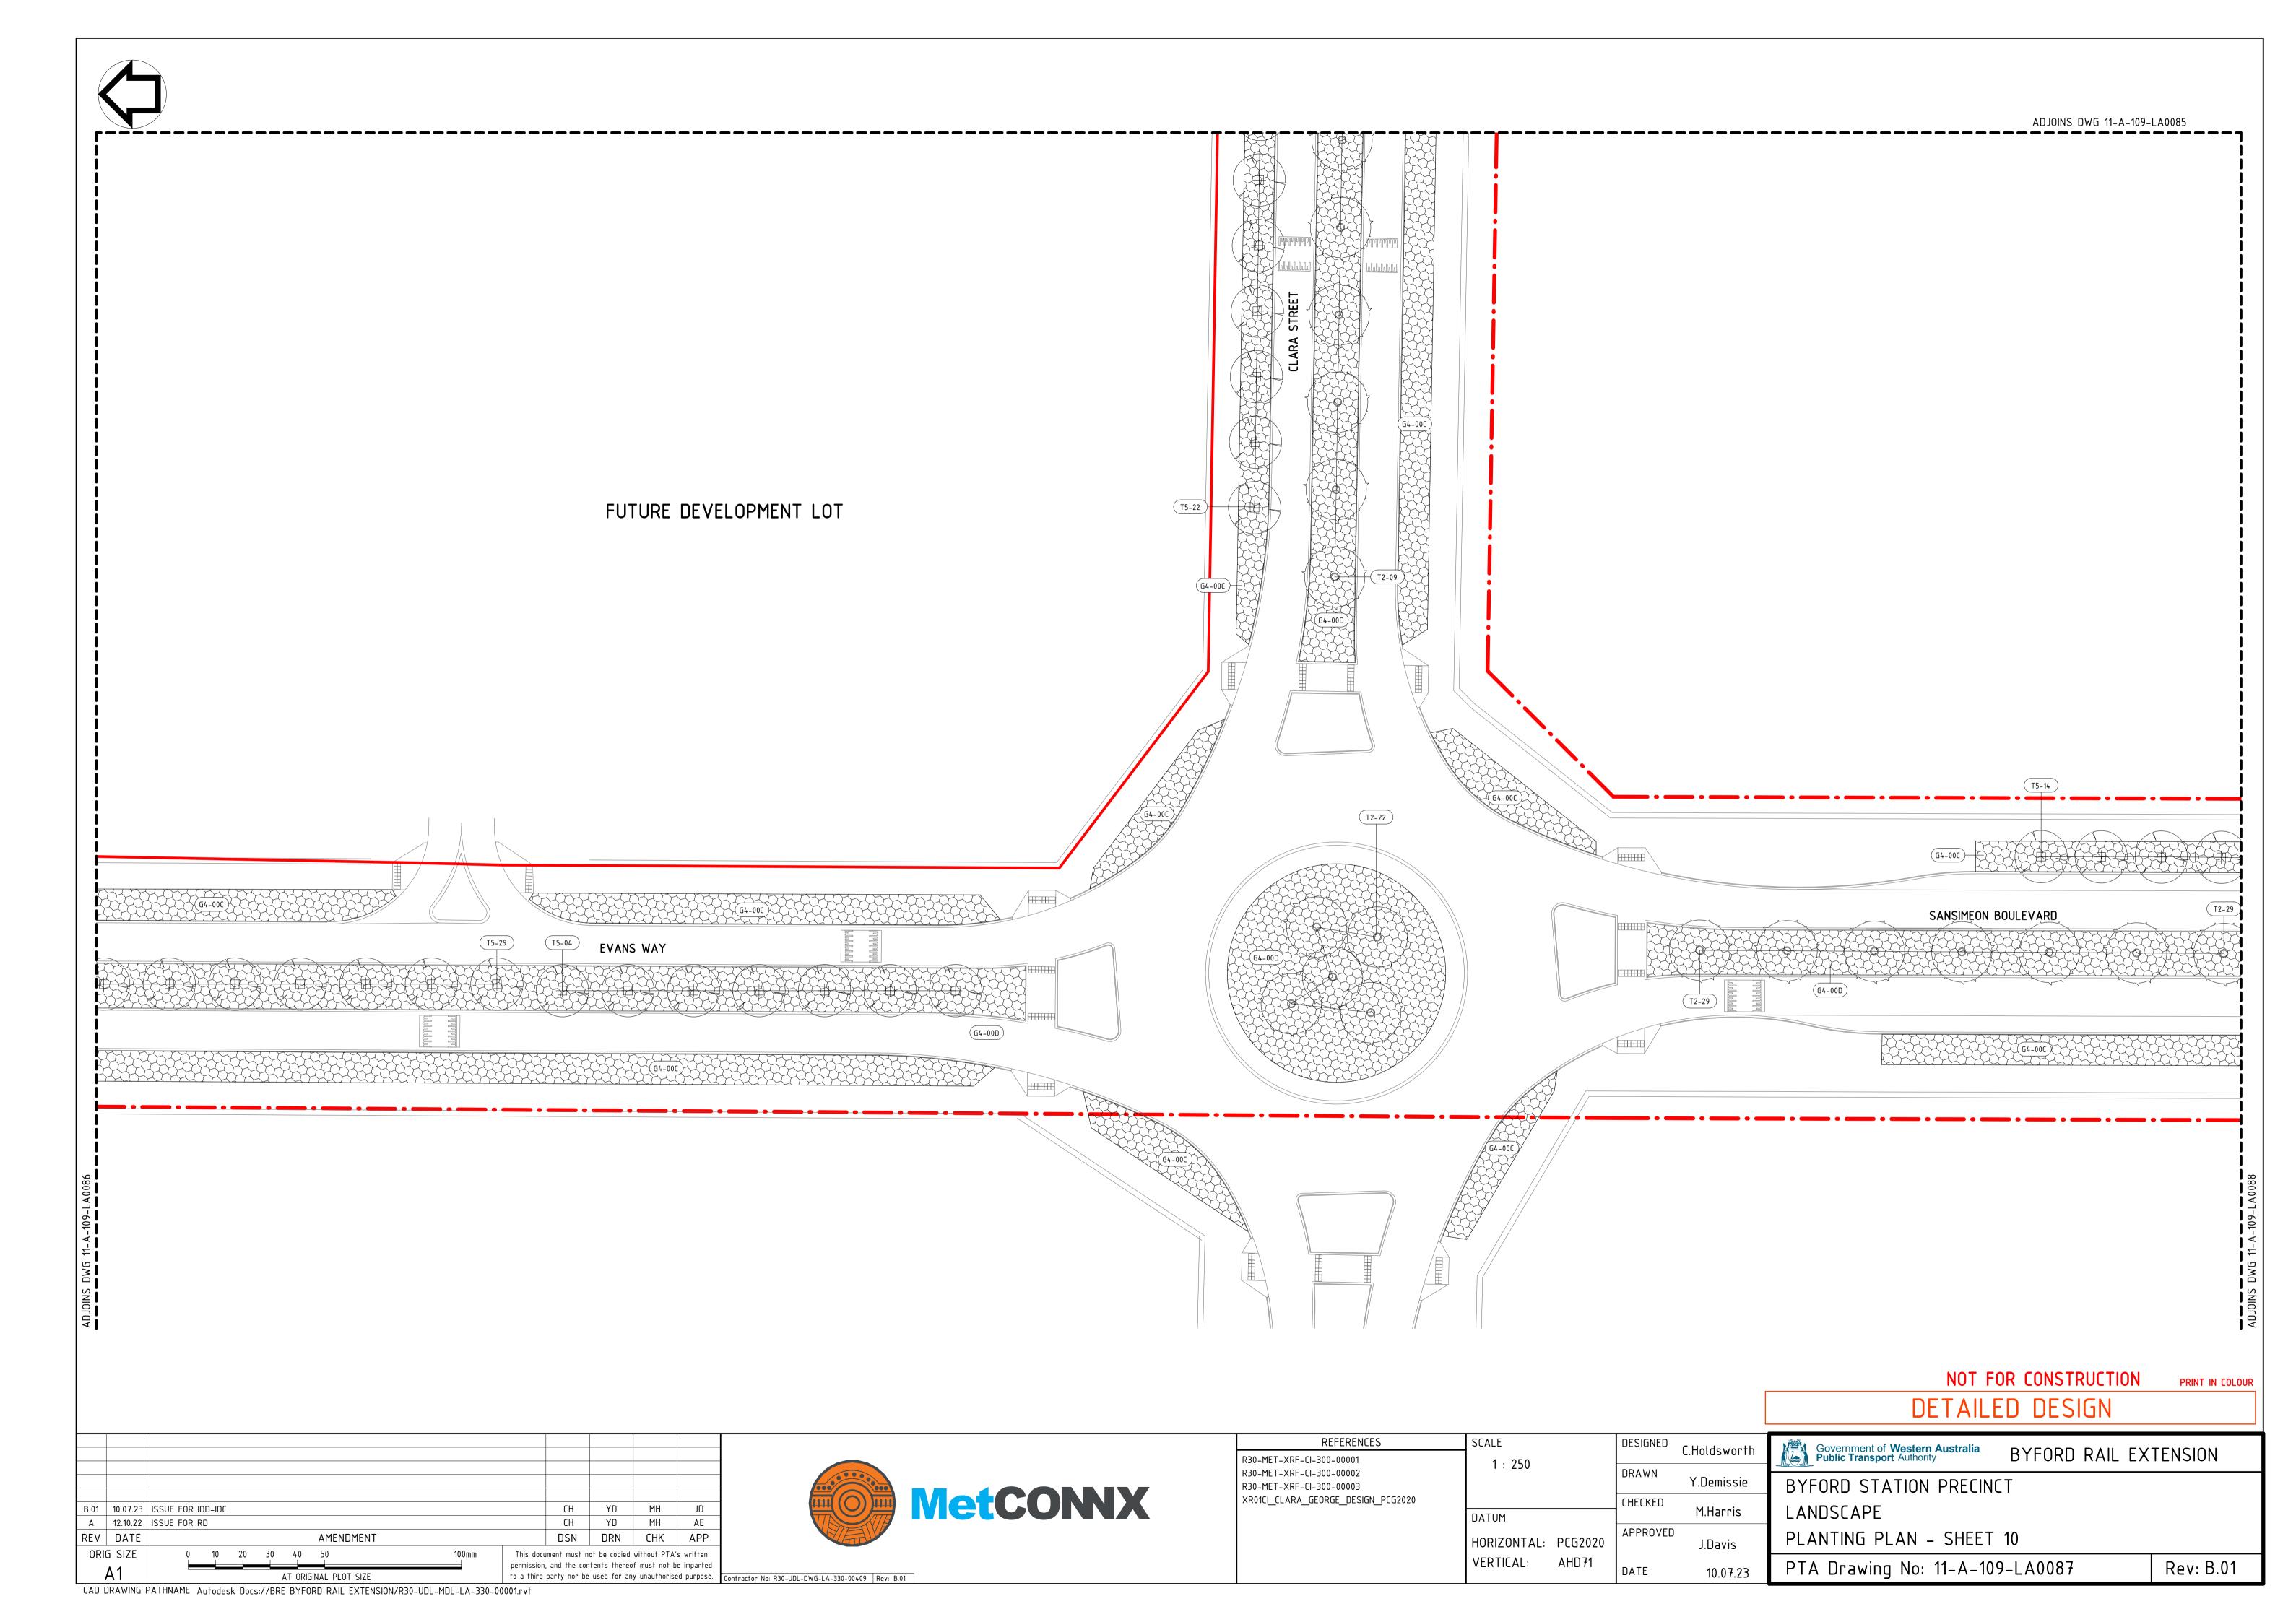


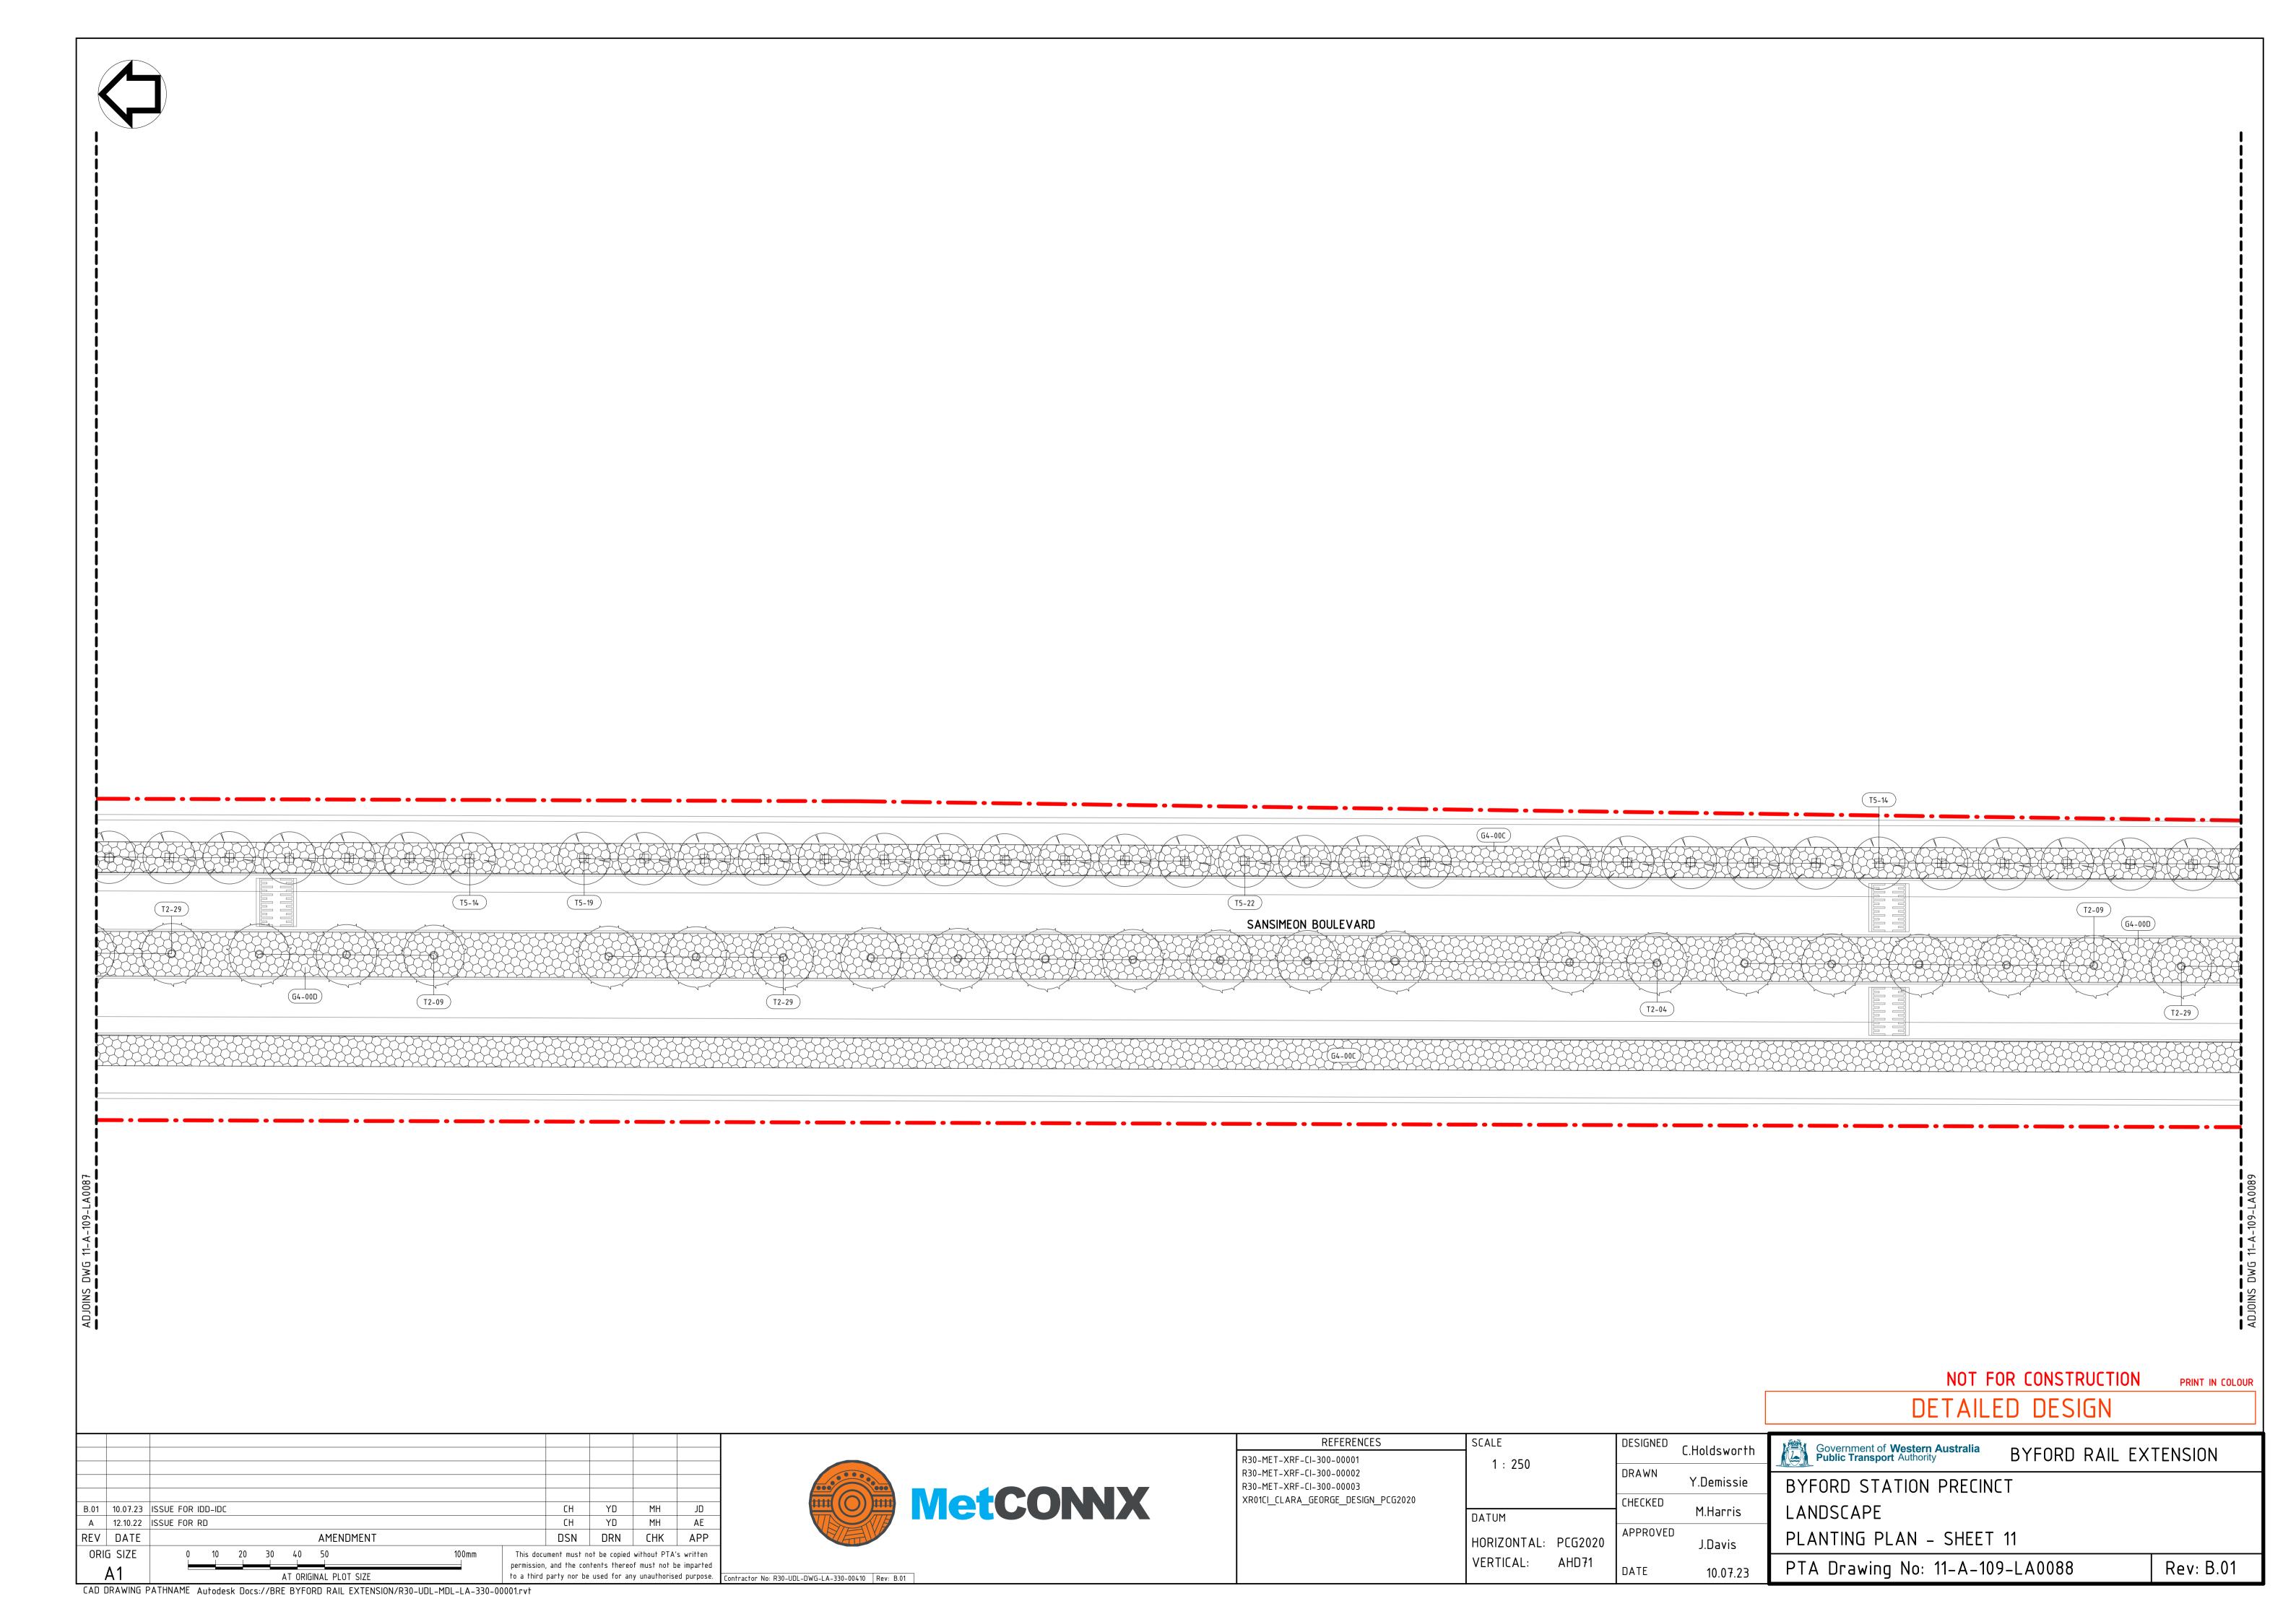


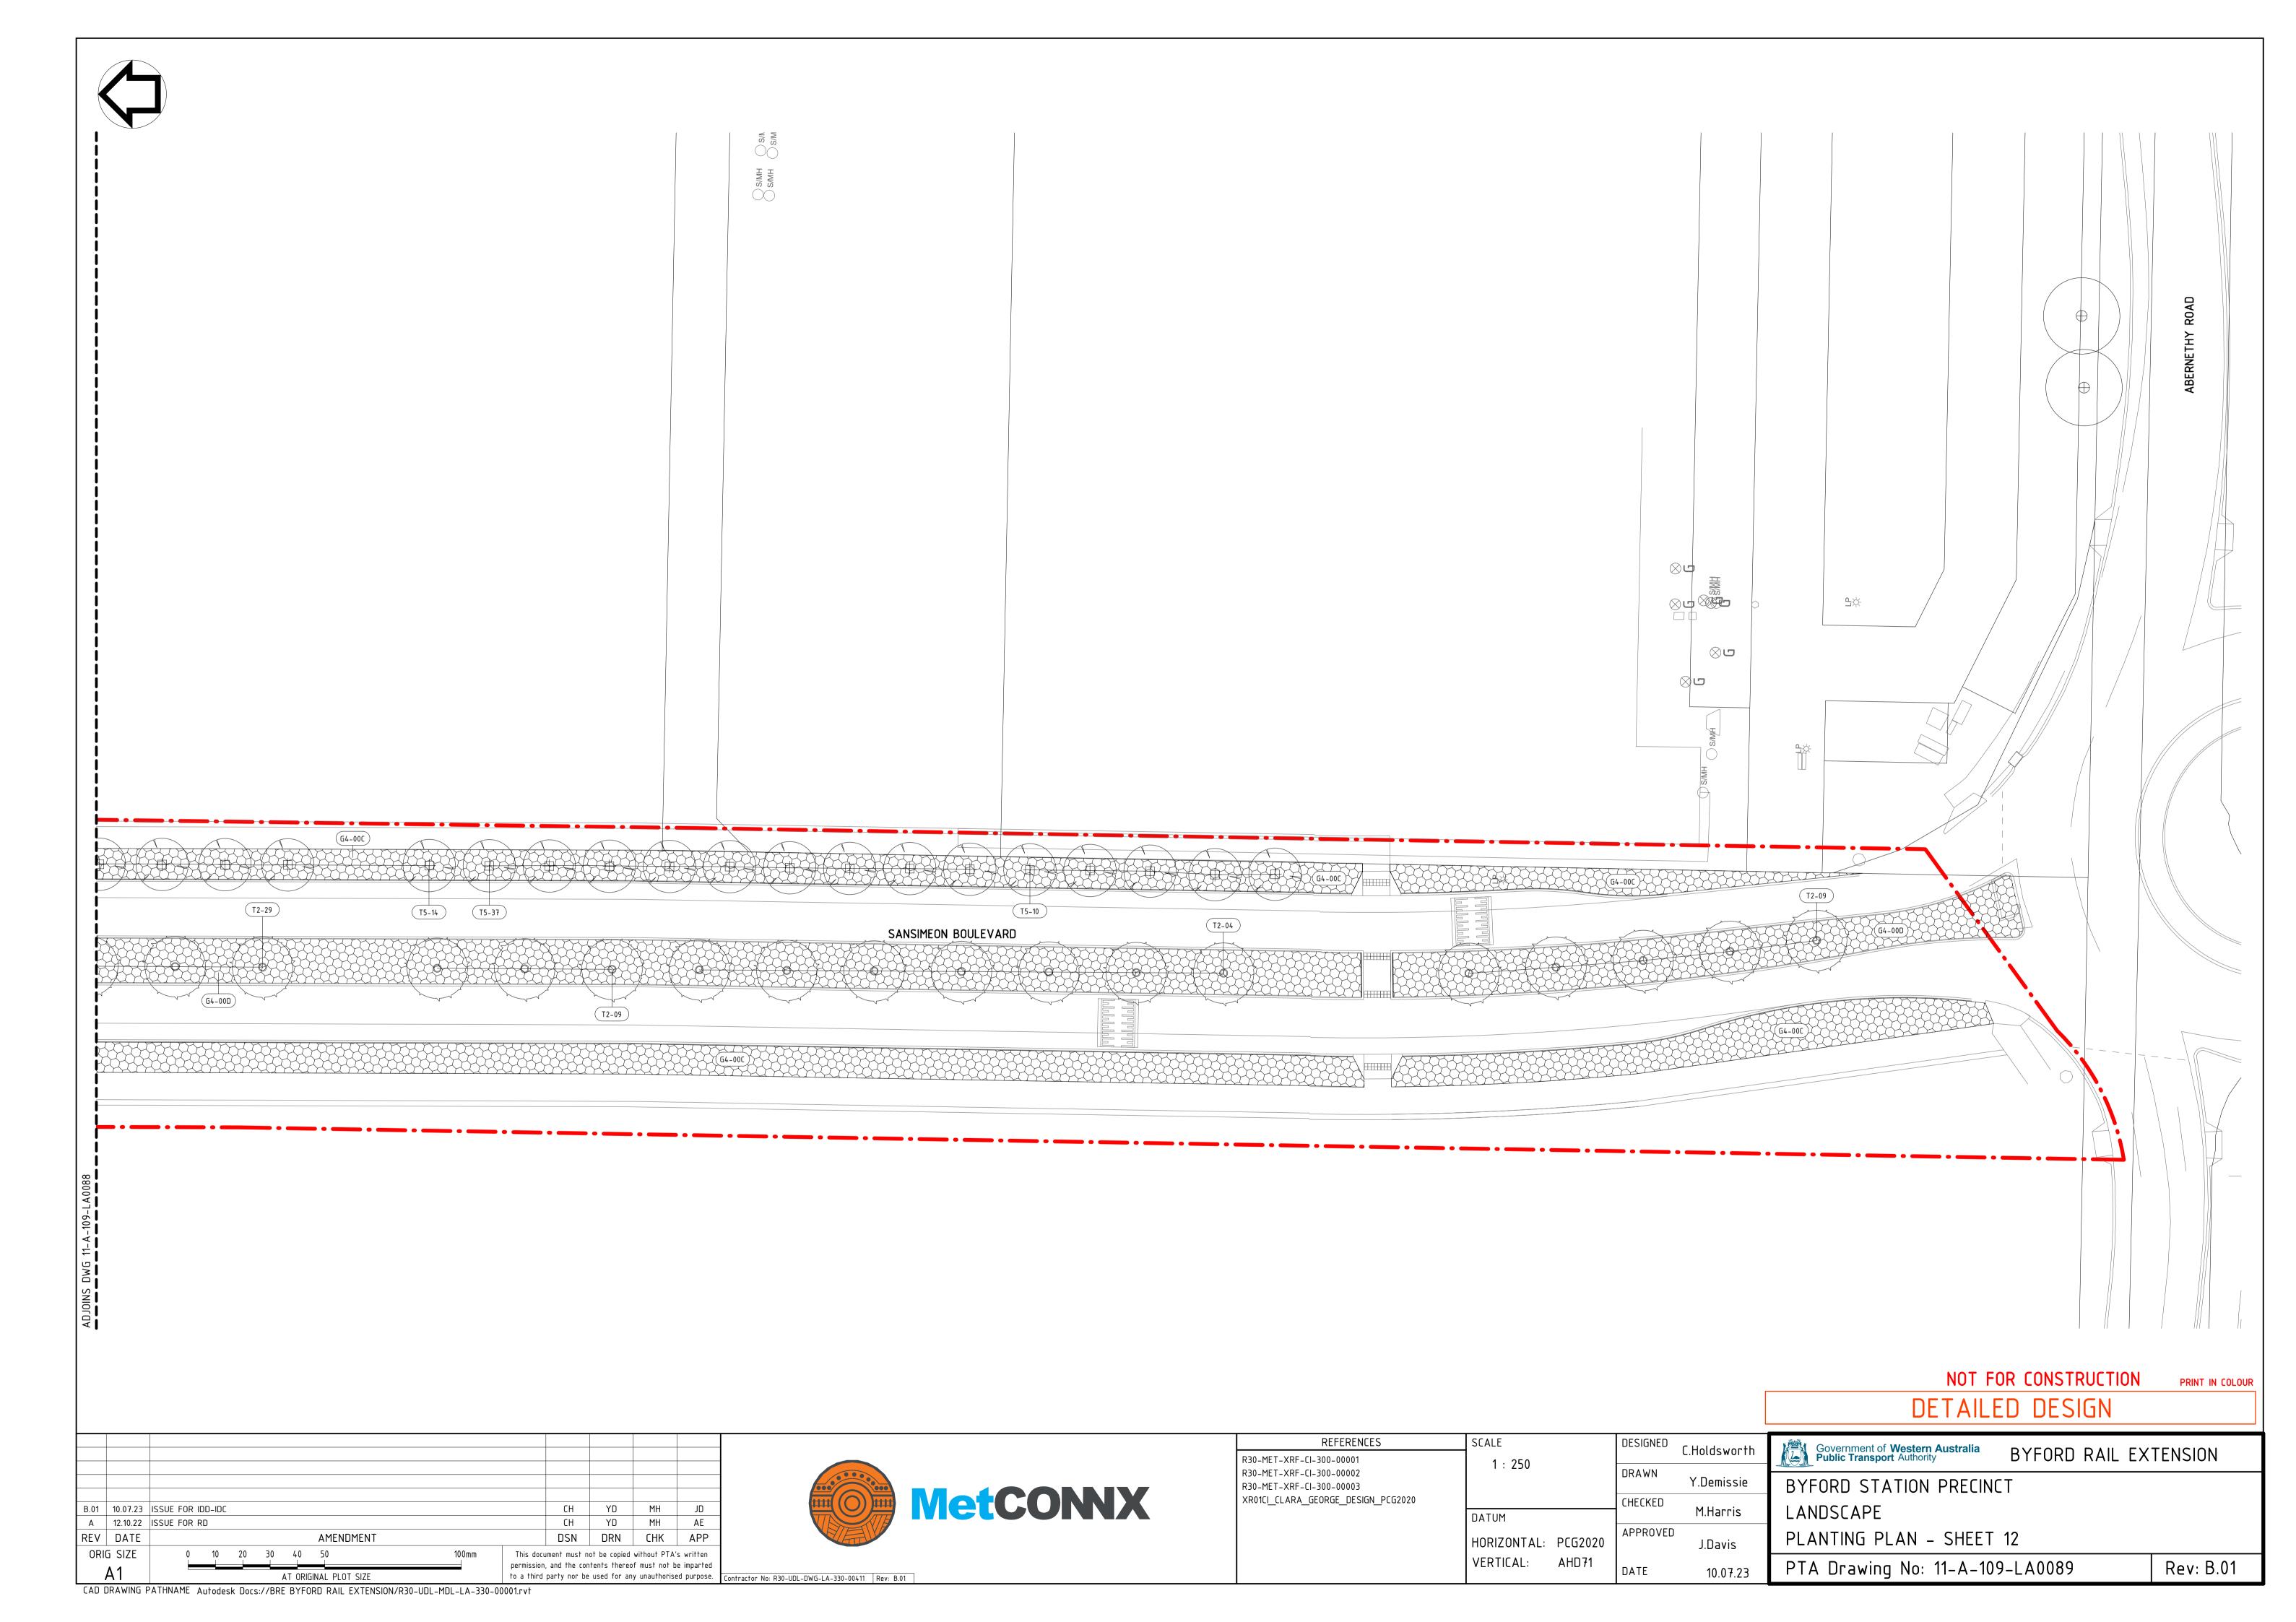


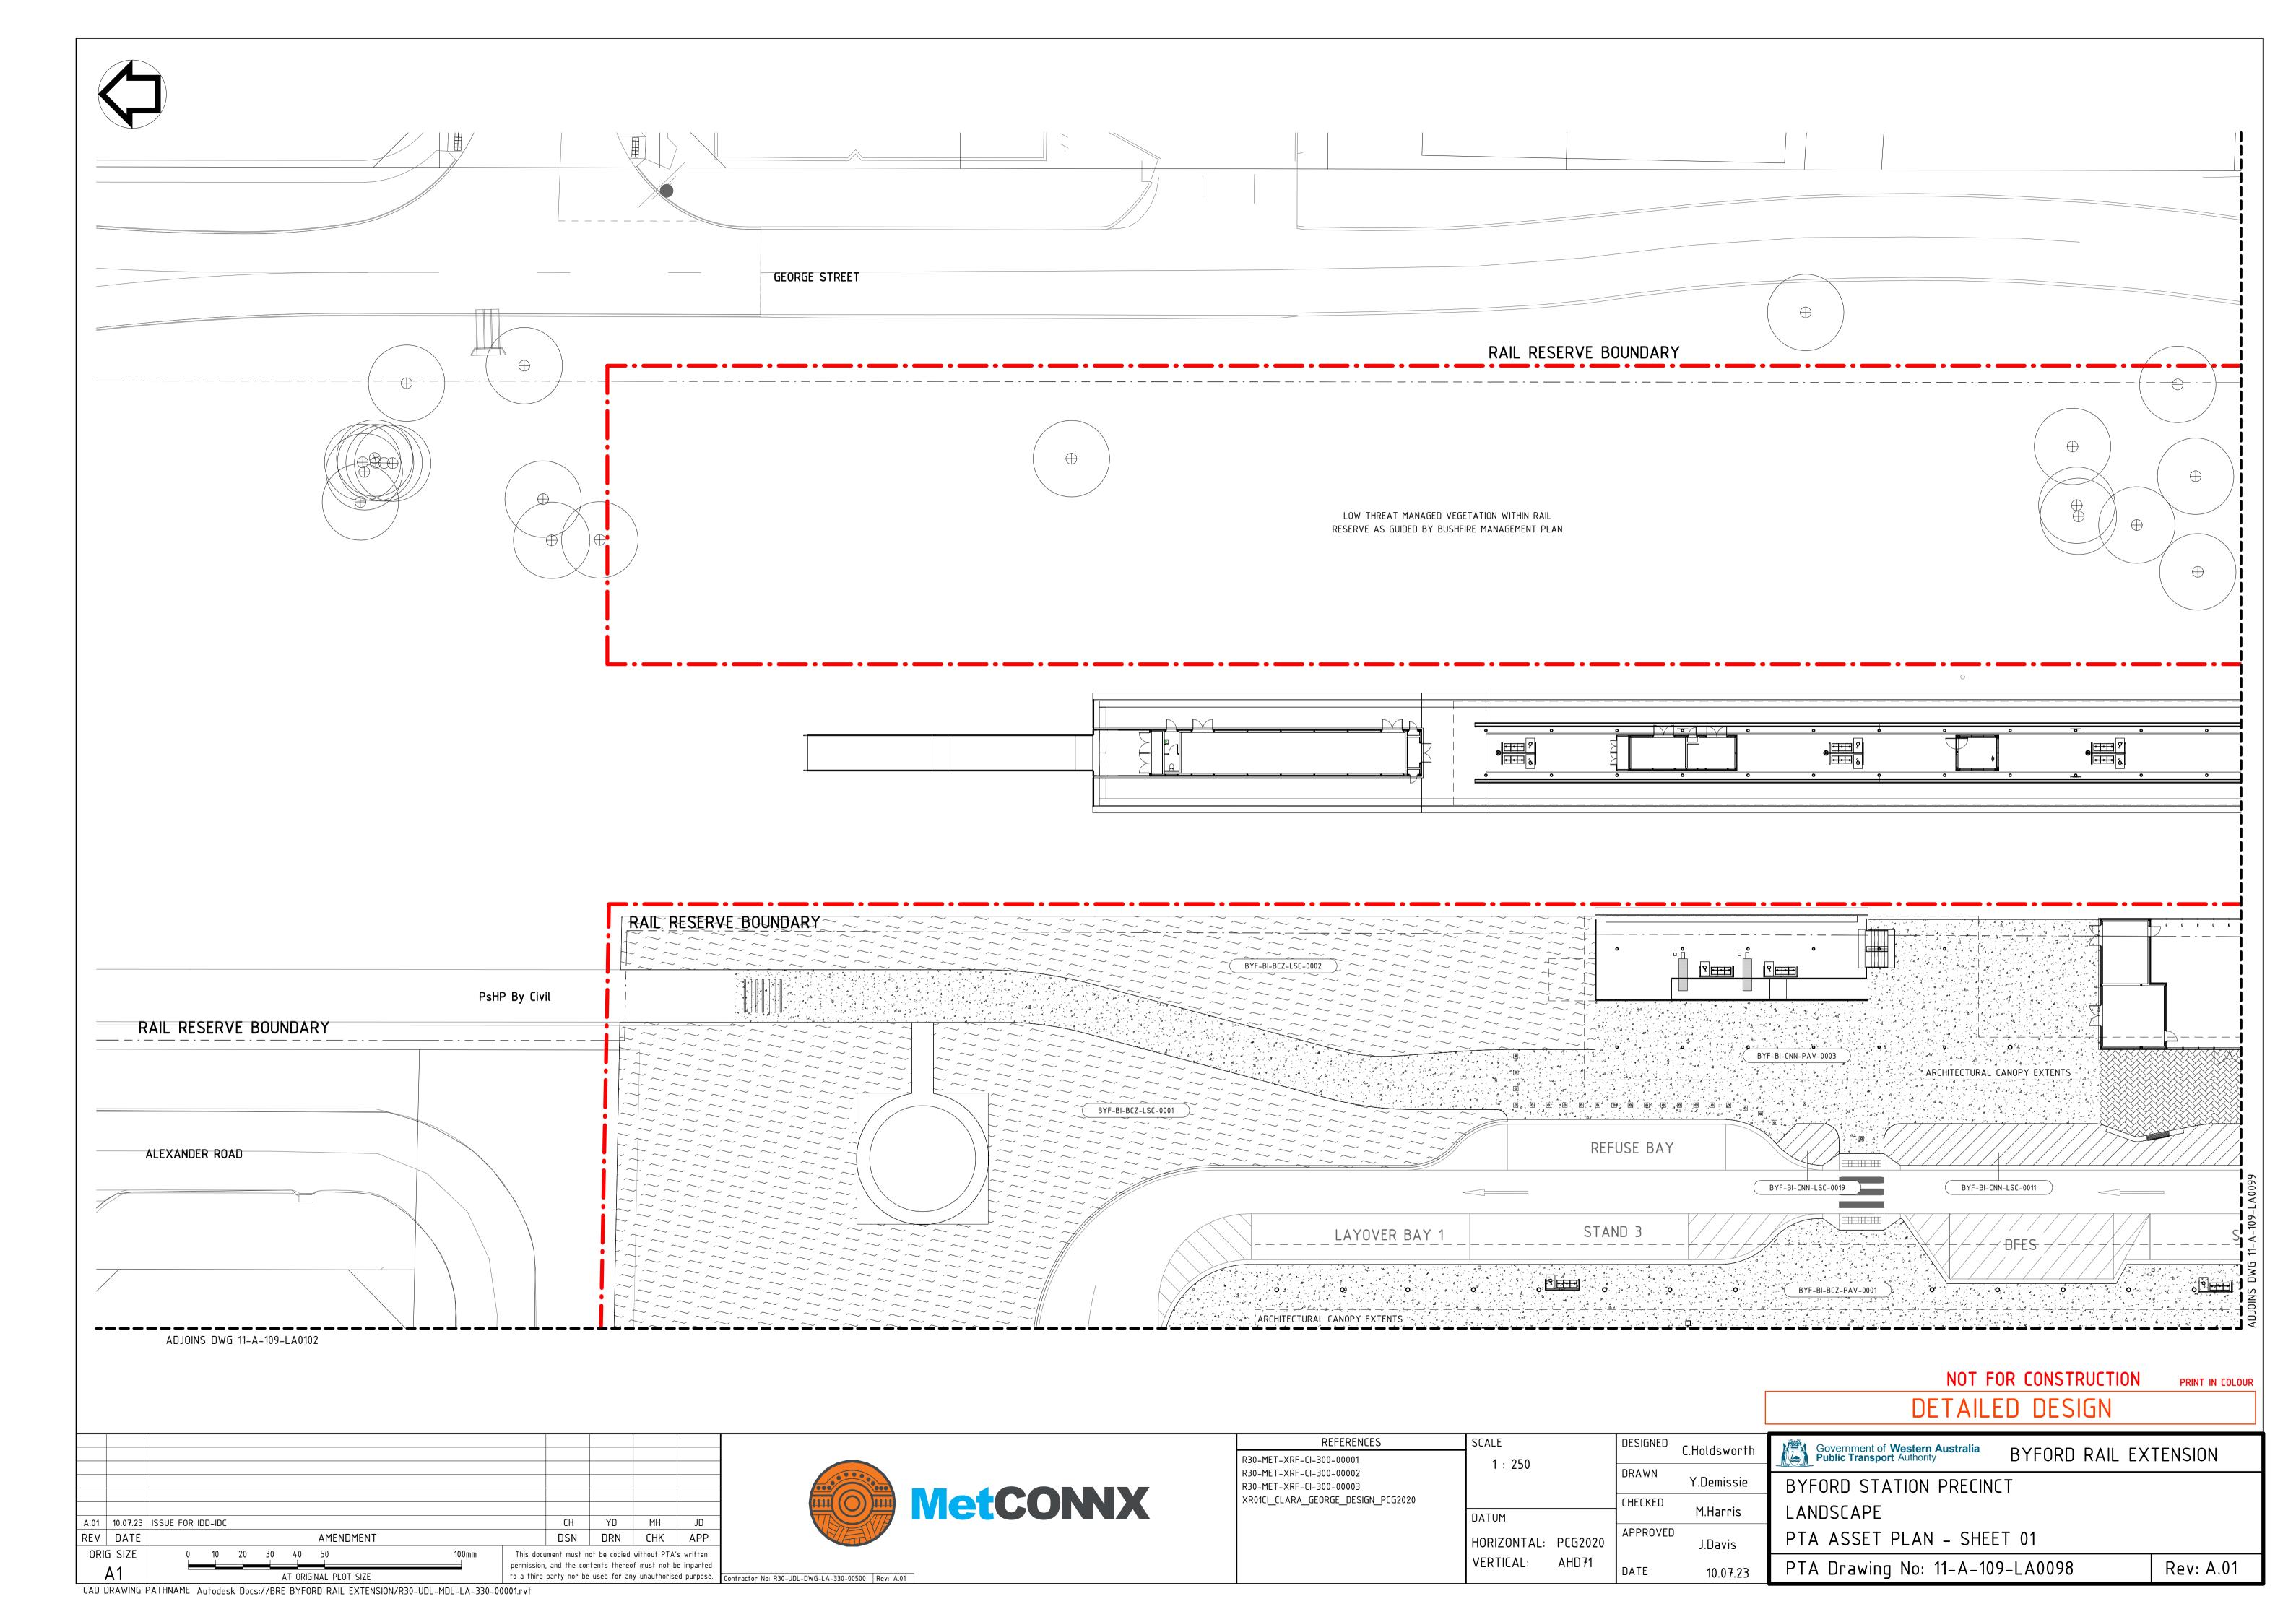


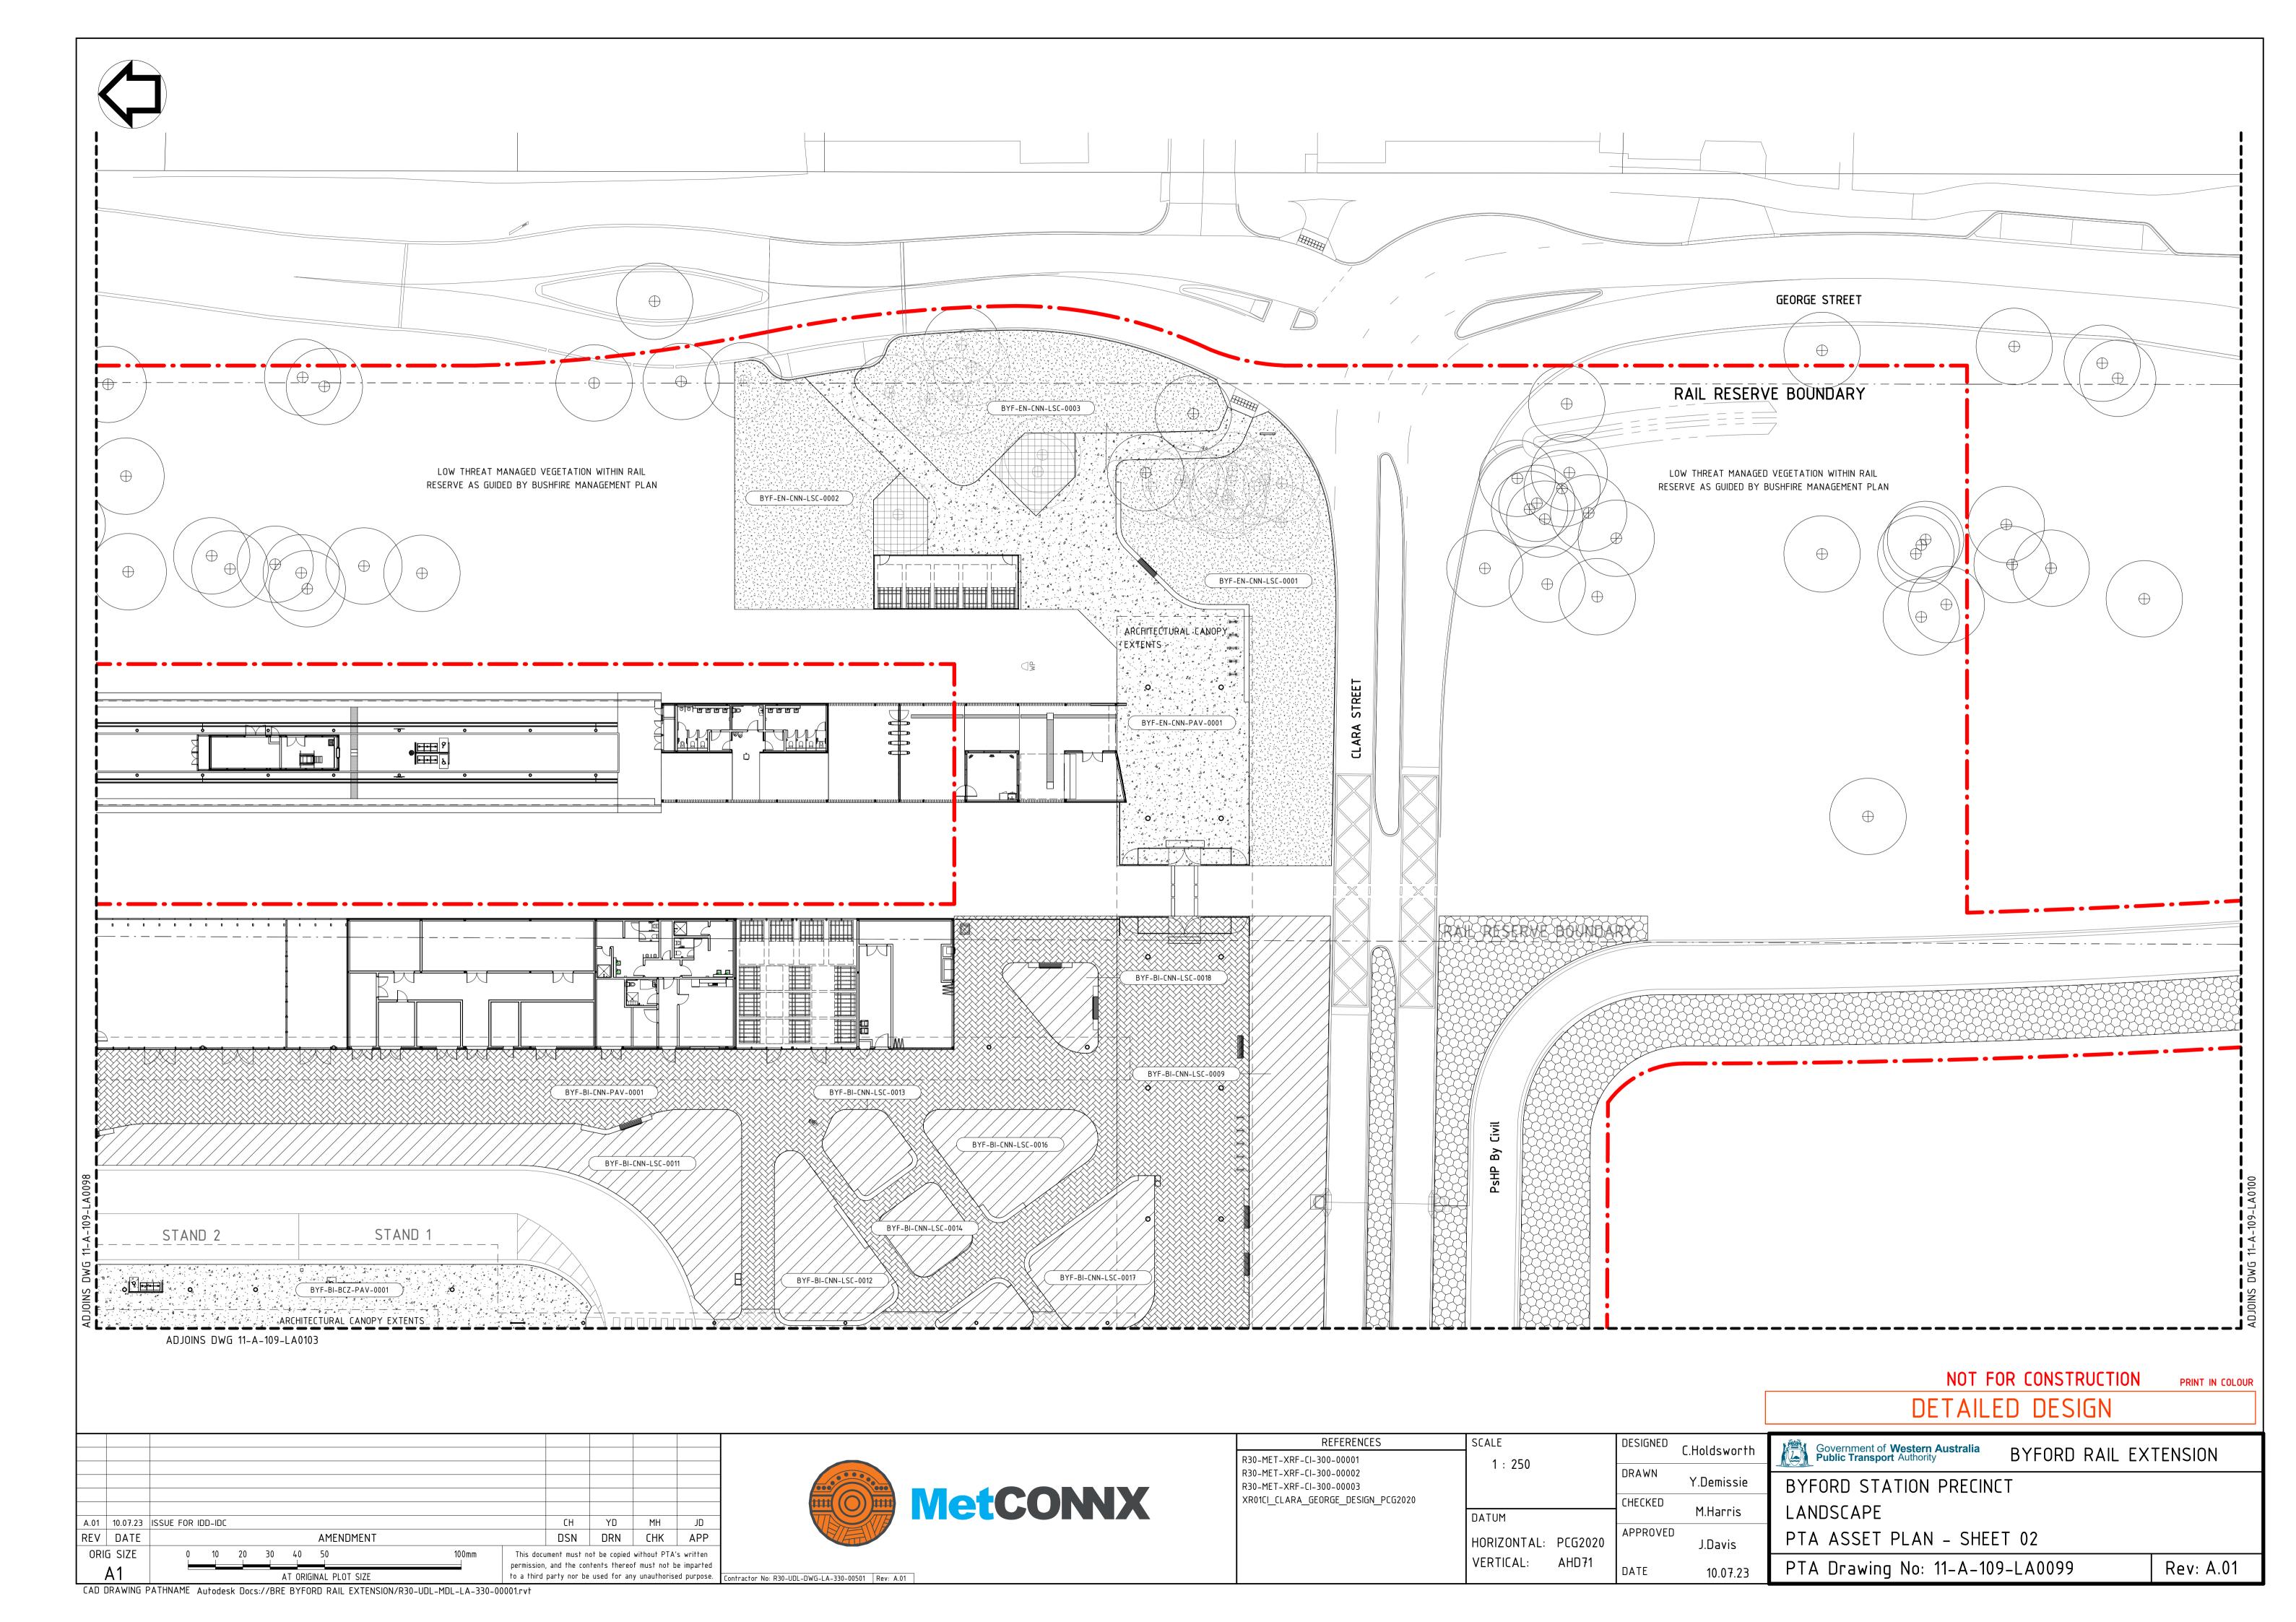


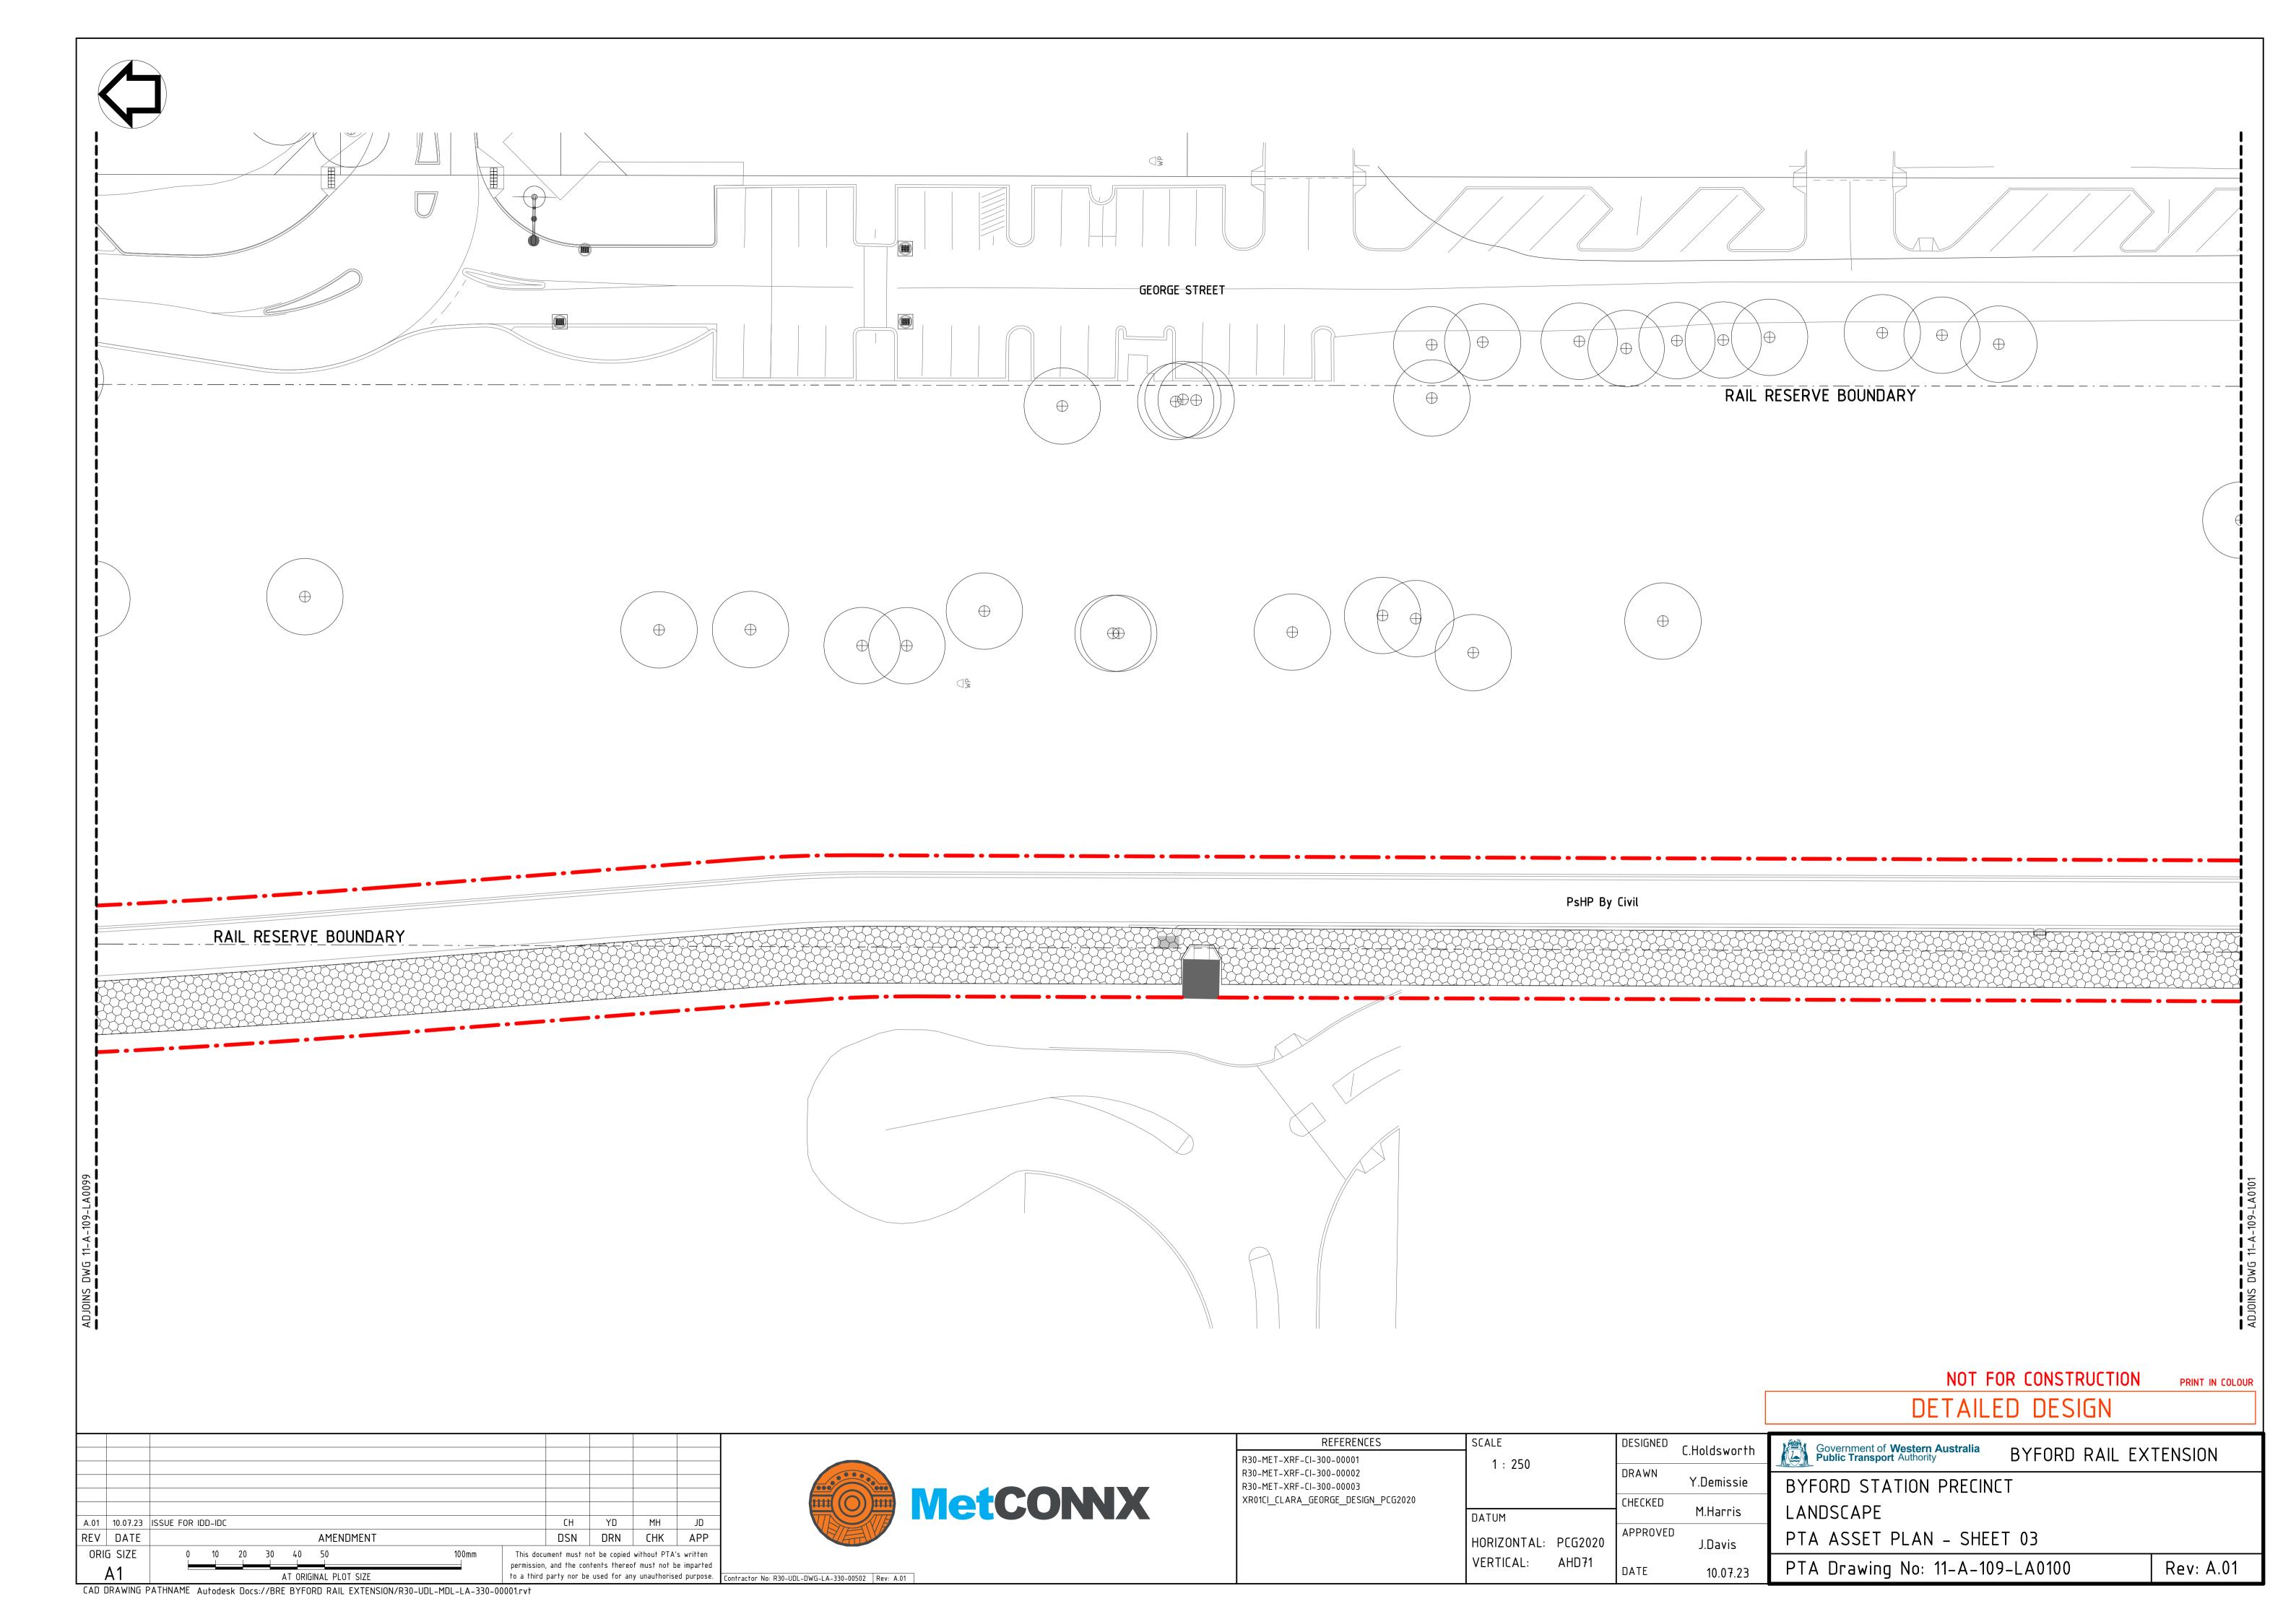


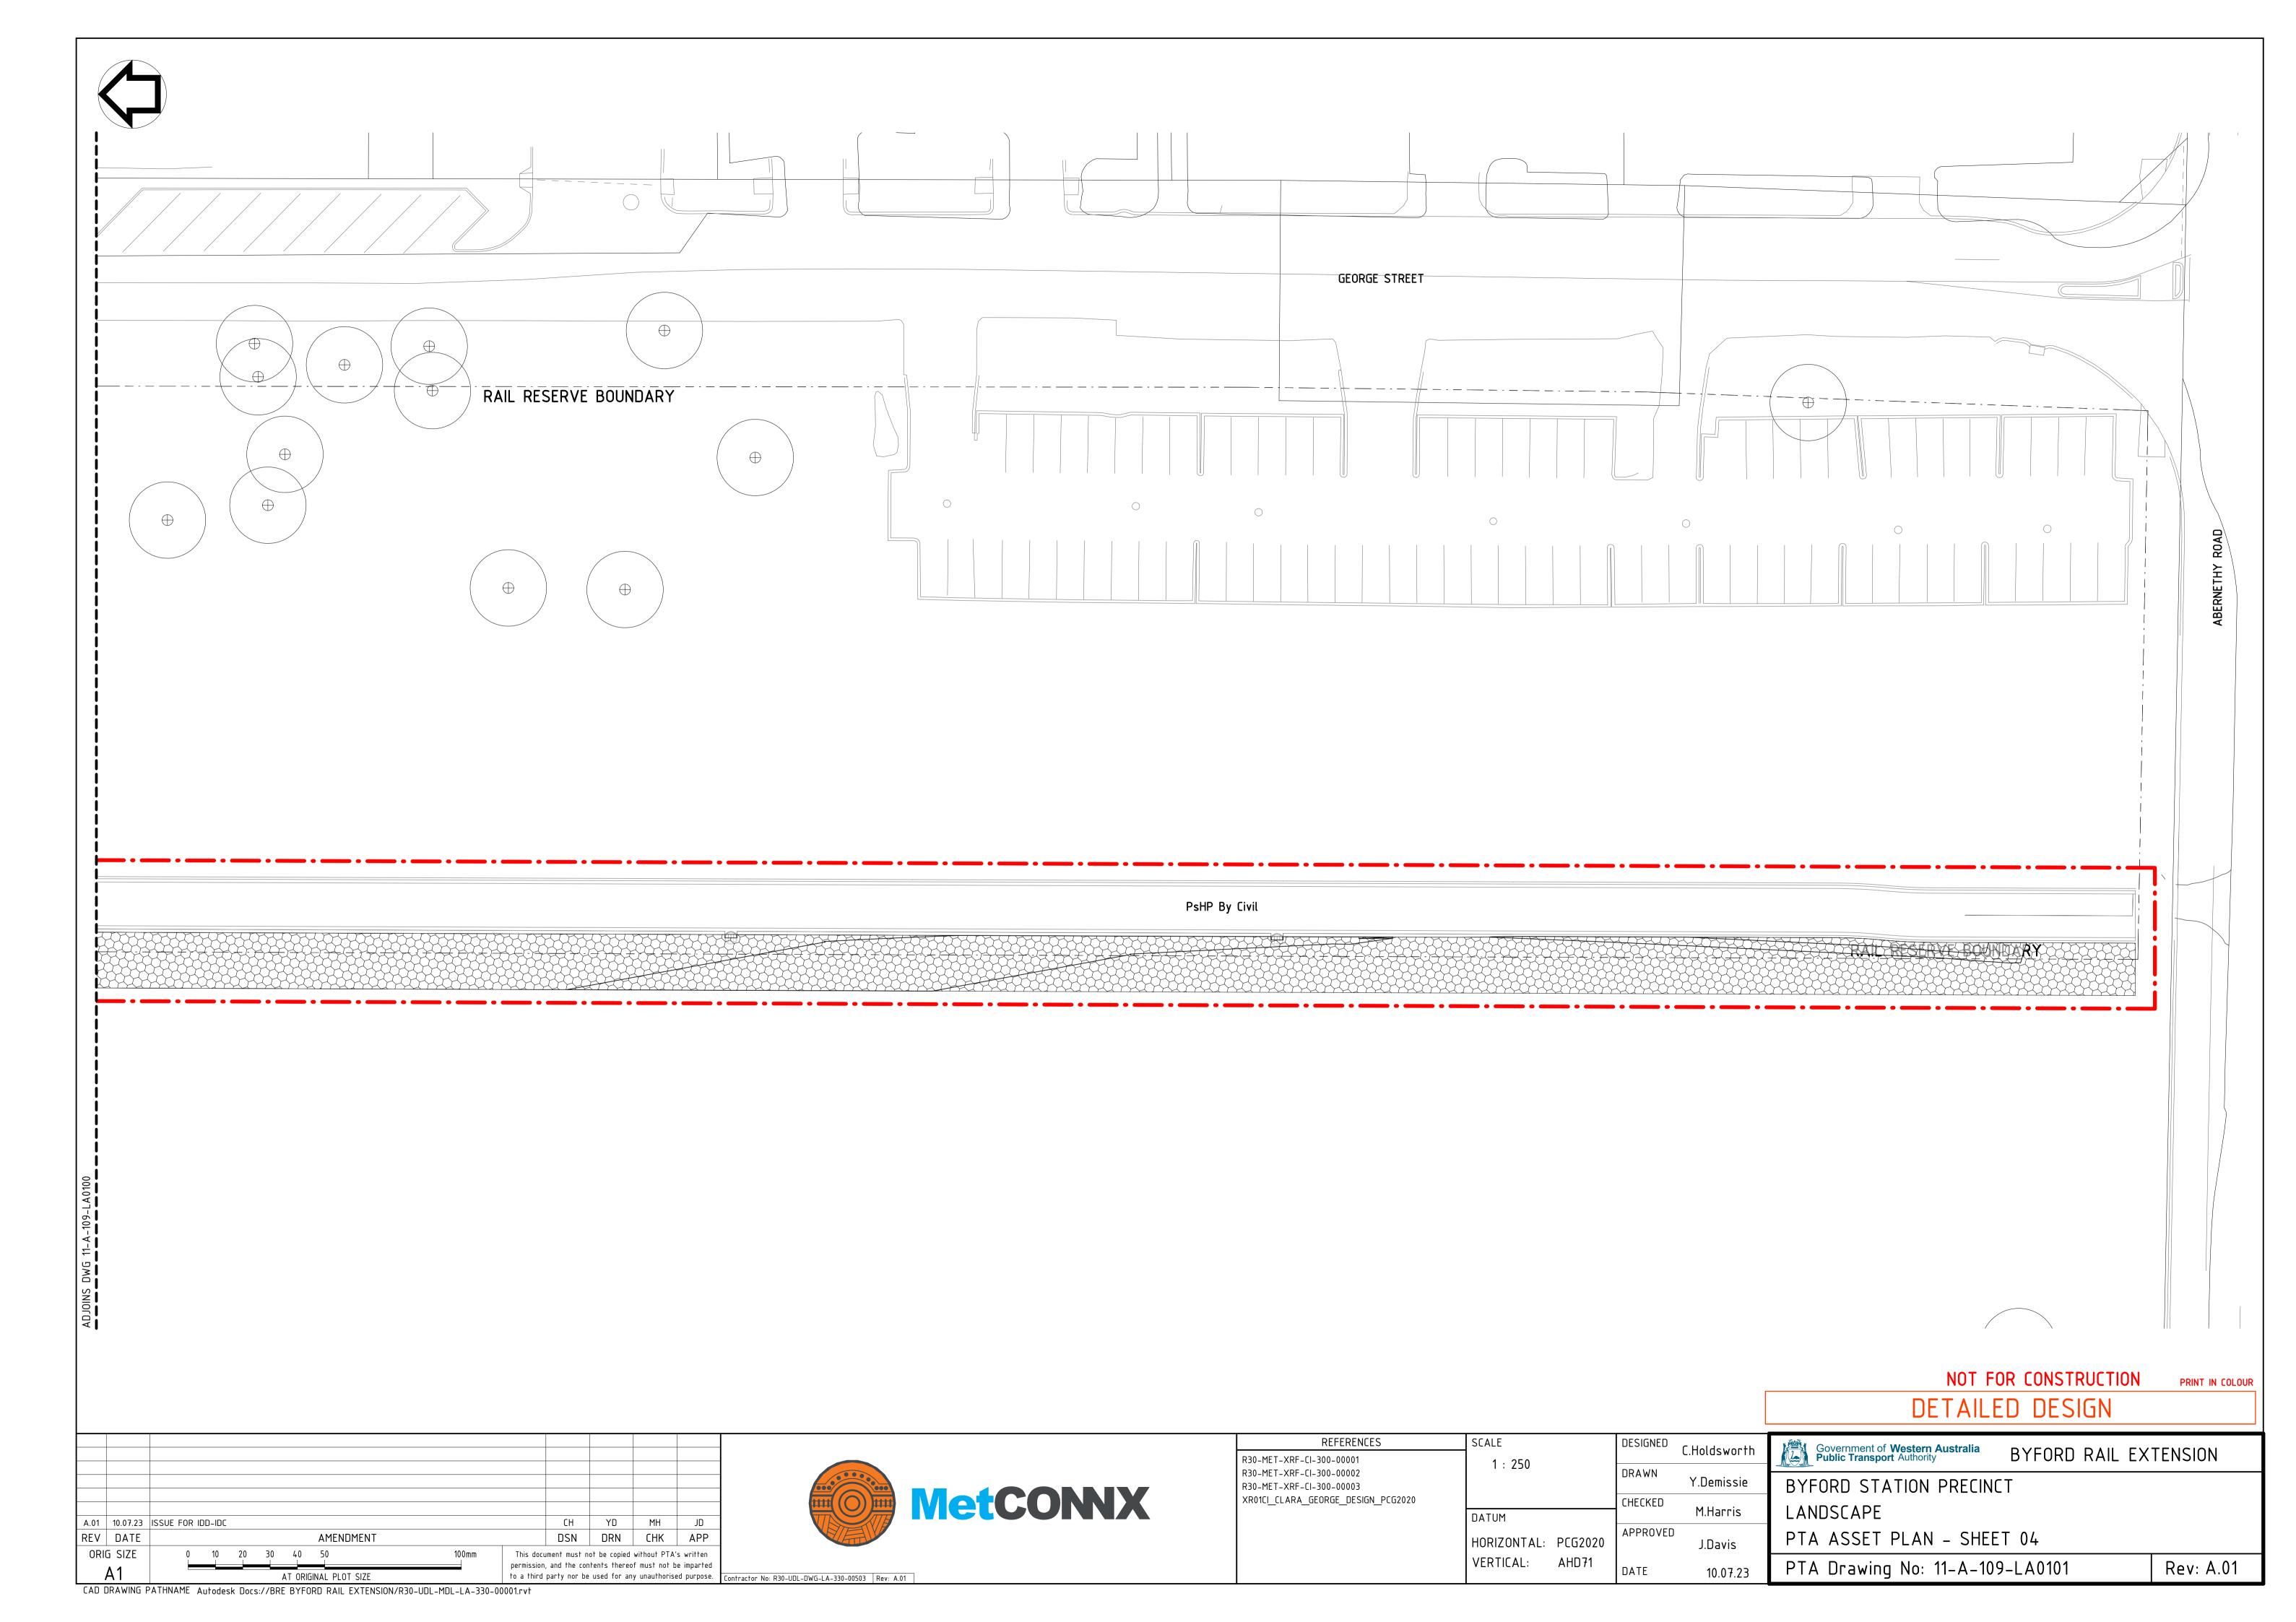


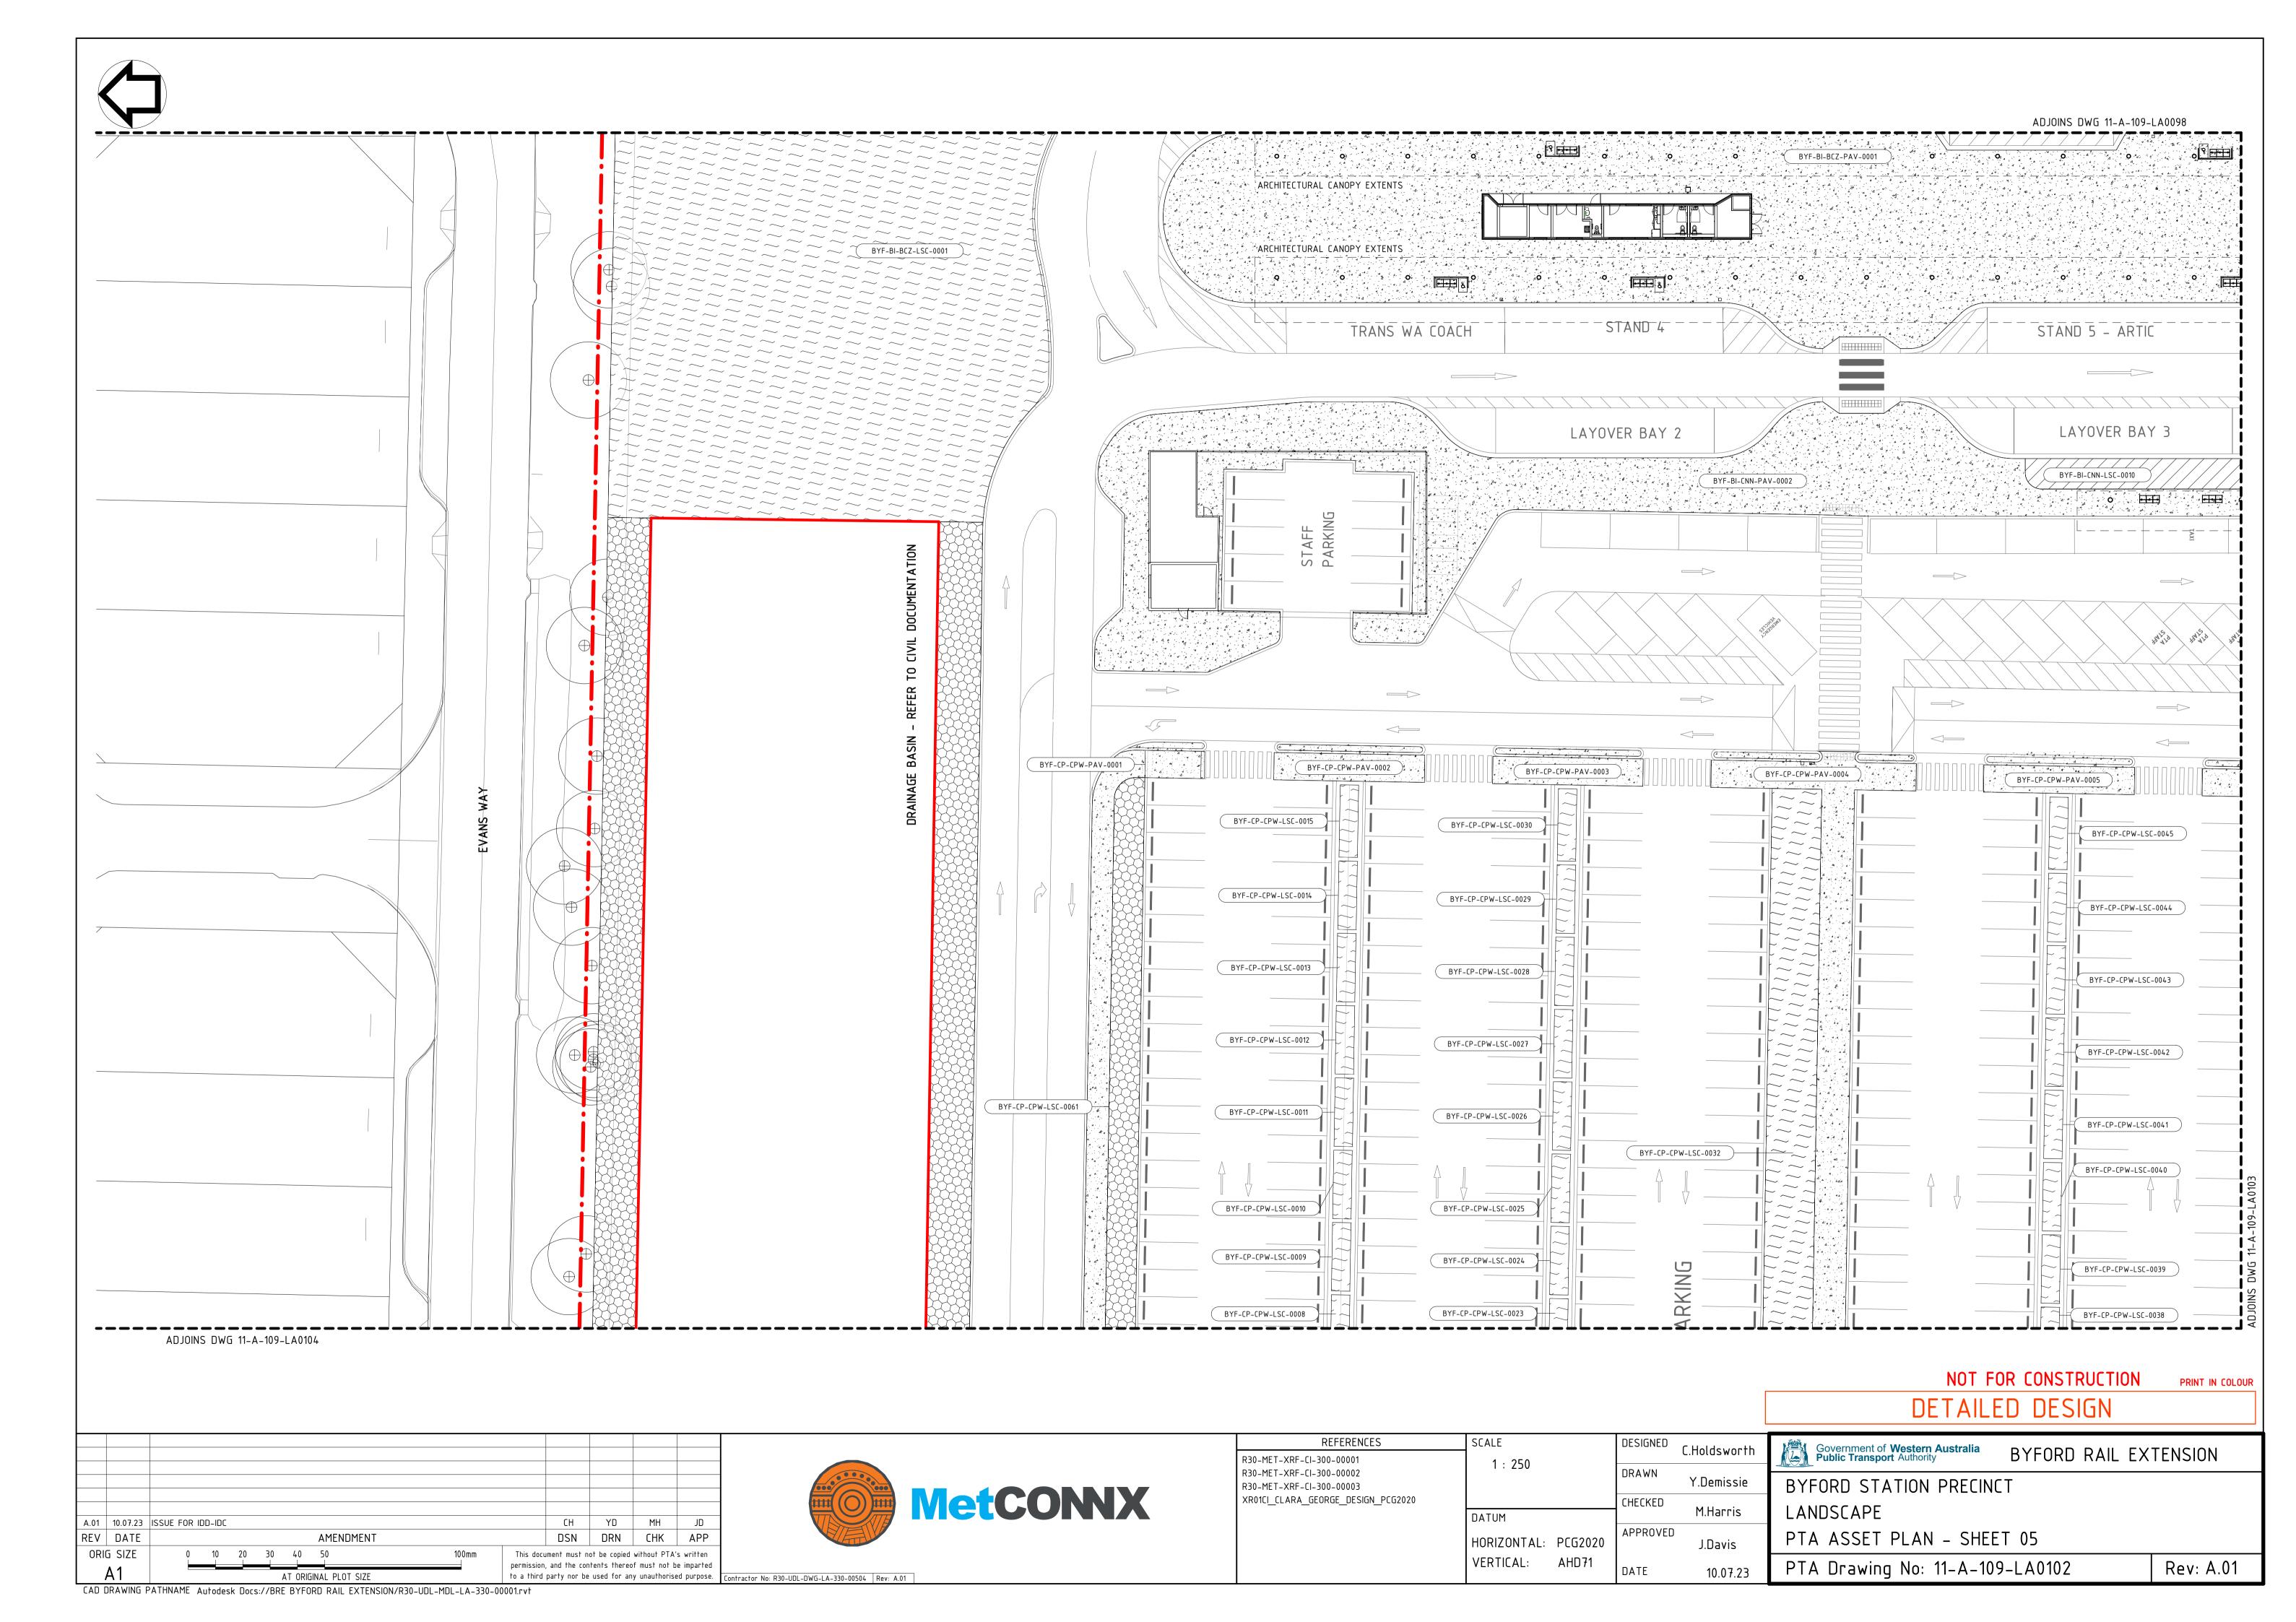


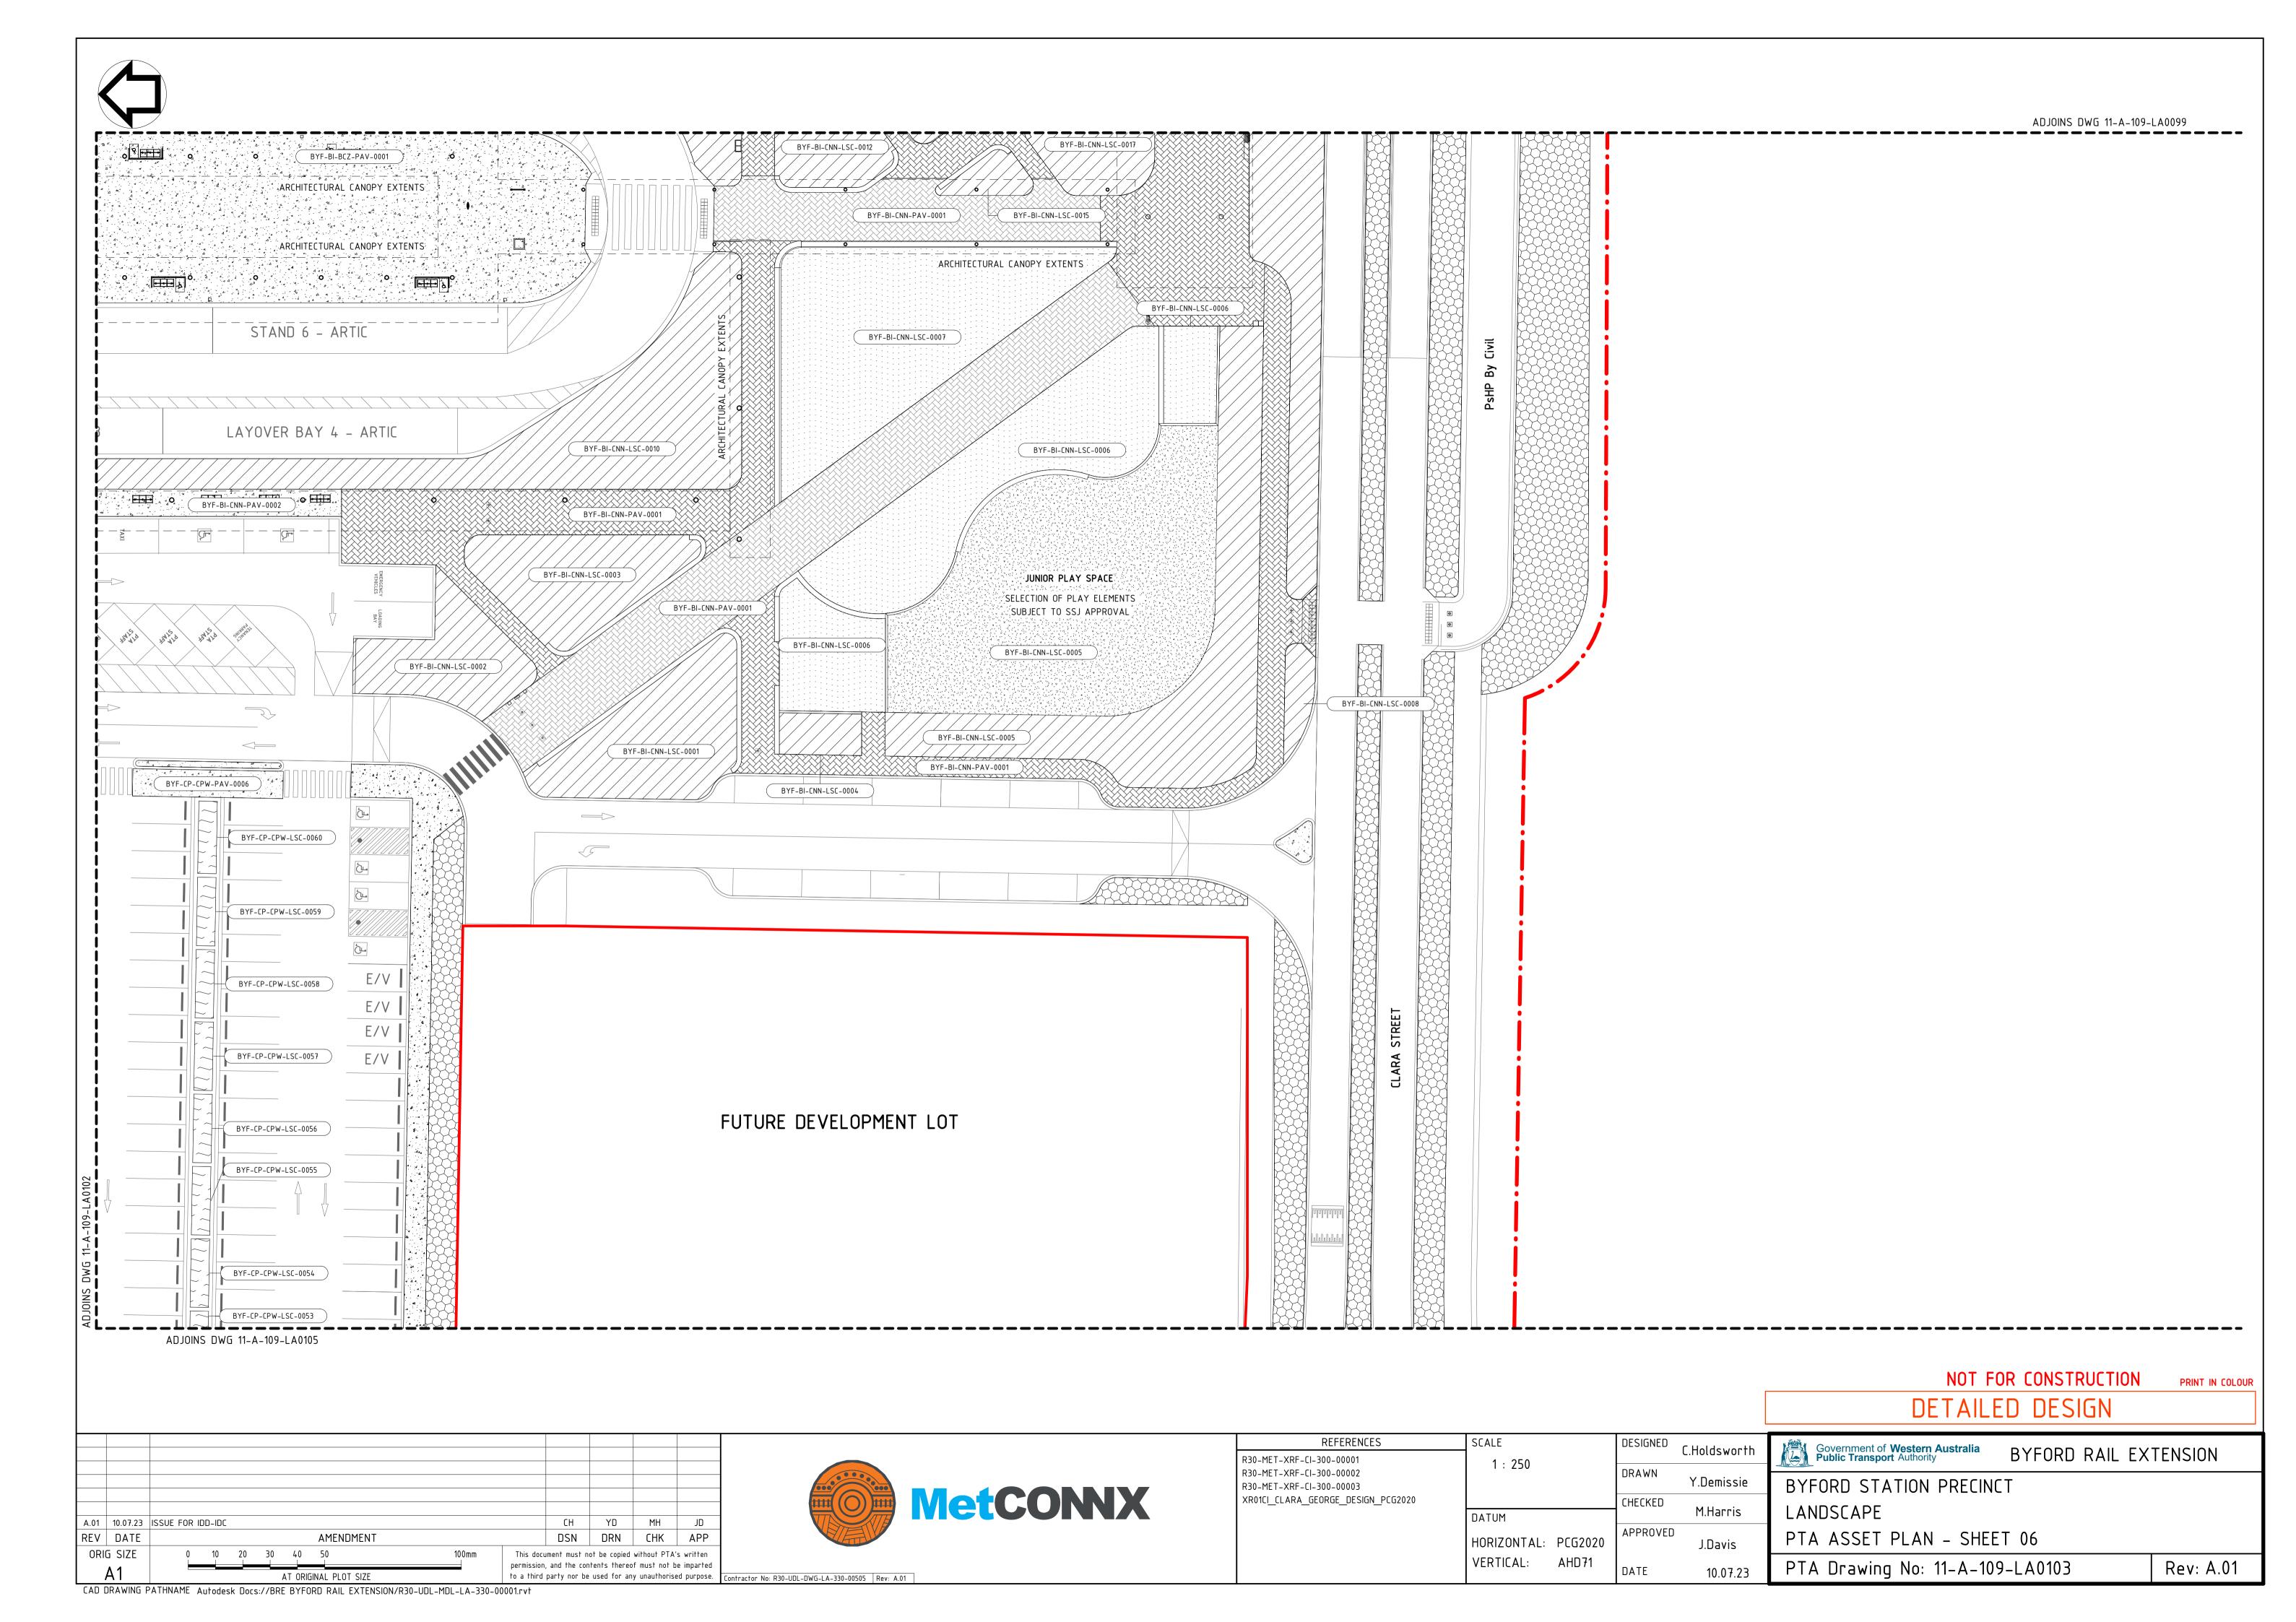


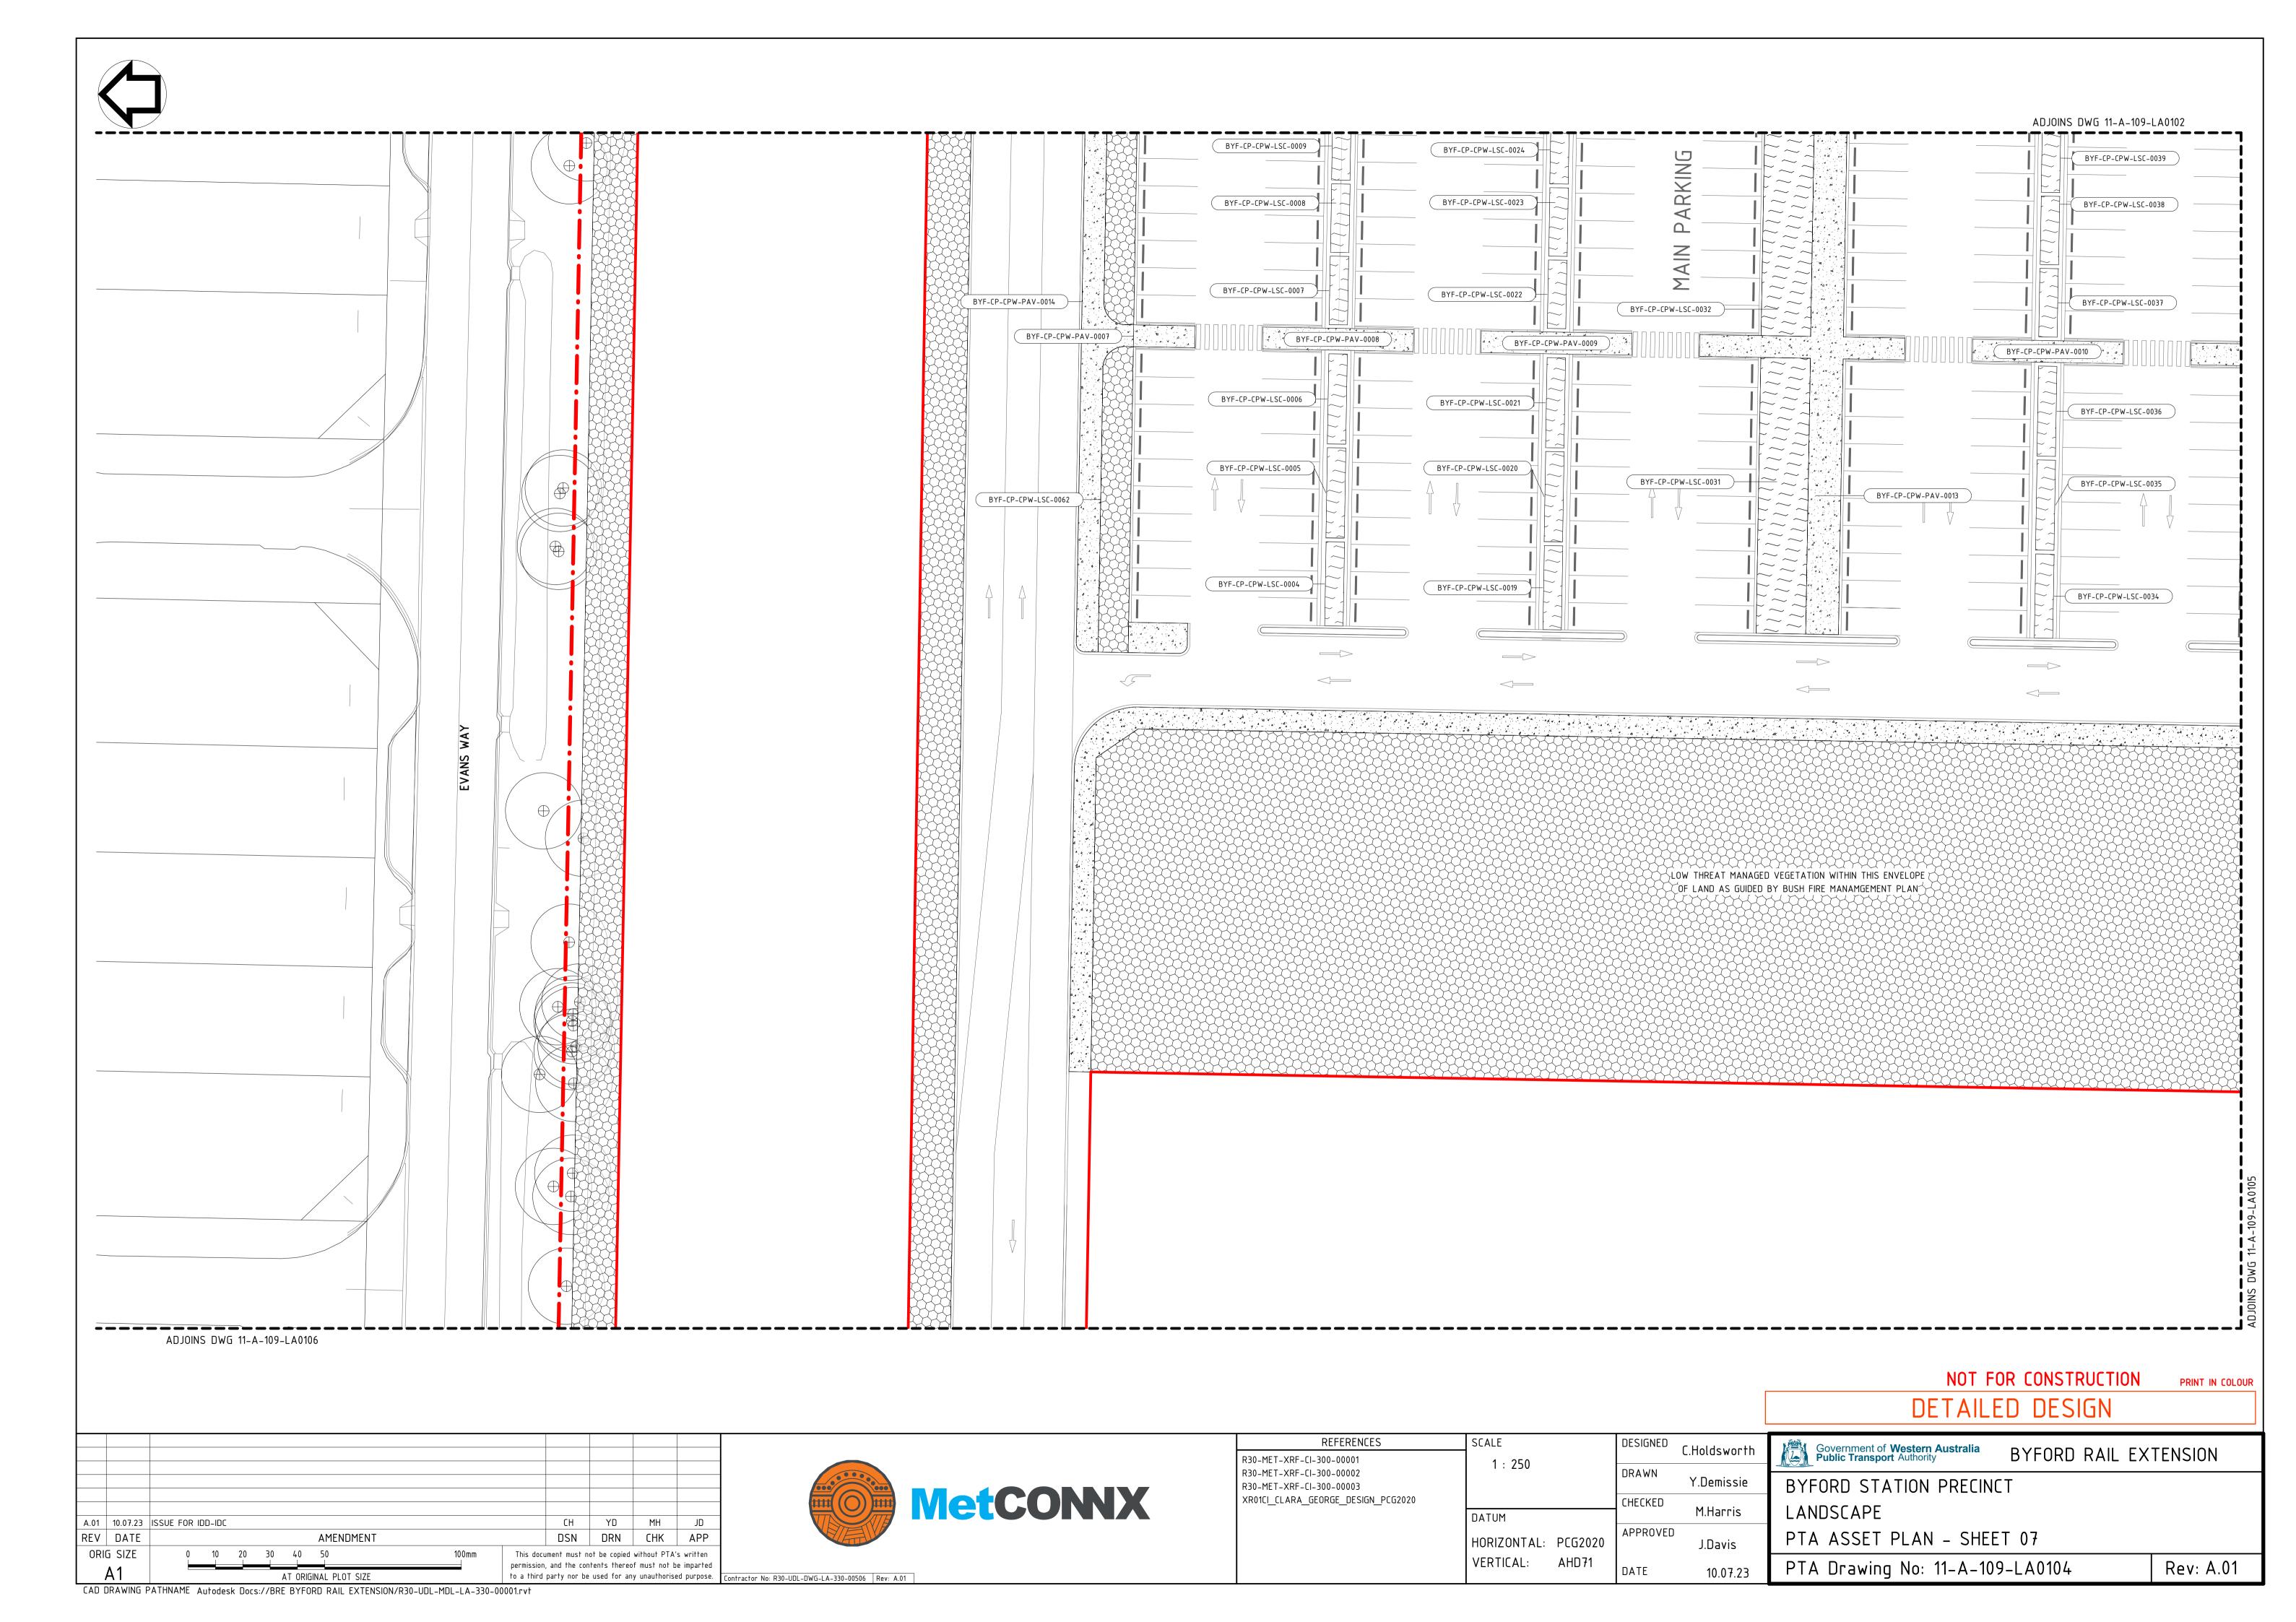


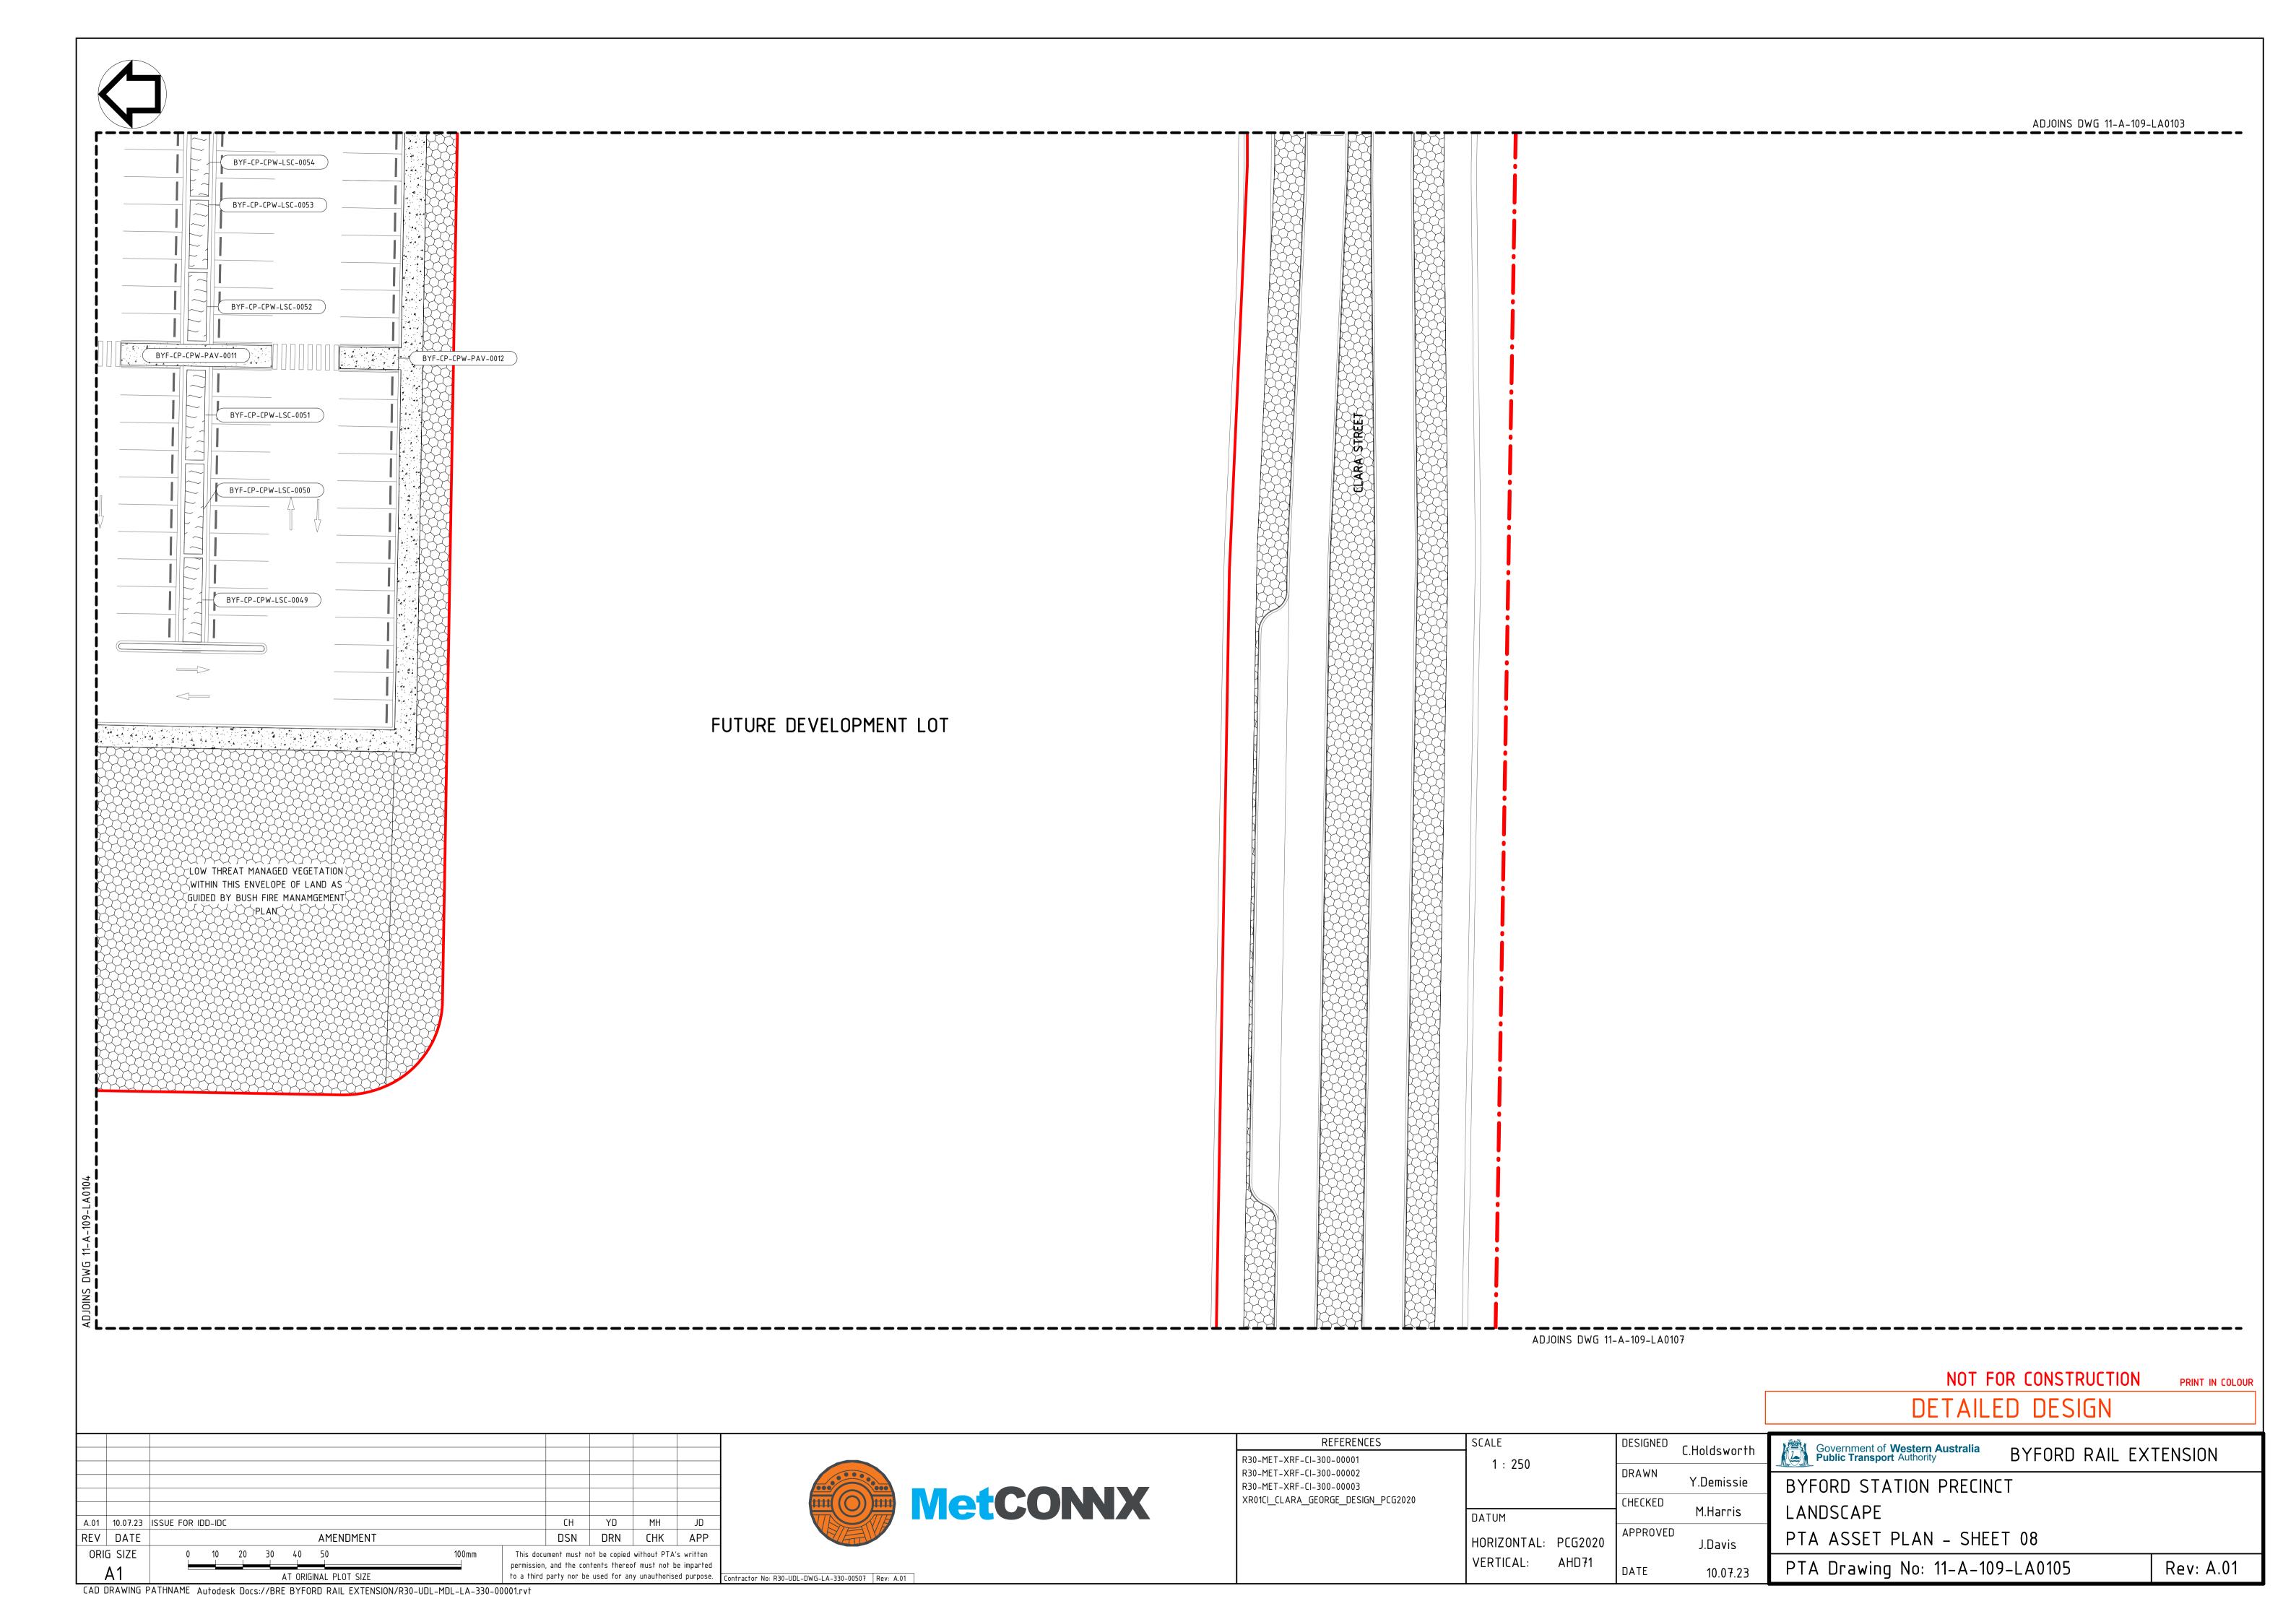

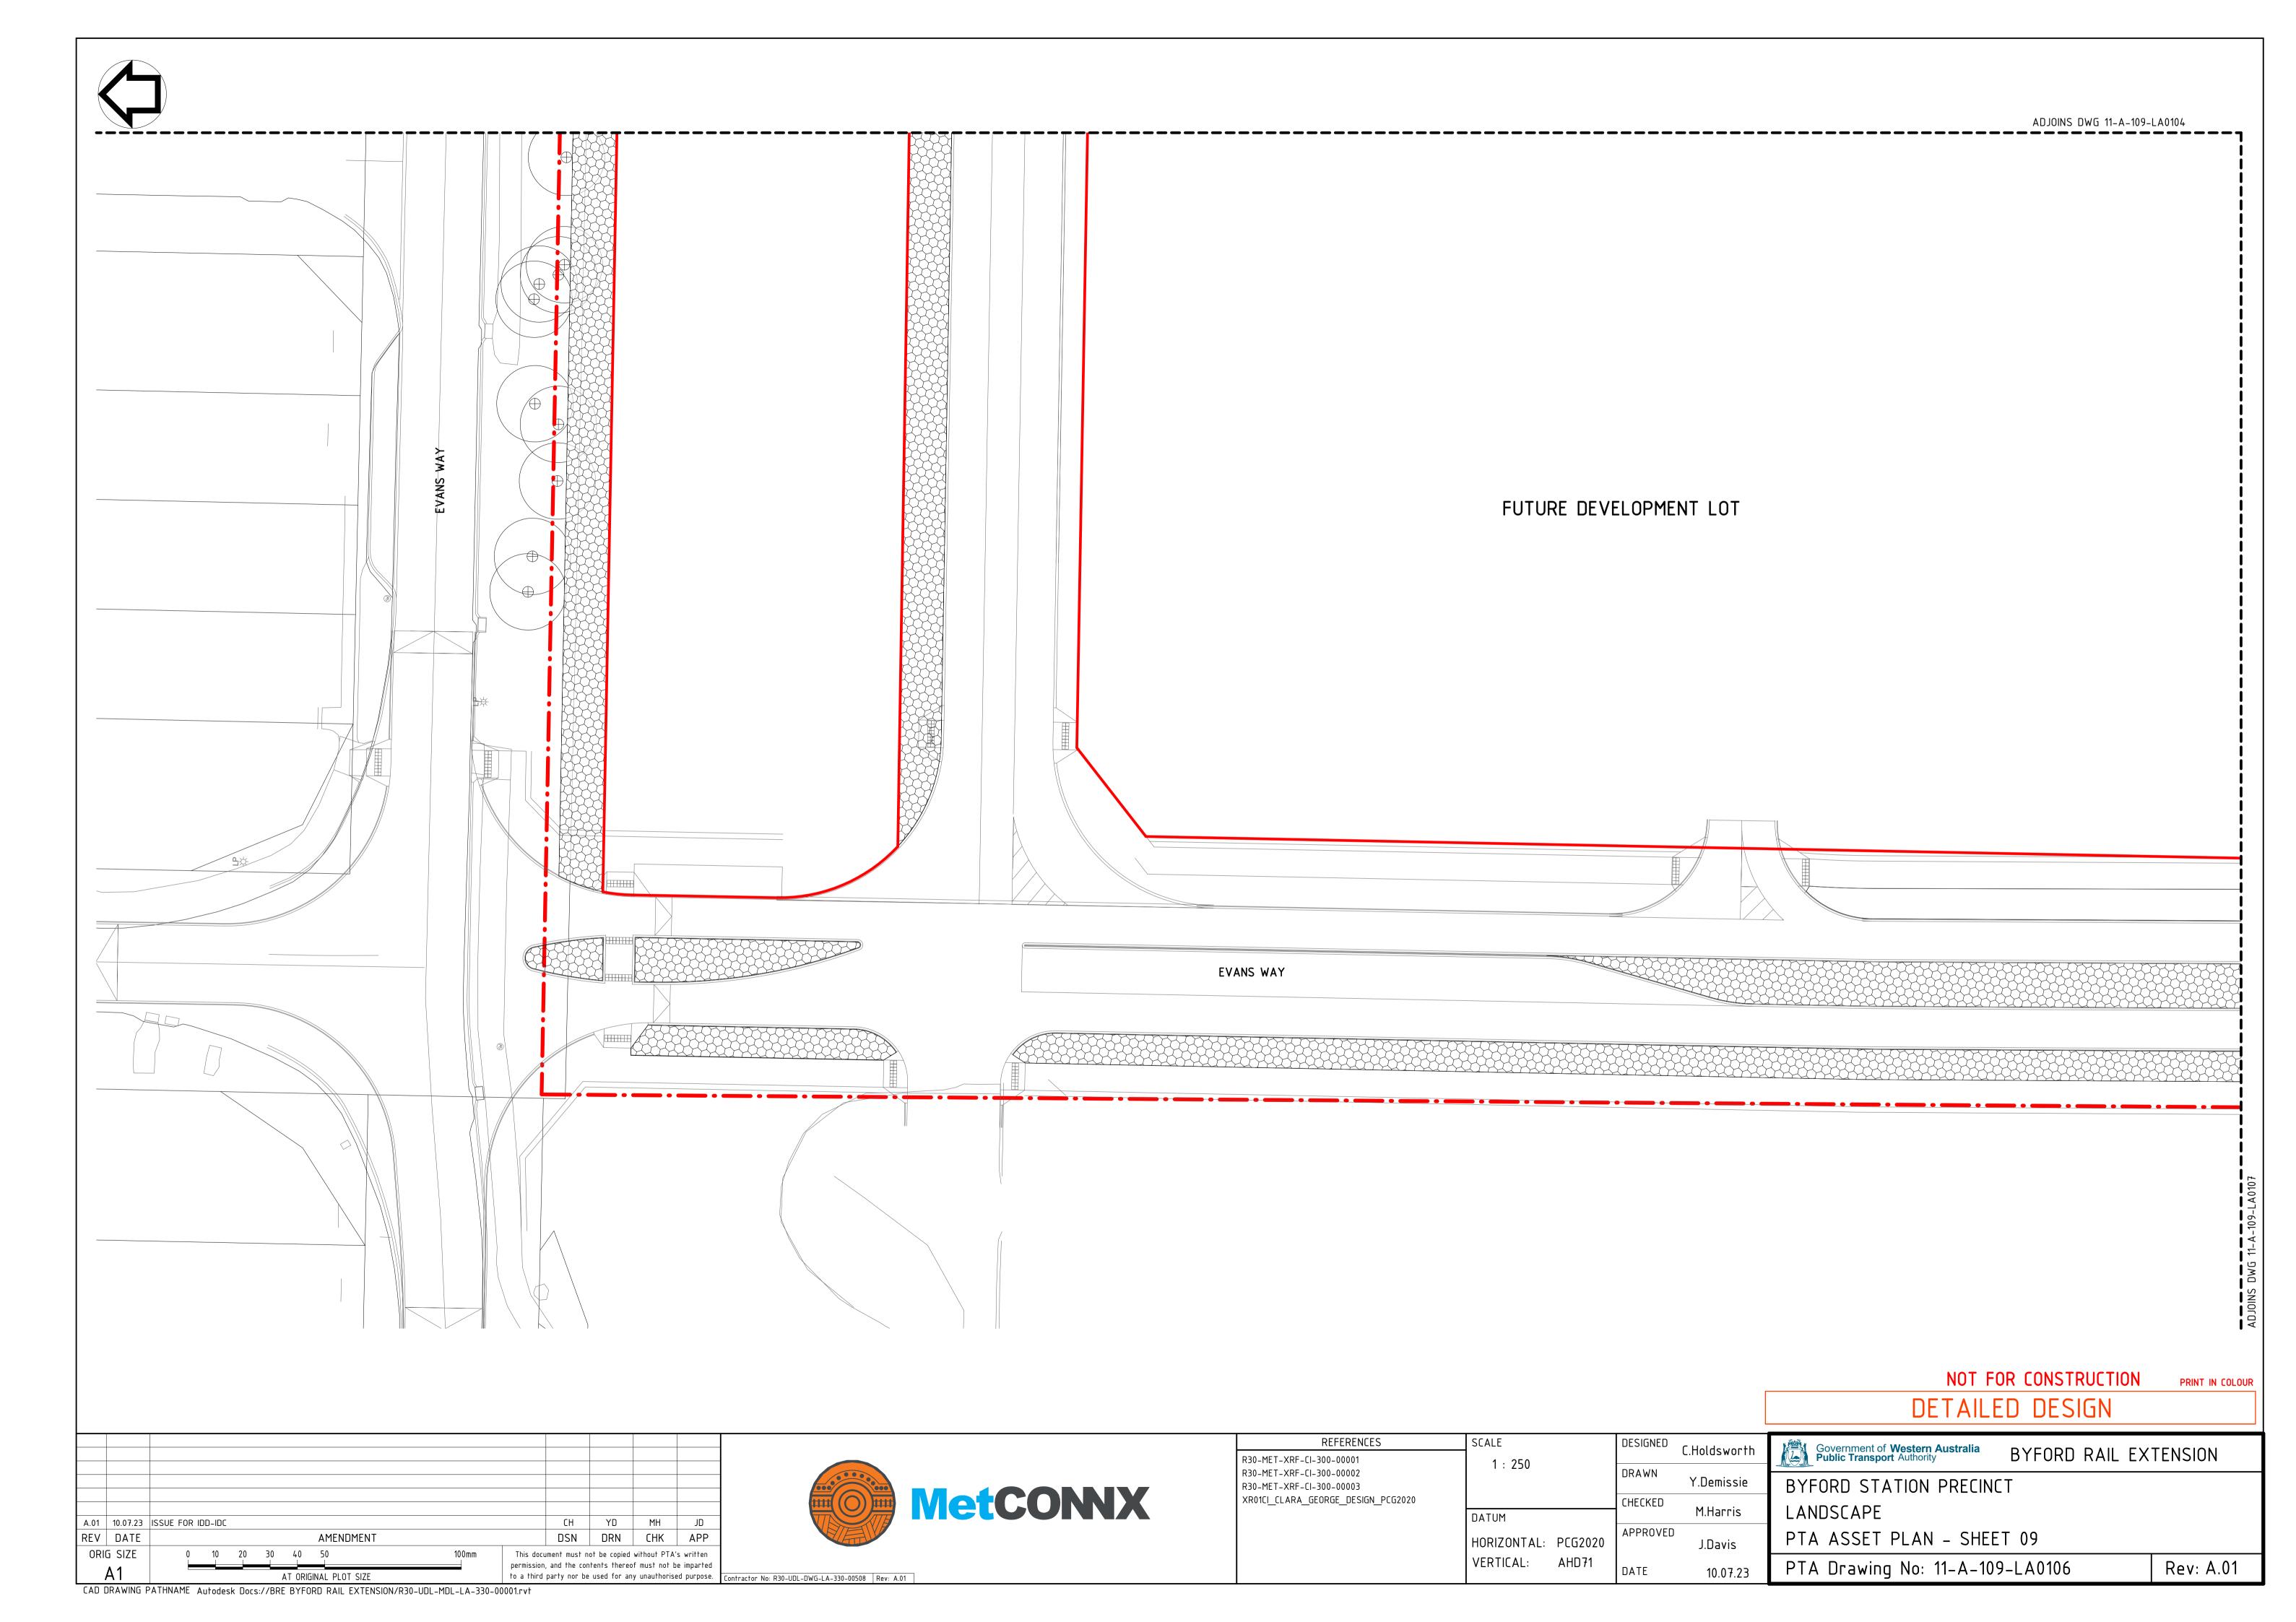

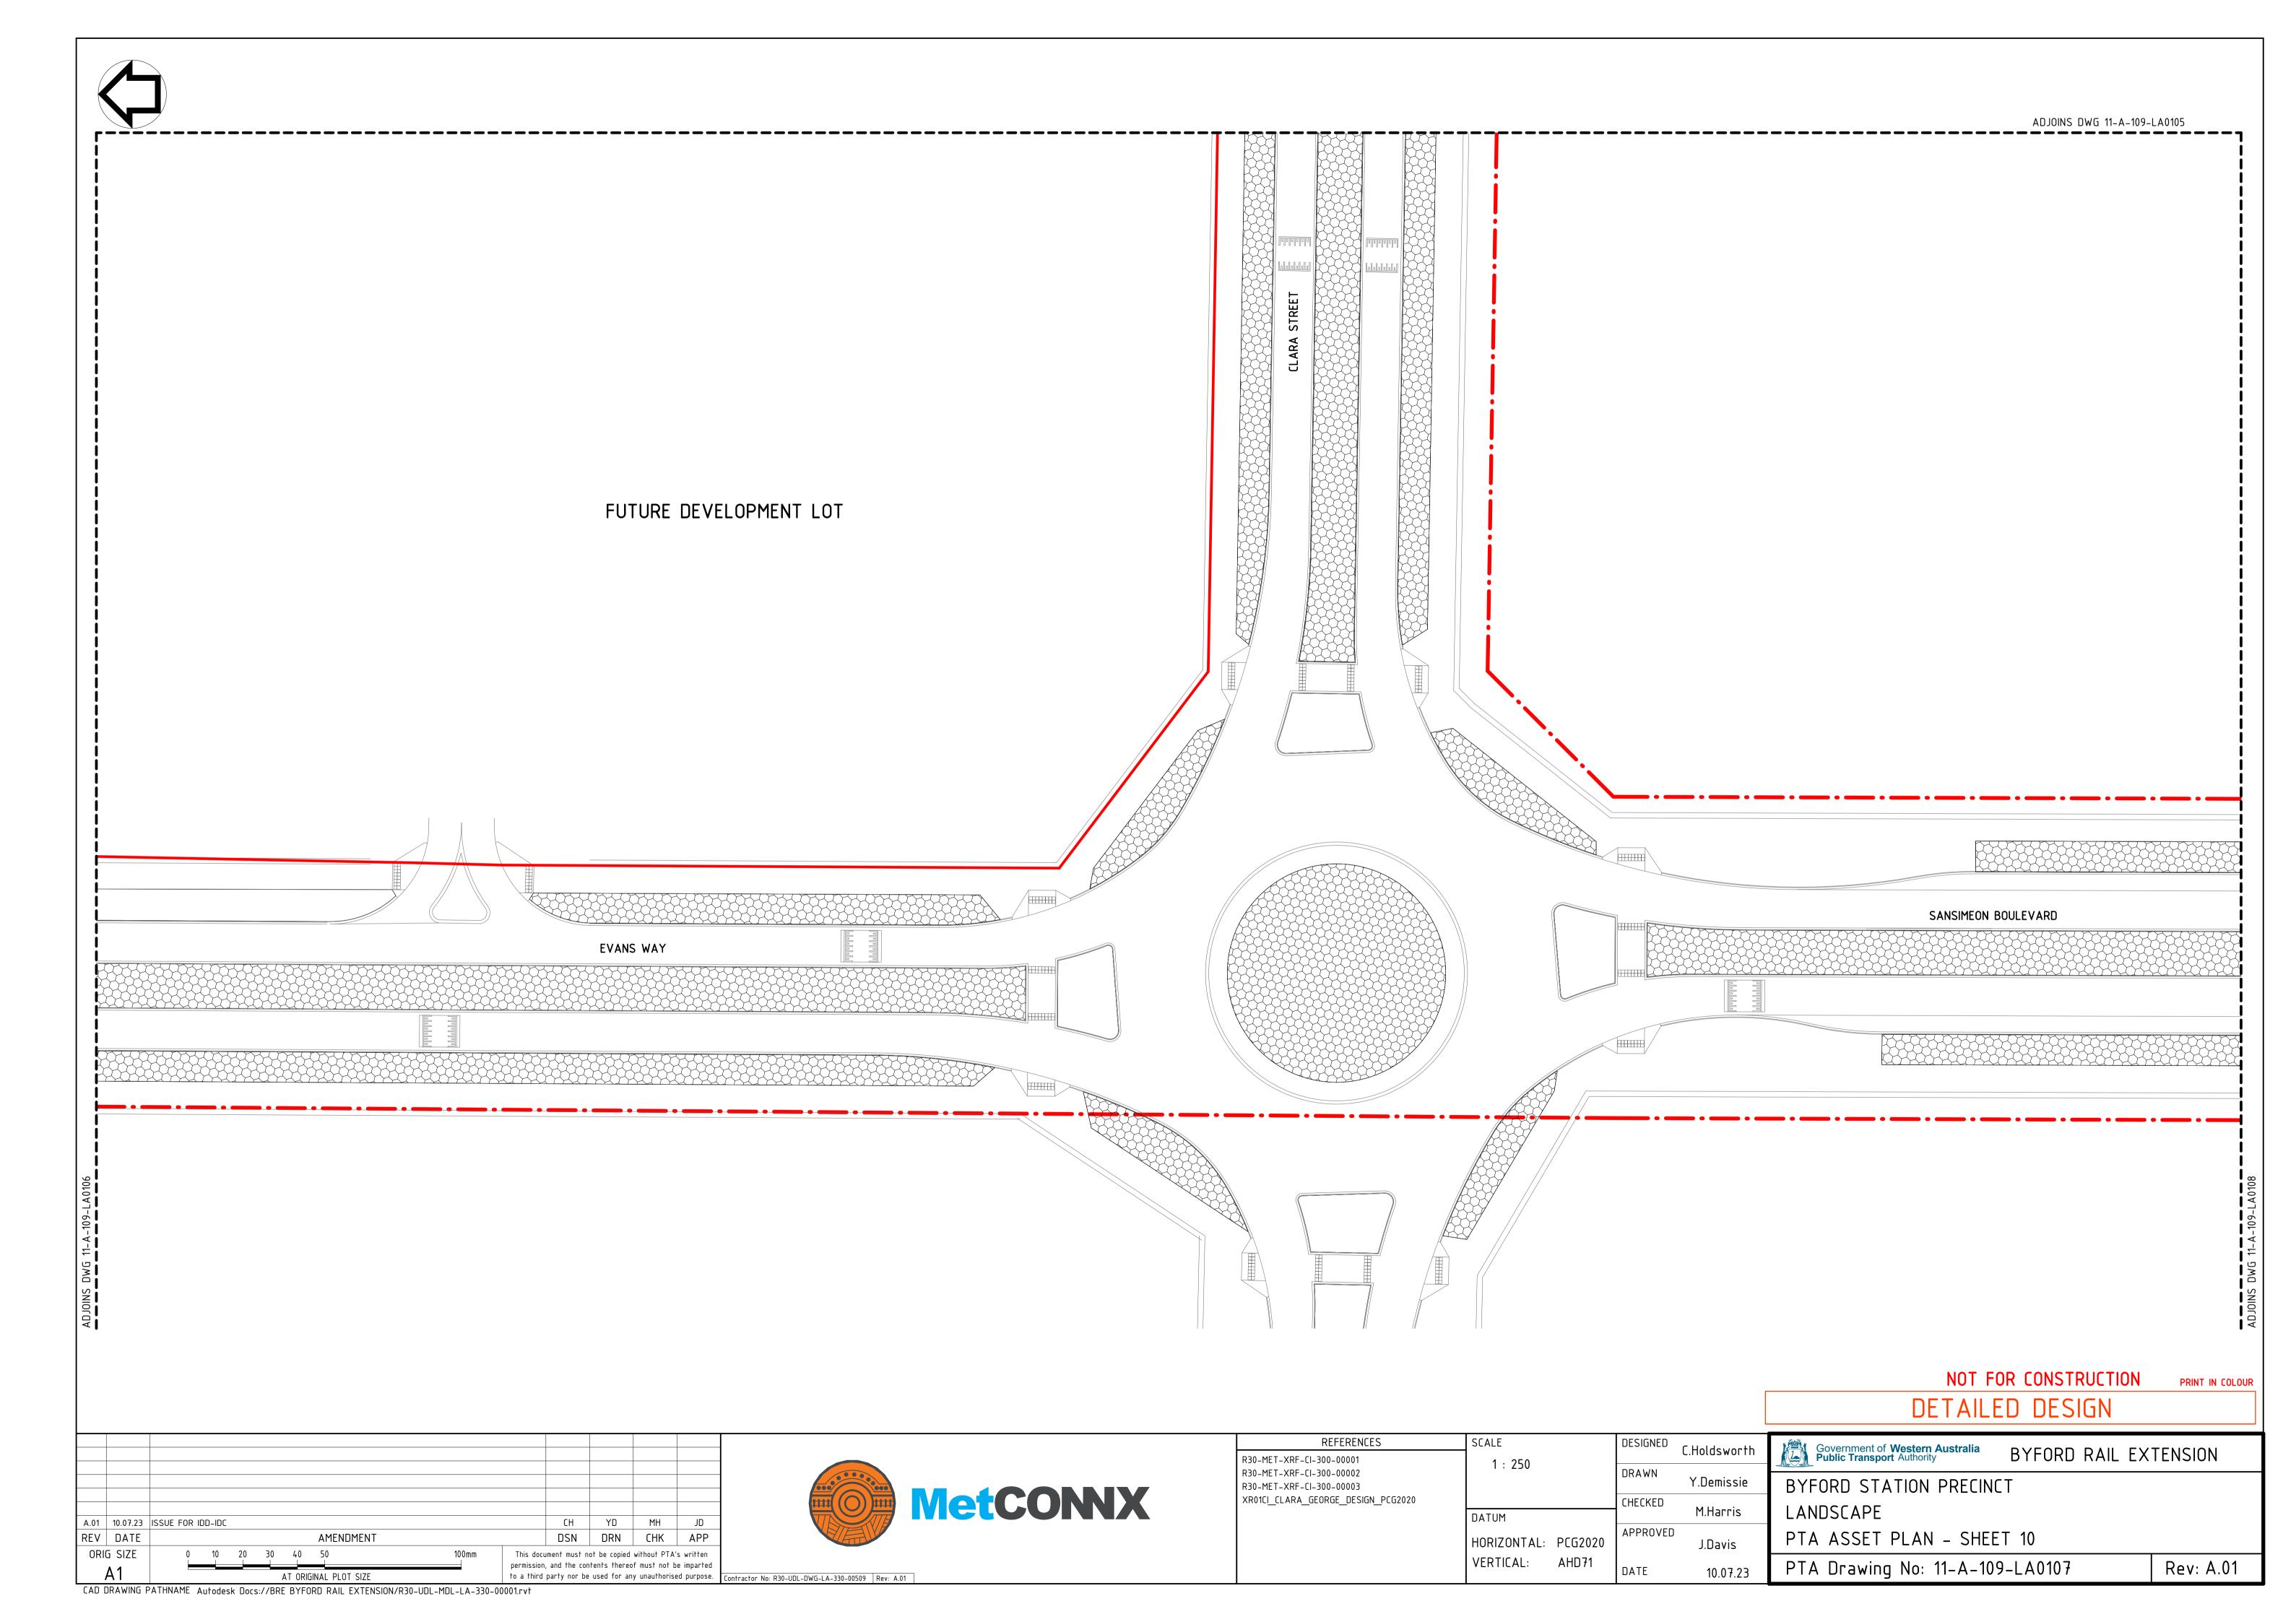

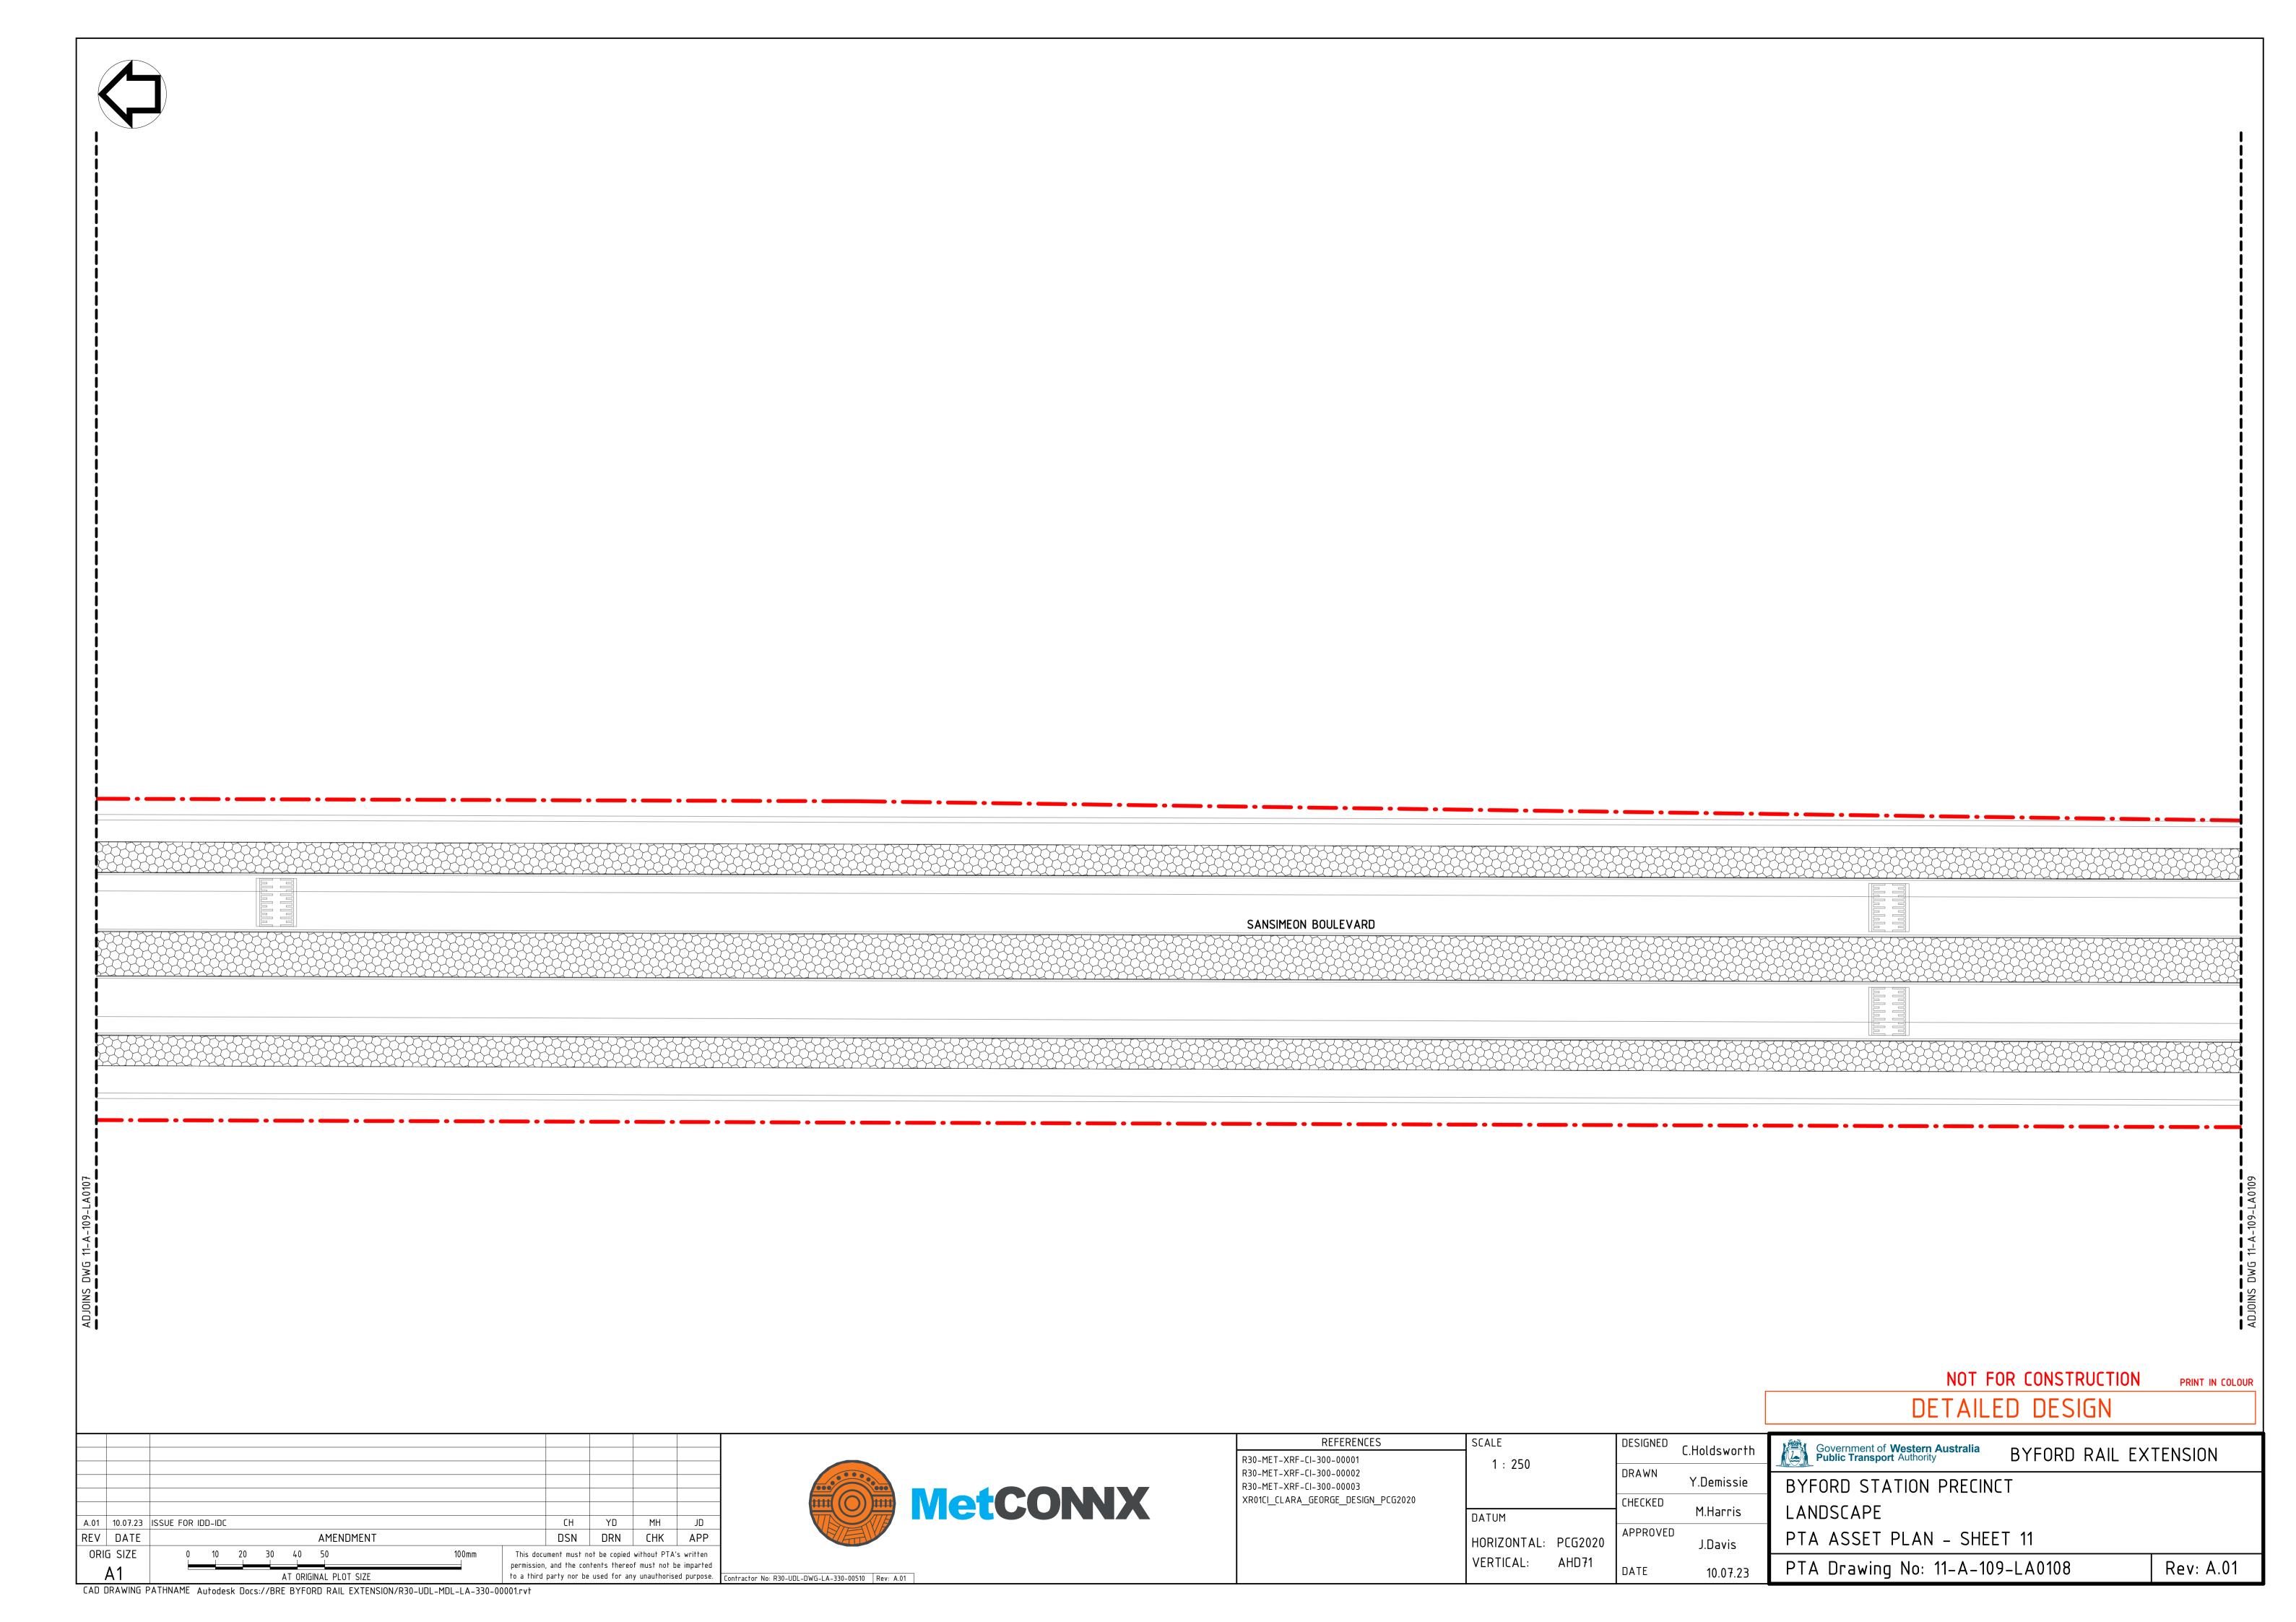

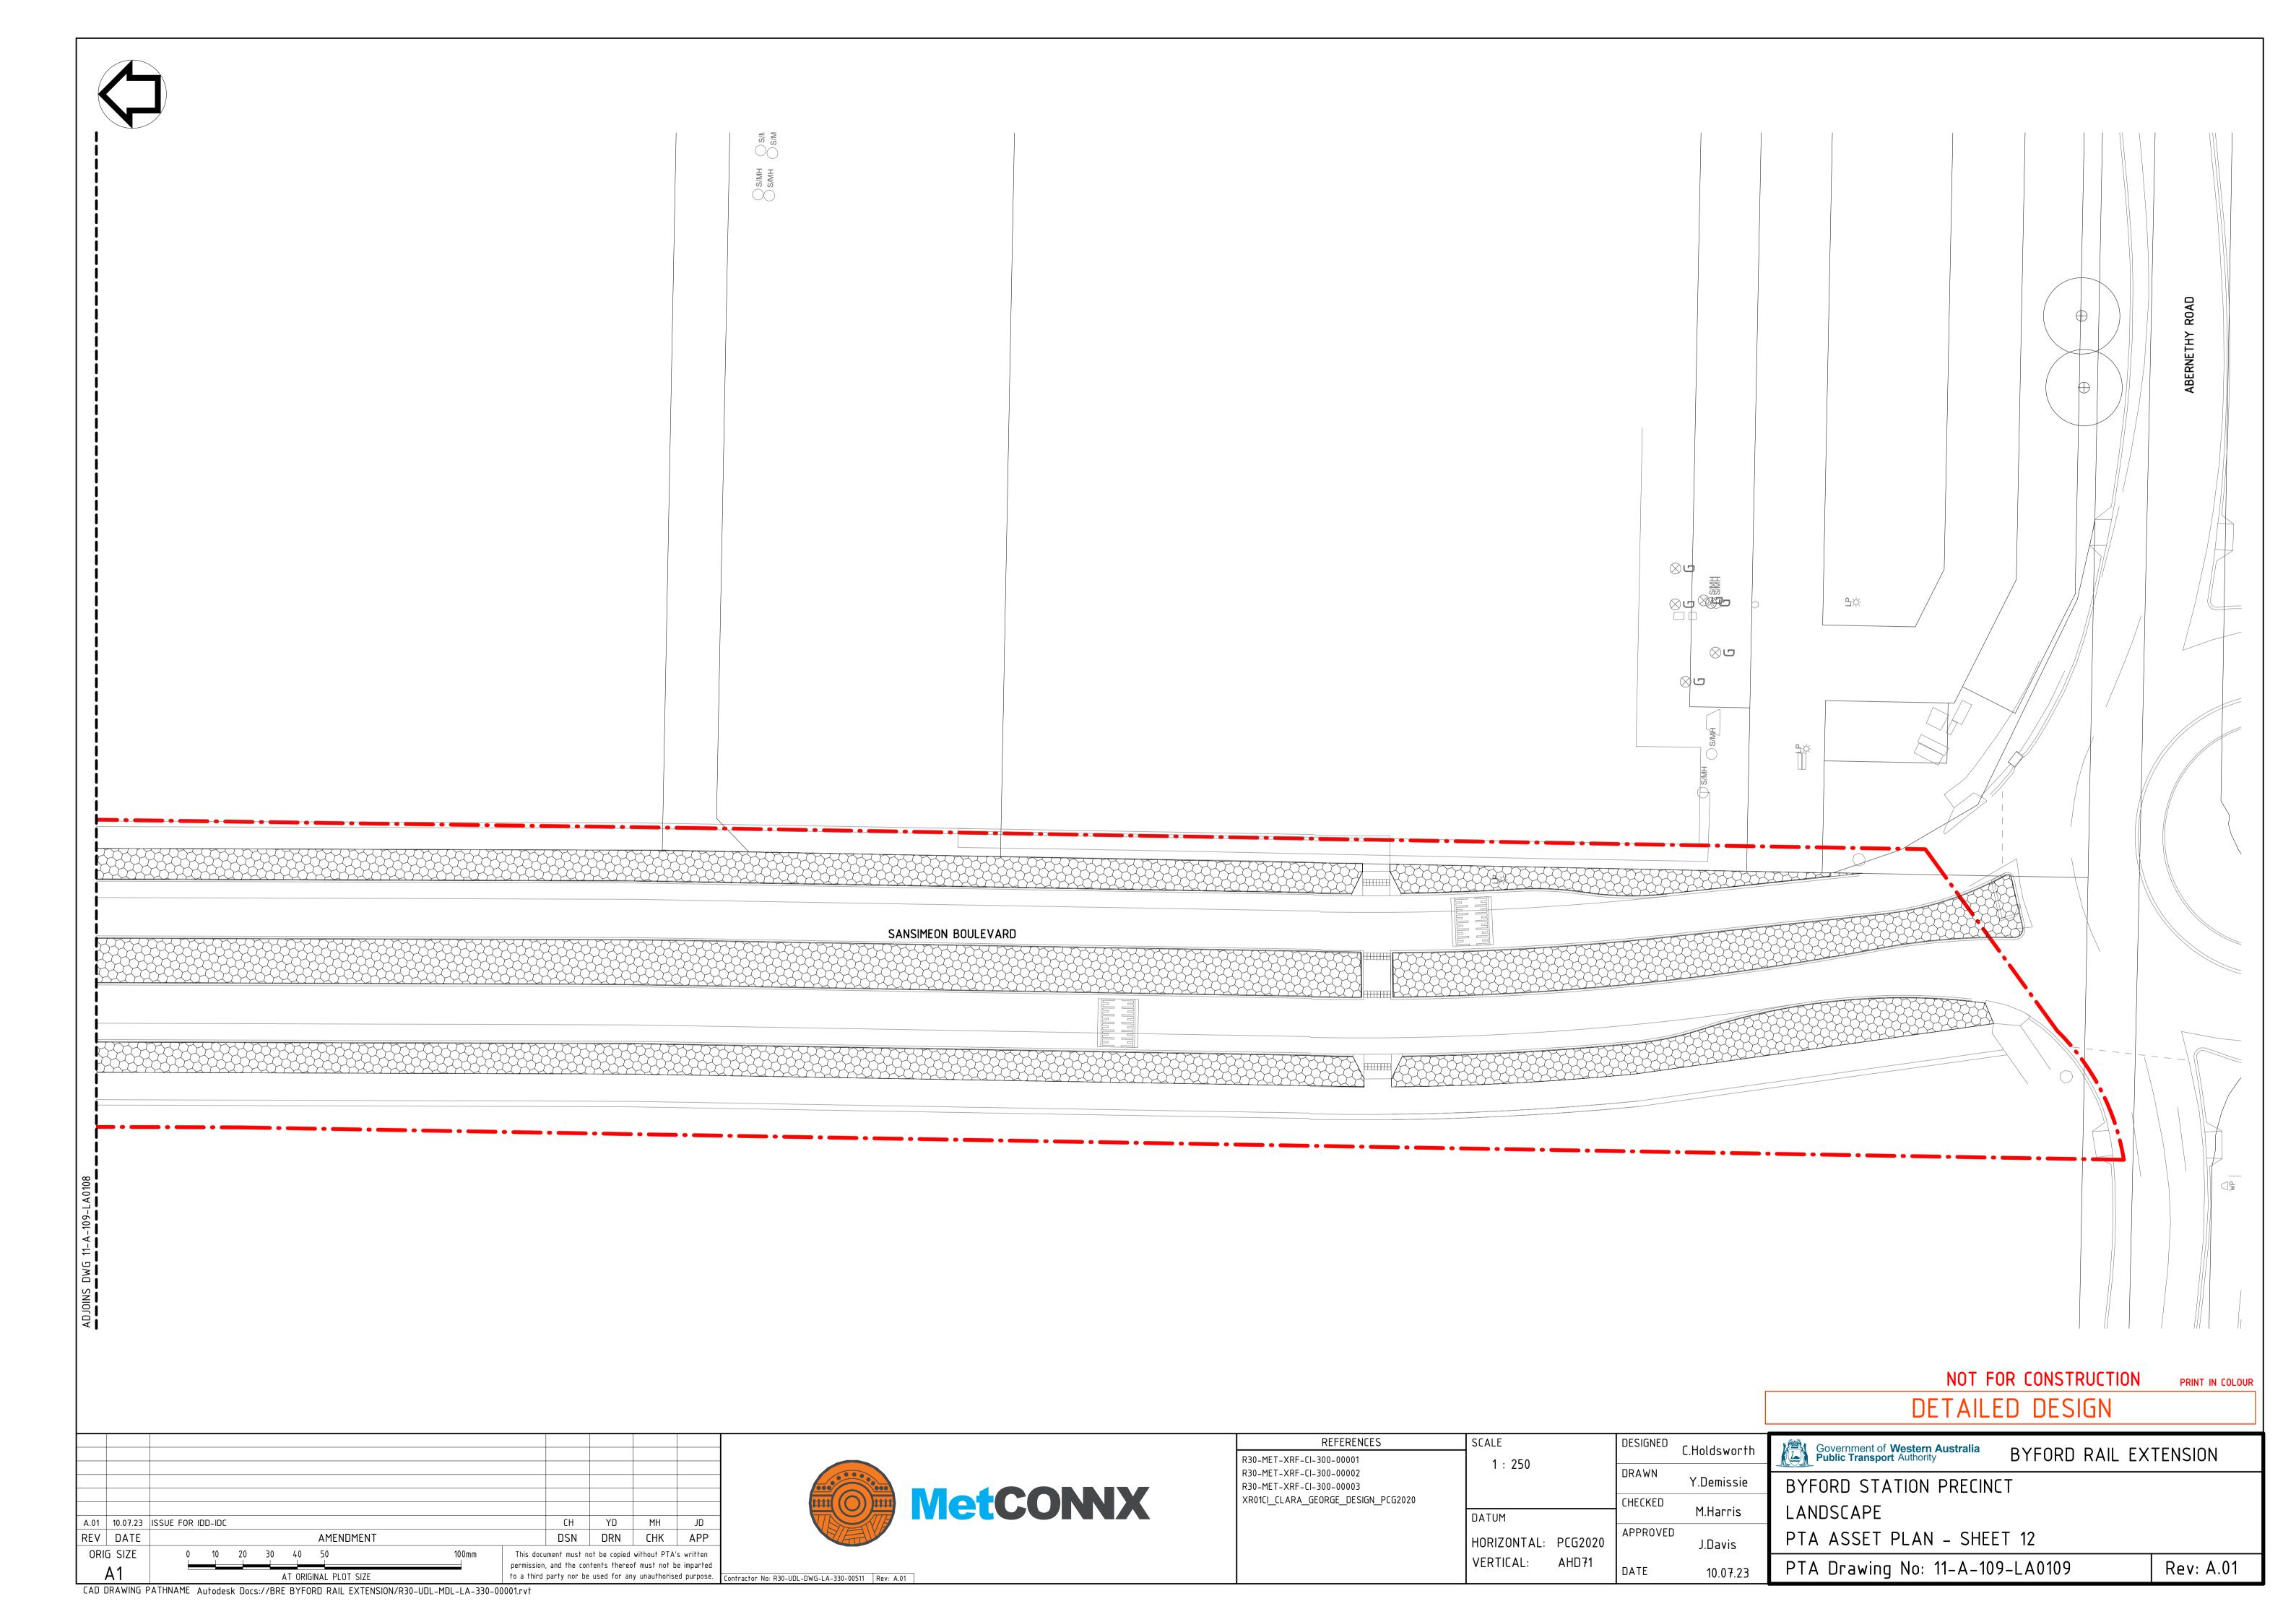

NOTES:

1. ALL DETAILS SUBJECT TO STRUCTURAL ENGINEER REVIEW.

NOTE:


INDICATIVE PIXELATED PAVING DESIGN INTENT. DETAIL PLAN TO FOLLOW




CONCRETE UNIT PAVER (P2-01A) DESIGN INTENT

1: 10

MIN 2.5% FALL AWAY FROM ALL STRUCTURES

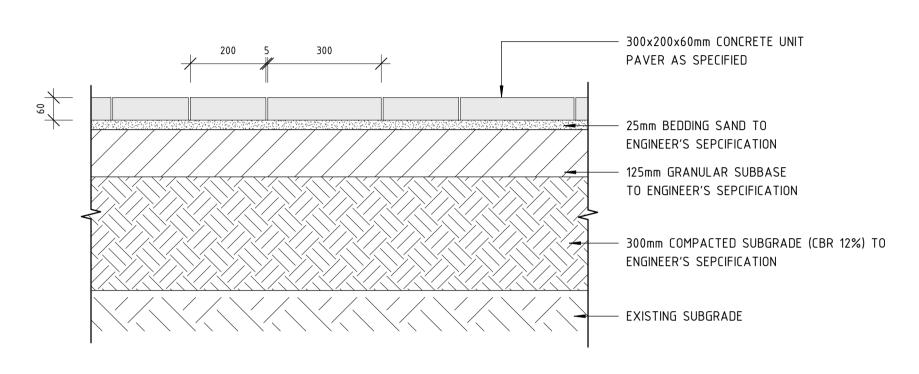


2 CONCRETE UNIT PAVER (P2-01A)
1: 10

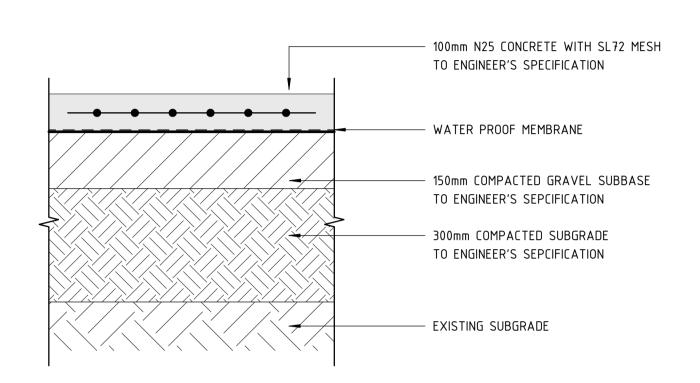


3 INSITU CONCRETE EXP. AGG (P1-01A)

1: 10

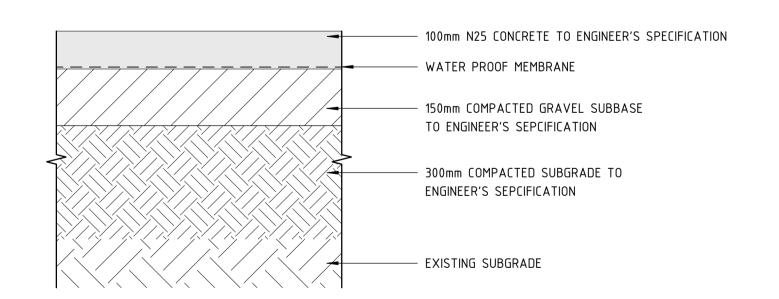

STANDARD GREY CONCRETE (P1-05B)

1:10

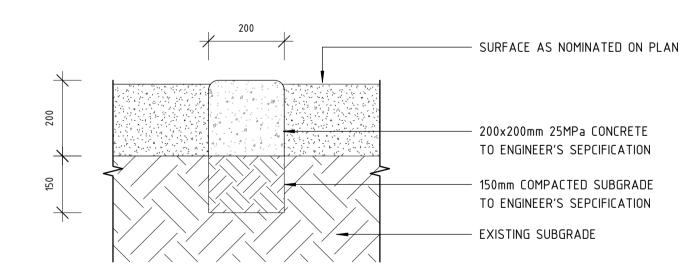

MOW KERB - EDGE RESTRAINT (E1-02A)

1:10

B.01	10.07.23	ISSUE FOR IDD-IDC	СН	MC	MH	JD
Α	12.10.22	ISSUE FOR RD	CH	YD	MH	AE
REV	DATE	AMENDMENT	DSN	DRN	CHK	APP
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REFERENCES	SCALE 1 : 10	DESIGNED	C.Holdsworth	Go Pul
		DRAWN	Y.Demissie	BYFO
	DATUM	CHECKED	M.Harris	LAND
	HORIZONTAL: PCG2020	APPROVED	J.Davis	HARD
	VERTICAL: AHD71	DATE	10.07.23	РТА

DETAILED DESIGN
Government of Western Australia Public Transport Authority BYFORD RAIL EXTENSION
BYFORD STATION PRECINCT
LANDSCAPE
HARDSCAPE DETAILS 01
PTA Drawing No: 11-A-109-LA0118 Rev: B.01


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PRINT IN COLOUR

CAD DRAWING PATHNAME Autodesk Docs://BRE BYFORD RAIL EXTENSION/R30-UDL-MDL-LA-330-00001.rvt



ALL DETAILS SUBJECT TO STRUCTURAL ENGINEER REVIEW.
 ALL DETAILS SUBJECT TO ACCESS CONSULTANT REVIEW.

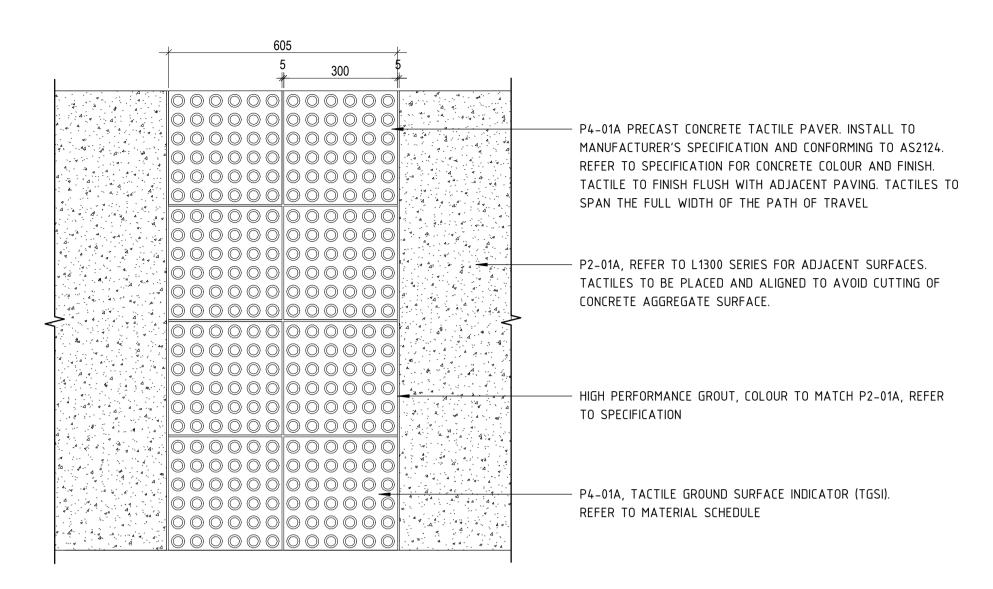

1 HAZARD TACTILE UNITS (P4-01A) - PLAN
1: 10

P4-01A PRECAST CONCRETE HAZARD TACTILE PAVER - INSTALL TO MANUFACTURER'S SPECIFICATION AND CONFORMING TO AS2124, REFER TO SPECIFICATION FOR CONCRETE AGGREGATE SURFACE.

HIGH PERFORMANCE GROUT, COLOUR TO MATCH P2-01A, REFER TO SPECIFICATION

HIGH PERFORMANCE GROUT, COLOUR TO MATCH P2-01A, REFER TO SPECIFICATION


P2-01A, 100mm N25 CONCRETE WITH SL72 MESH TO ENGINEER'S SPECIFICATION. HAZARD TACTILES TO BE PLACED AND ALIGNED TO AVOID CUTTING OF CONCRETE AGGREGATE SURFACE.

WATERPROOF MEMBRANCE


150mm COMPACTED GRAVEL SUBBASE TO ENGINEER'S SEPCIFICATION

EXISTING SUBGRADE TO ENGINEER'S SEPCIFICATION

3 INTEGRATED TACTILE UNITS (P4-01A) - SECTION

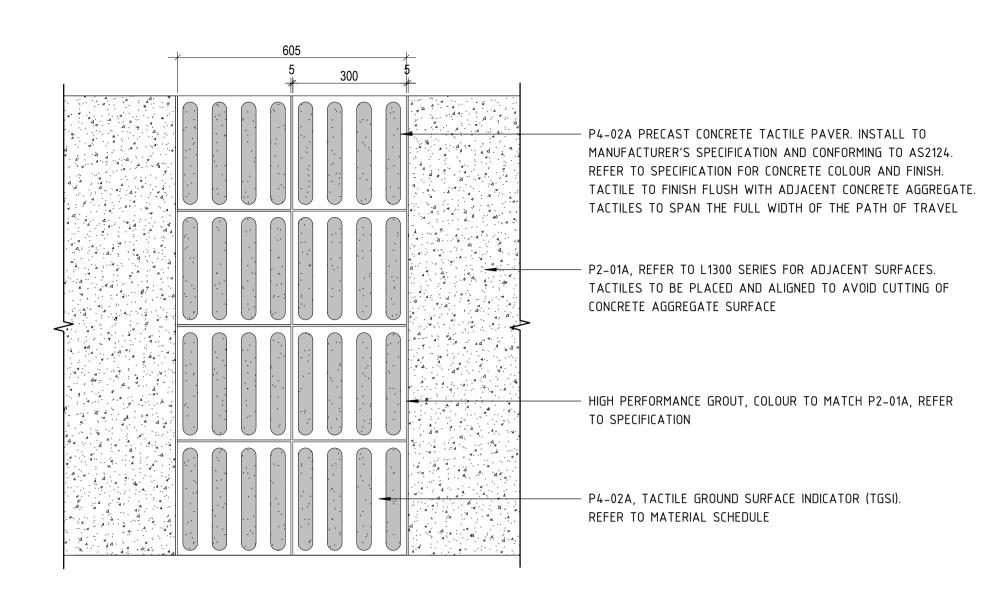


DIRECTIONAL TACTILE UNITS (P4-02A) - PLAN

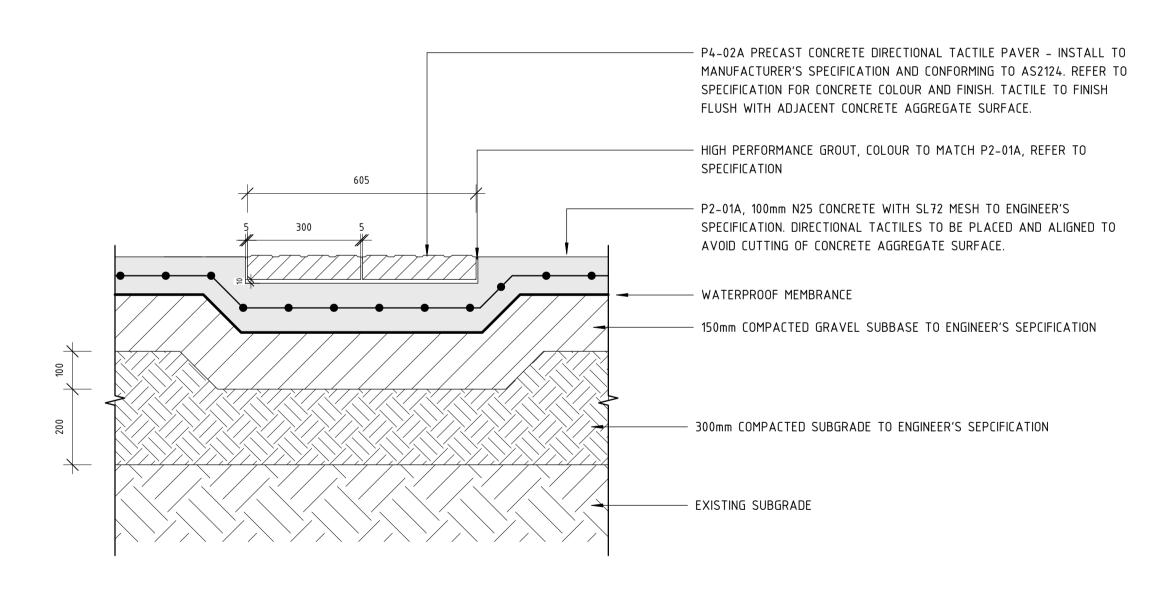

INTEGRATED TACTILE UNITS (P4-02A) - SECTION

1: 10

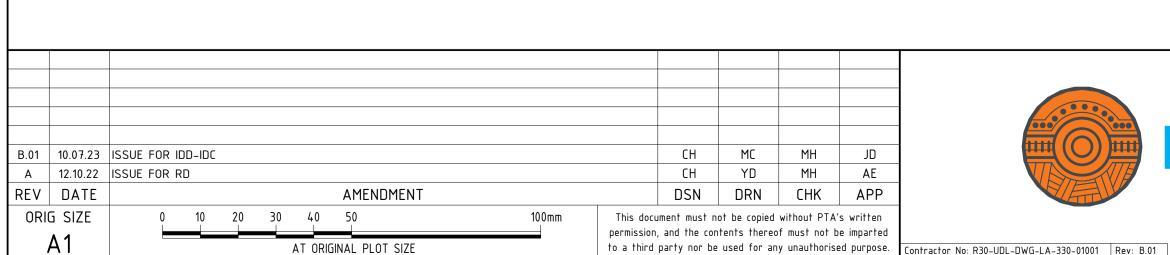



					DETAIL
REFERENCES	SCALE		DESIGNED	C	Covernment of Western Australia
	1 : 10		DD AV (VI	C.Holdsworth	Government of Western Australia Public Transport Authority
			DRAWN	Y.Demissie	BYFORD STATION PRECI
	DATUM		CHECKED	M.Harris	LANDSCAPE
	DATUM		APPROVED		HARDSCAPE DETAILS 02
	HORIZONTAL:			J.Davis	HARDSCAPE DETAILS 02
	VERTICAL:	AHD71	DATE	10.07.23	PTA Drawing No: 11-A-1

DETAILED DESIGN

Government of Western Australia
BYFORD RAIL EXTENSION

BYFORD STATION PRECINCT

LANDSCAPE
HARDSCAPE DETAILS 02

PTA Drawing No: 11-A-109-LA0119


Rev: B.01

NOT FOR CONSTRUCTION

PRINT IN COLOUR


NOTES:

1. ALL DETAILS SUBJECT TO STRUCTURAL ENGINEER REVIEW.

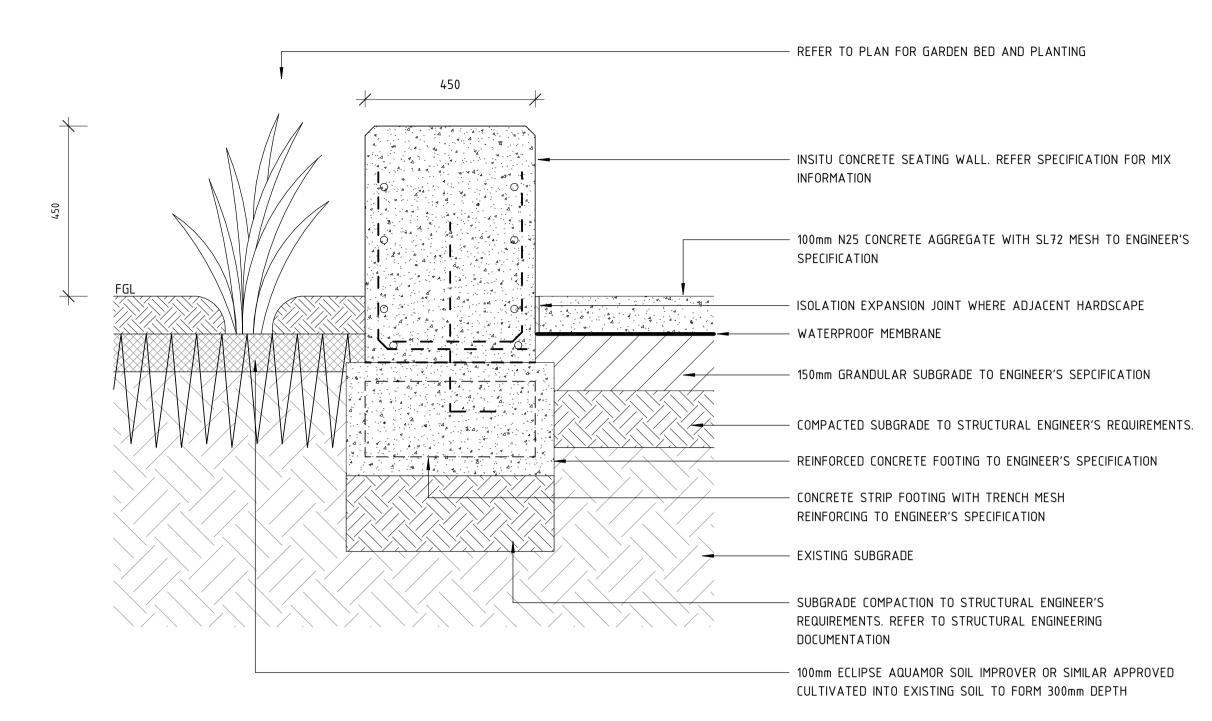


CONCRETE SEATING WALL (CONC. AGG/GARDEN BED)


1: 10

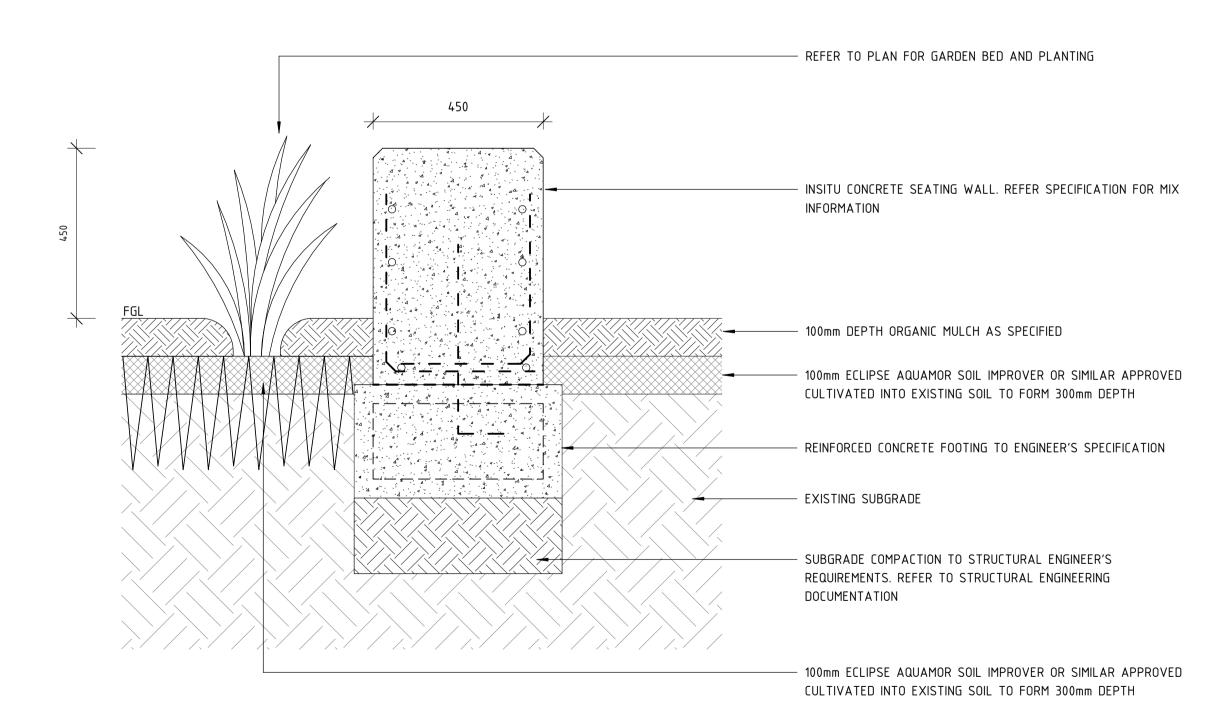

CONCRETE SEATING WALL (MULCH/GARDEN BED)

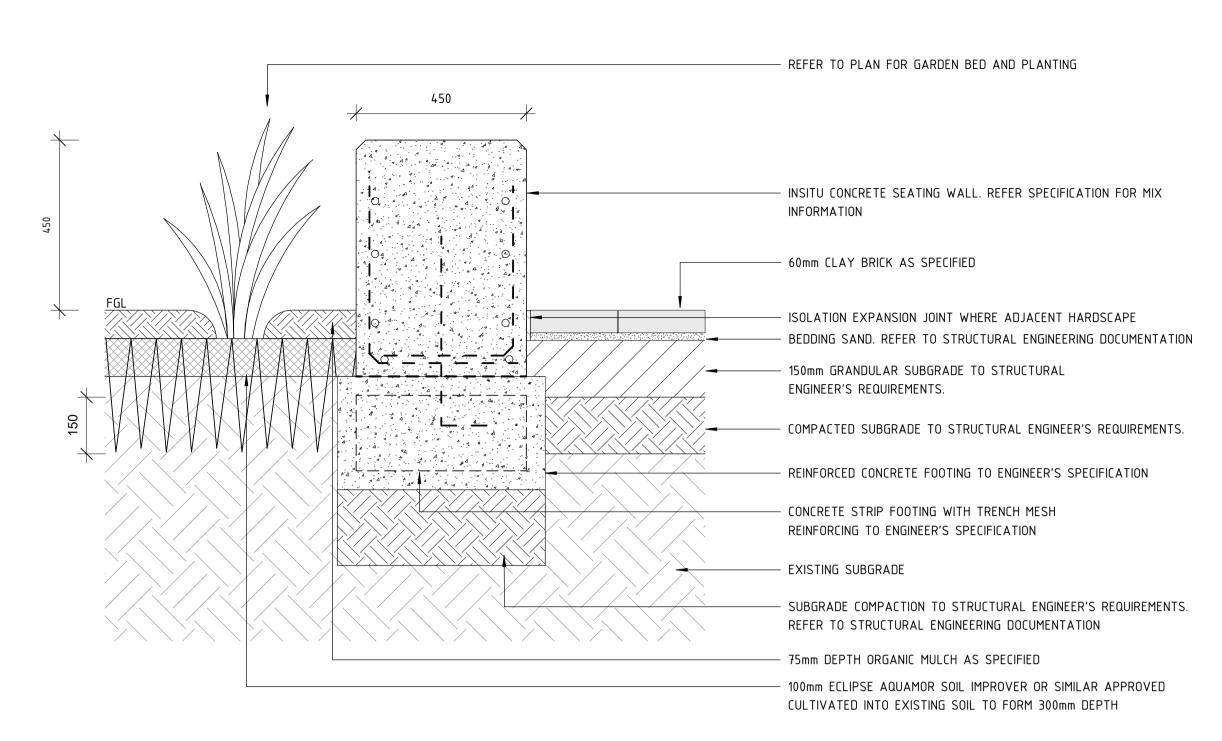

2 CONCRETE SEATING WALL (PAVEMENT/GARDEN BED)

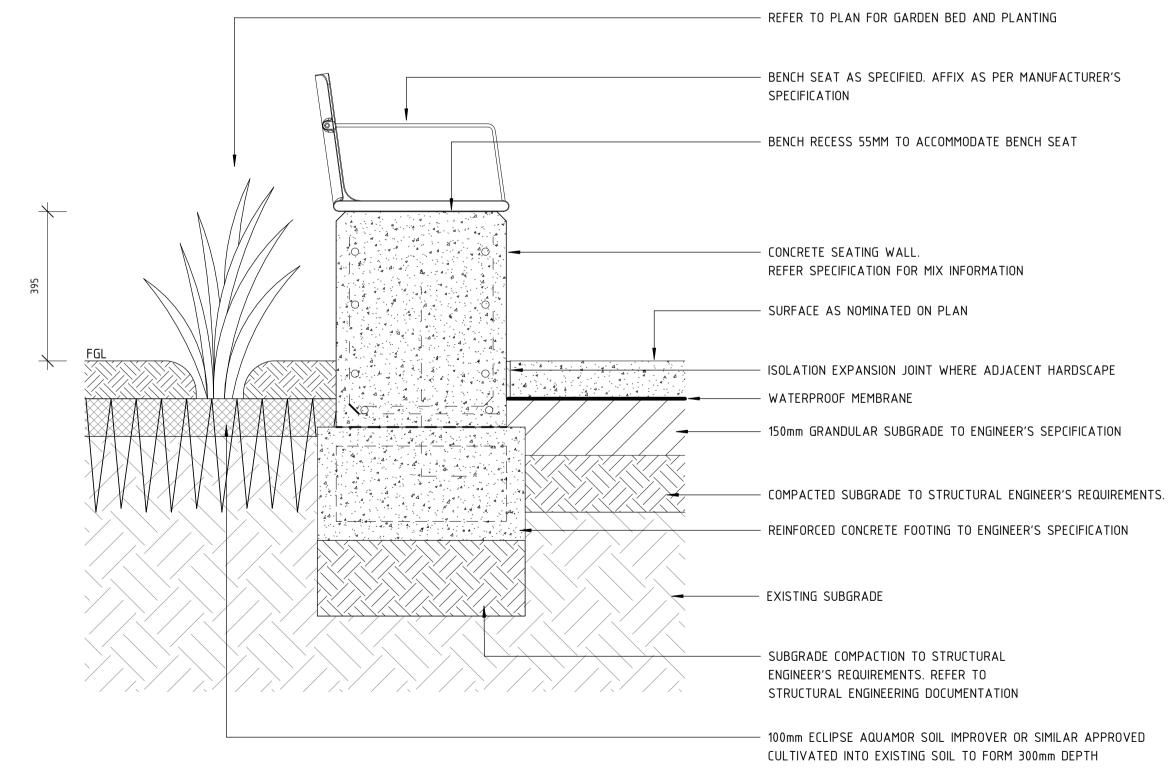

CONCRETE SEATING WALL W/ BENCH SEAT (F4-01B) - SECTION

B.01	10.07.23	ISSUE FOR IDD-IDC	СН	MC	MH	JD
Α	12.10.22	ISSUE FOR RD	CH	YD	MH	AE
REV	DATE	AMENDMENT	DSN	DRN	CHK	APP
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				L
REFERENCES	SCALE		DESIGNED	C.Holdsworth
	1 : 10		DRAWN	Y.Demissie
	DATUM		CHECKED	M.Harris
	HORIZONTAL:	PCG2020	APPROVED	J.Davis
	VERTICAL:	AHD71	DATE	10.07.23

DETAILED DESIGN

Government of Western Australia
BYFORD RAIL EXTENSION

BYFORD STATION PRECINCT

LANDSCAPE
HARDSCAPE DETAILS 03

PTA Drawing No: 11-A-109-LA0120

Rev: B.01


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PRINT IN COLOUR

AT ORIGINAL PLOT SIZE to a third CAD DRAWING PATHNAME Autodesk Docs://BRE BYFORD RAIL EXTENSION/R30-UDL-MDL-LA-330-00001.rvt

NOTES:

1. ALL DETAILS SUBJECT TO STRUCTURAL ENGINEER REVIEW.

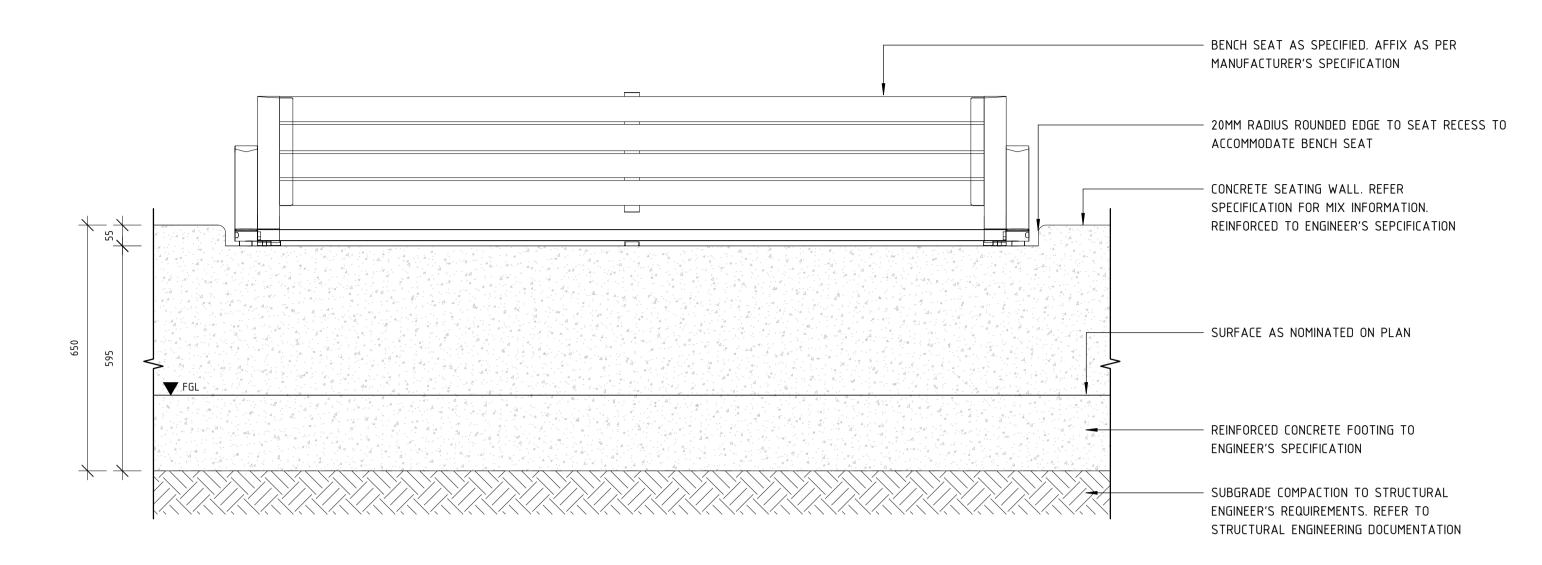

SEATED WALL BACKREST & ARMREST (F4-01B) - FRONT ELEVATION

1: 10

B.01 10.07.23 ISSUE FOR IDD-IDC

A 12.10.22 ISSUE FOR RD

CH YD MH AE

REV DATE

AMENDMENT

DSN DRN CHK APP

ORIG SIZE

0 10 20 30 40 50

100mm

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AT ORIGINAL PLOT SIZE



			L
SCALE	DESIGNED	C.Holdsworth	ſ
1 : 10		C.HUIUSWUITII	
1 : 10	DRAWN	Y.Demissie	l
	CHECKED	M.Harris	
DATUM		11.11011115	ı
HORIZONTAL: PCG2020	APPROVED	J.Davis	
VERTICAL: AHD71	DATE	10.07.23	


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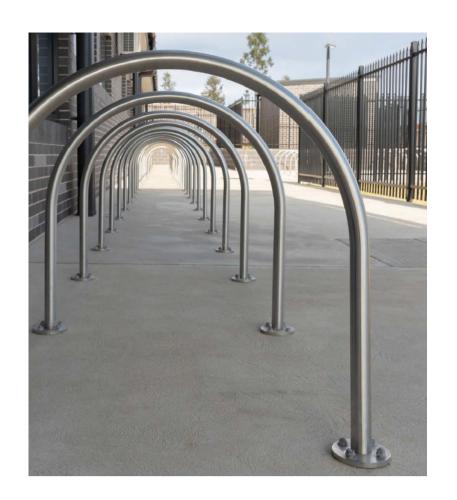
DETAILED DESIGN	
Government of Western Australia BYFORD RAIL EX	TENSION
BYFORD STATION PRECINCT	
LANDSCAPE	
HARDSCAPE DETAILS 04	
PTA Drawing No: 11-A-109-LA0121	Rev: B.01

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to a third party nor be used for any unauthorised purpose. Contractor No: R30-UDL-DWG-LA-330-01003 Rev: B.01

CAD DRAWING PATHNAME Autodesk Docs://BRE BYFORD RAIL EXTENSION/R30-UDL-MDL-LA-330-00001.rvt



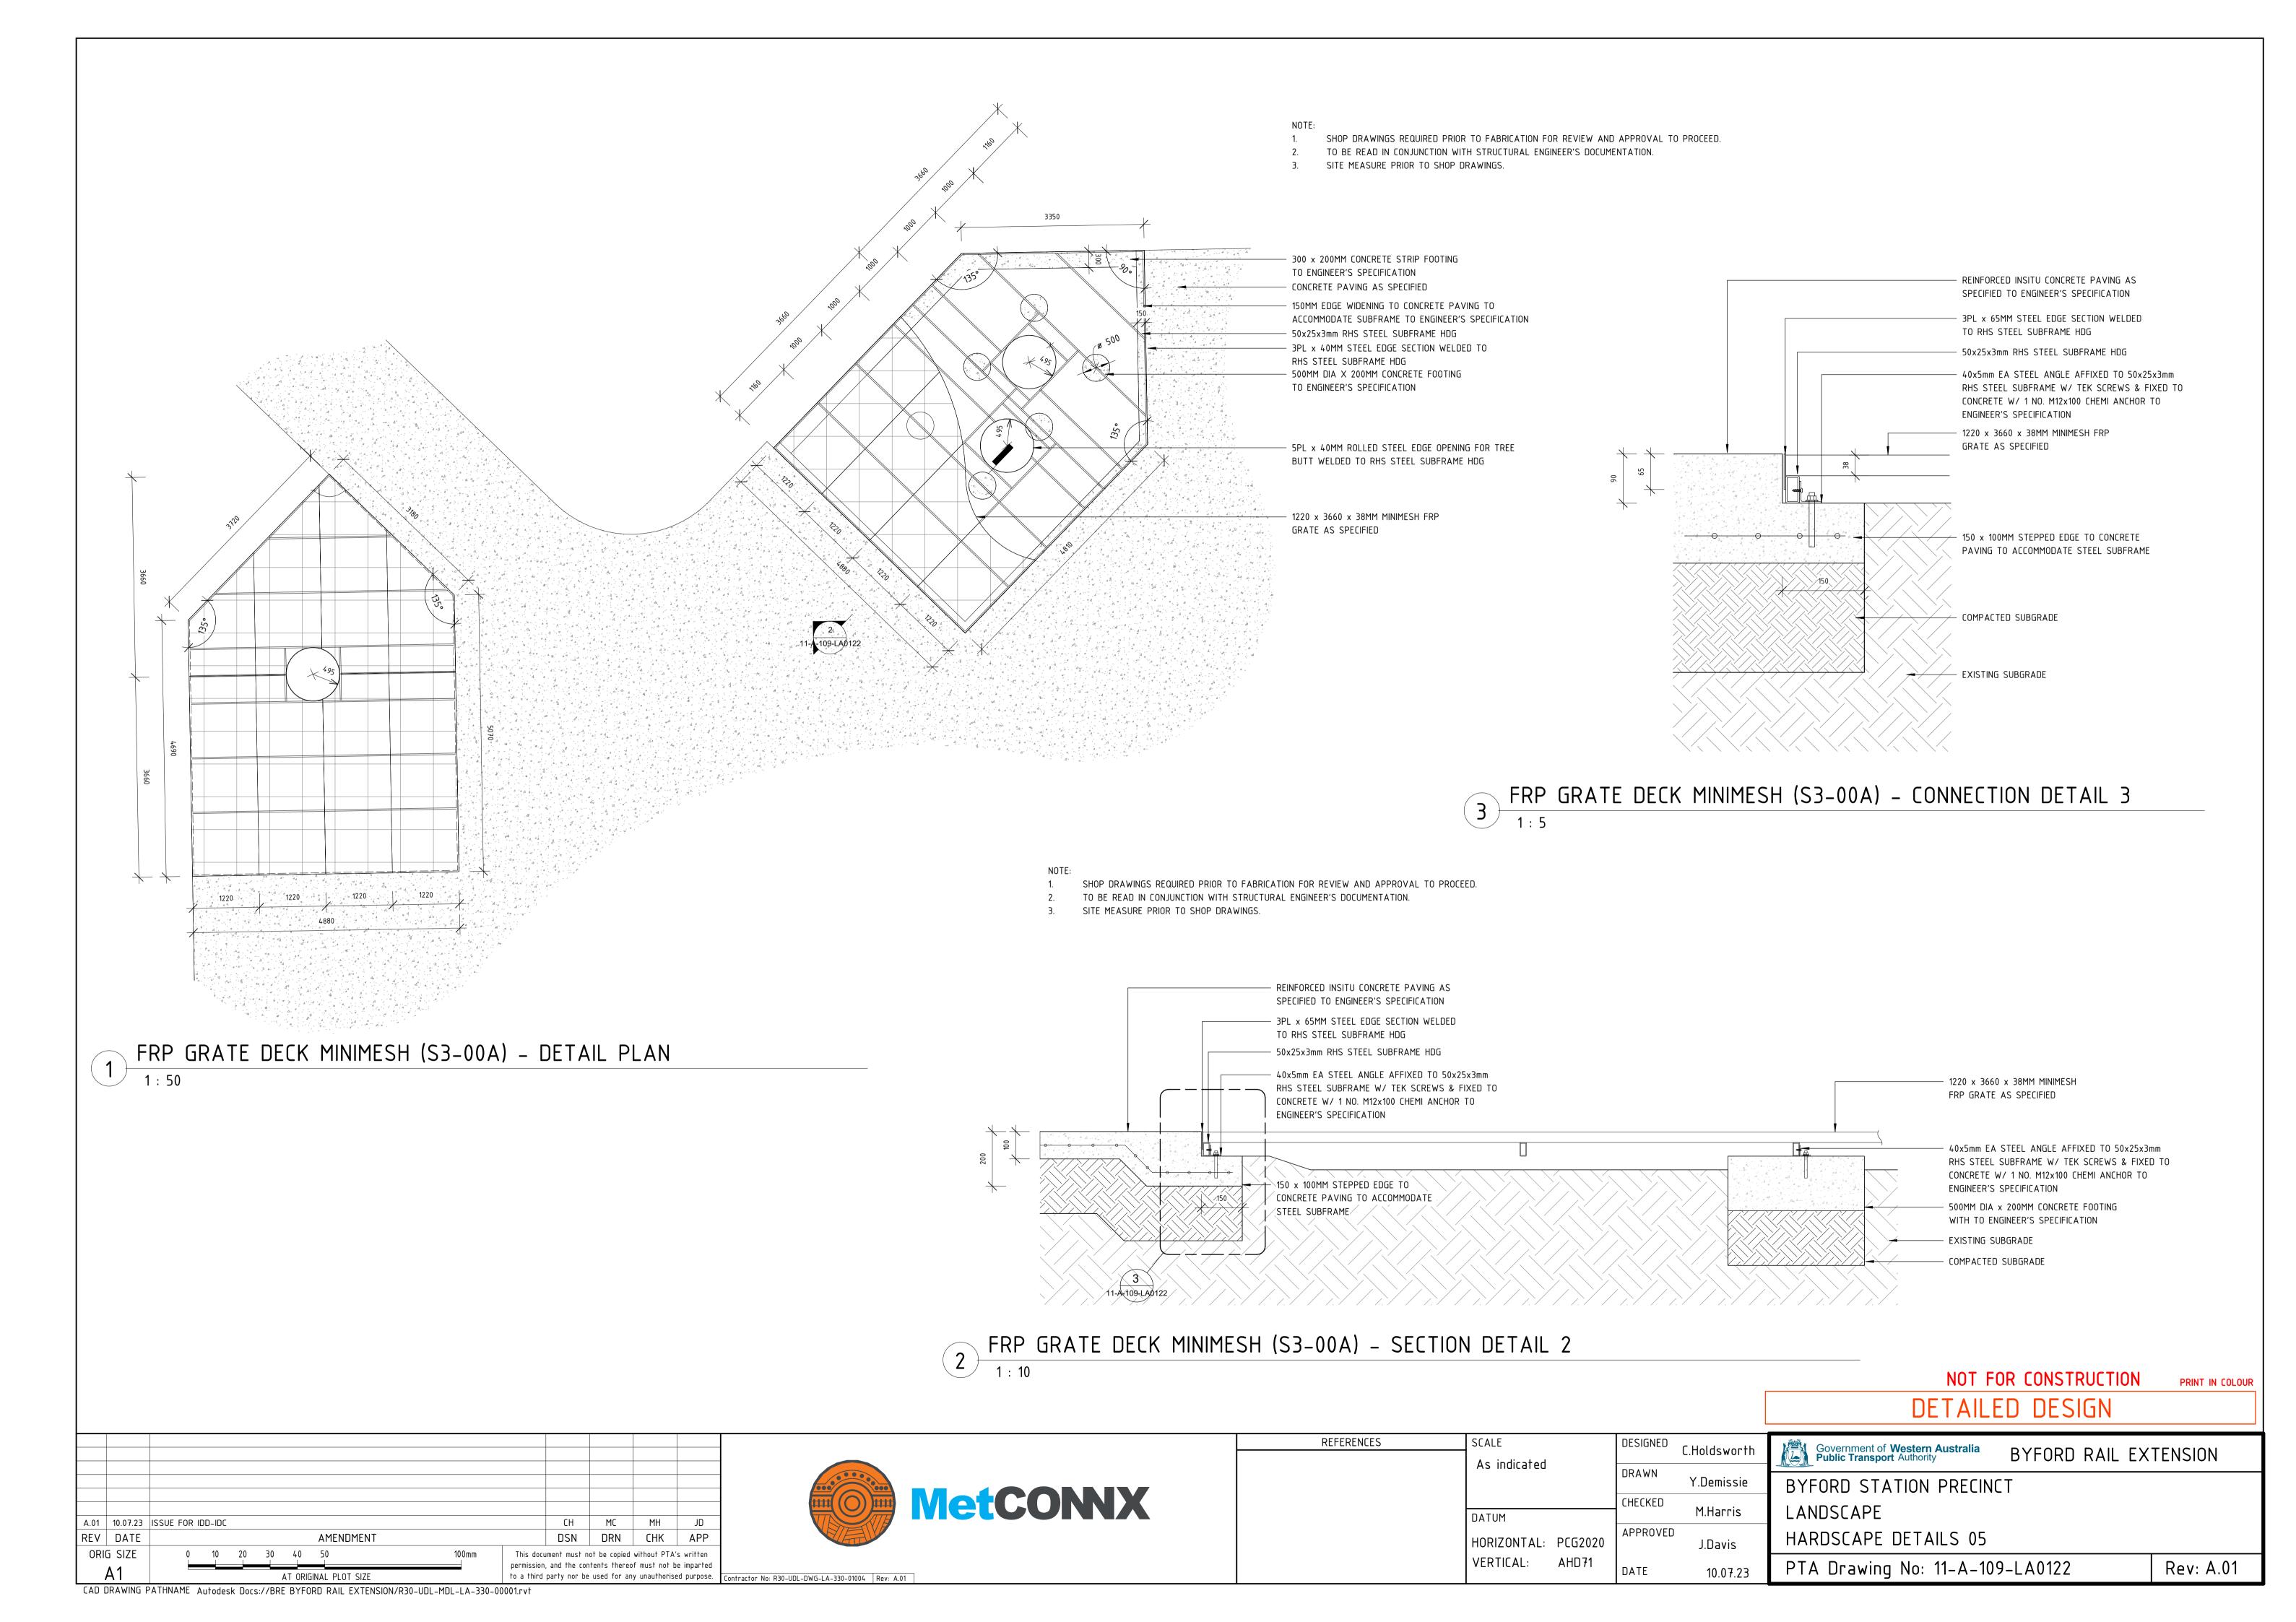

PRODUCT: BIKE RACK TO MEET AS. 2890 - BST03 SUPPLIER: STREET FURNITURE AUSTRALIA MODEL: 316 GRADE STAINLESS STEEL SEMI-HOOP BICYCLE RACK NUMBER OF: 10 INSTALL TO MANUFACTURERS SPECIFICATION. TO BE SURFACE FIXED.



PRODUCT: DUAL RUBBISH & RECYCLING BIN SUPPLIER: DRAFFIN STREET FURNITURE MODEL: 800 SERIES BIN SURROUNDS WITH SLOPED COVER - 240LT NUMBER OF: 5 INSTALL TO MANUFACTURERS SPECIFICATION. TO BE SURFACE FIXED.



PRODUCT: DRINK FOUNTAIN WITH DOG BUBBLER - (DF4-DB) SUPPLIER: STREET FURNITURE AUSTRALIA MODEL: STAINLESS STEEL NUMBER OF: 1 INSTALL TO MANUFACTURERS SPECIFICATION. TO BE SURFACE FIXED.



PRODUCT: STANDALONE ARIA BENCH SEAT SUPPLIER: STREET FURNITURE AUSTRALIA MODEL: SPOTTED GUM TIMBER WITH STEEL NUMBER OF: TBA INSTALL TO MANUFACTURERS SPECIFICATION. TO BE SURFACE FIXED.



DRINK FOUNTAIN (F3-01A)

1:10

REFERENCES




BENCH SEAT (F4-01A)

1:10



PRODUCT: ARIA 3-PERSON BENCH SEAT WITH BACK AND ARM REST SUPPLIER: STREET FURNITURE AUSTRALIA MODEL: SPOTTED GUM TIMBER AND STEEL NUMBER OF: 8 INSTALL TO MANUFACTURERS SPECIFICATION. TO BE SURFACE FIXED.


BENCH SEAT TOPPER (F4-01B)

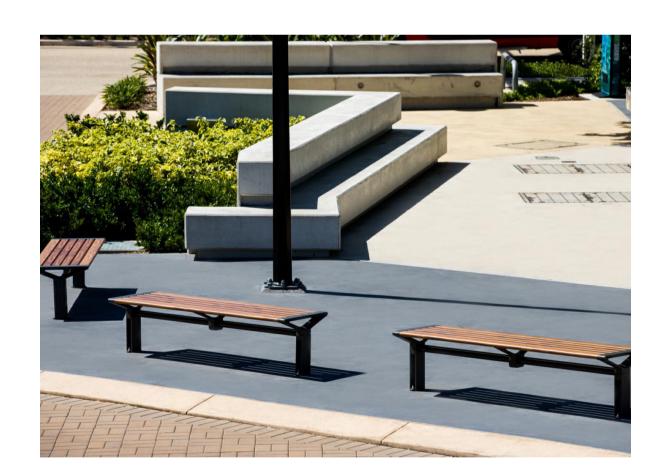

PRODUCT: ARIA 3-PERSON BENCH SEAT FLAT SUPPLIER: STREET FURNITURE AUSTRALIA MODEL: SPOTTED GUM TIMBER AND STEEL NUMBER OF: TBA INSTALL TO MANUFACTURERS SPECIFICATION. TO BE SURFACE FIXED.



BENCH SEAT FLAT (F4-01D)

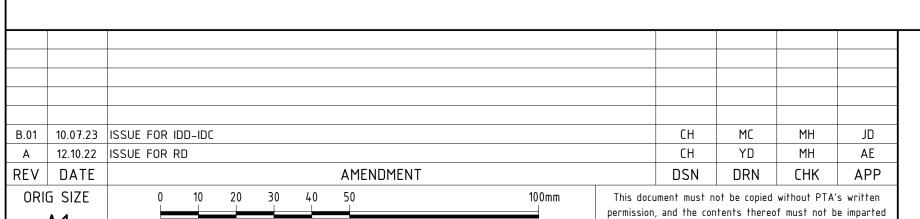



SCALE		DESIGNED	C.Holdsworth
1 : 10		DRAWN	Y.Demissie
DATUM		CHECKED	M.Harris
HORIZONTAL:	PCG2020	APPROVED	J.Davis
VERTICAL:	AHD71	DATE	10.07.23

DETAILED DESIGN Government of Western Australia Public Transport Authority BYFORD RAIL EXTENSION BYFORD STATION PRECINCT LANDSCAPE FURNITURE DETAILS 01 Rev: B.01 PTA Drawing No: 11-A-109-LA0123

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Contractor No: R30-UDL-DWG-LA-330-01005 Rev: B.01

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PRODUCT: LOG CLIMBING SCRAMBLE WITH WAVY FIBREGLASS SLIDE SUPPLIER: LYPA
MODEL: L000107 - FINISHED AS SUPPLIED
NUMBER OF: TBA
INSTALL TO MANUFACTURERS SPECIFICATION.
TO BE SURFACE FIXED.





PRODUCT: A FRAME BASKET SWING
SUPPLIER: LYPA
MODEL: L006601 - FINISHED AS SUPPLIED
NUMBER OF: TBA
INSTALL TO MANUFACTURERS SPECIFICATION.
TO BE SURFACE FIXED.





PRODUCT: JARRAH BALANCE SLEEPER WITH STUMPS SUPPLIER: LYPA
MODEL: L005201 - FINISHED AS SUPPLIED
NUMBER OF: TBA
INSTALL TO MANUFACTURERS SPECIFICATION.
TO BE SURFACE FIXED.

3 LYPA - BALANCE SLEEPER WITH STUMPS
1:10



PRODUCT: JARRAH TIMBER LOG STEPPERS
SUPPLIER: LYPA
MODEL: L005001 - FINISHED AS SUPPLIED
NUMBER OF: TBA
INSTALL TO MANUFACTURERS SPECIFICATION.
TO BE SURFACE FIXED.

LYPA - TIMBER STEPPER

1: 10

8PL 800 x 125MM CUSTOM STEEL BOLLARD
FRAME FULLY WELDED HDG AND
POWDERCOAT AS SPECIFIED

8PL 100 x 125MM STEEL SPACER FULLY
WELDED HDG AND POWDERCOAT AS
SPECIFIED
TIMBER INSERT NATURAL OILED AS SPECIFIED
AFFIXED 2No. M12 NUT AND BOLT ASSEMBLY

10PL 280 x 260MM BASE PLATE BUTT
WELDED TO 8PL STEEL BOLLARD FRAME

M12 THREADED ROD CHEMSET INTO THICKENED
CONCRETE WITH ACORN NUT AND WASHER
ASSEMBLY TO ENGINEER'S SPECIFICATION
REINFORCED CONCRETE PAVING TO
ENGINEER'S SPECIFICATION

BOLLARDS - FIXED (F7-03B) FRONT ELEVATION

1: 10

8PL 800 × 125MM CUSTOM STEEL BOLLARD
FRAME FULLY WELDED HDG AND
POWDERCOAT AS SPECIFIED

8PL 100 × 125MM STEEL SPACER FULLY
WELDED HDG AND POWDERCOAT AS SPECIFIED

TIMBER INSERT NATURAL OILED AS
SPECIFIED AFFIXED 2No. M12 NUT AND
BOLT ASSEMBLY

10PL 280 × 260MM BASE PLATE BUTT
WELDED TO 8PL STEEL BOLLARD FRAME

M12 THREADED ROD MIN. DEPTH 200MM CHEMSET
INTO THICKENED CONCRETE WITH ACORN NUT AND
WASHER ASSEMBLY TO ENGINEER'S SPECIFICATION
REINFORCED CONCRETE PAVING AS SPECIFIED

BOLLARDS - FIXED (F7-03B) SECTION

NOTE: REMOVABLE BOLLARD (F7-04B) TO BE DETAILED

B.01 10.07.23 ISSUE FOR IDD-IDC

A 12.10.22 ISSUE FOR RD

CH YD MH AE

REV DATE

ORIG SIZE

O 10 20 30 40 50

100mm

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Contractor No: R30-UDL-DWG-LA-330-01006 Rev: B.01

REFERENCES	SCALE		DESIGNED	C.Holdsworth
	1 : 10		DRAWN	Y.Demissie
				I 'Dellii22ie
	DATUM		CHECKED	M.Harris
	HORIZONTAL:	PCG2020	APPROVED	J.Davis
	VERTICAL:	AHD71	DATE	10 07 23

DETAILED DESIGN

Government of Western Australia BYFORD RAIL EXTENSION

BYFORD STATION PRECINCT

LANDSCAPE
FURNITURE DETAILS 02


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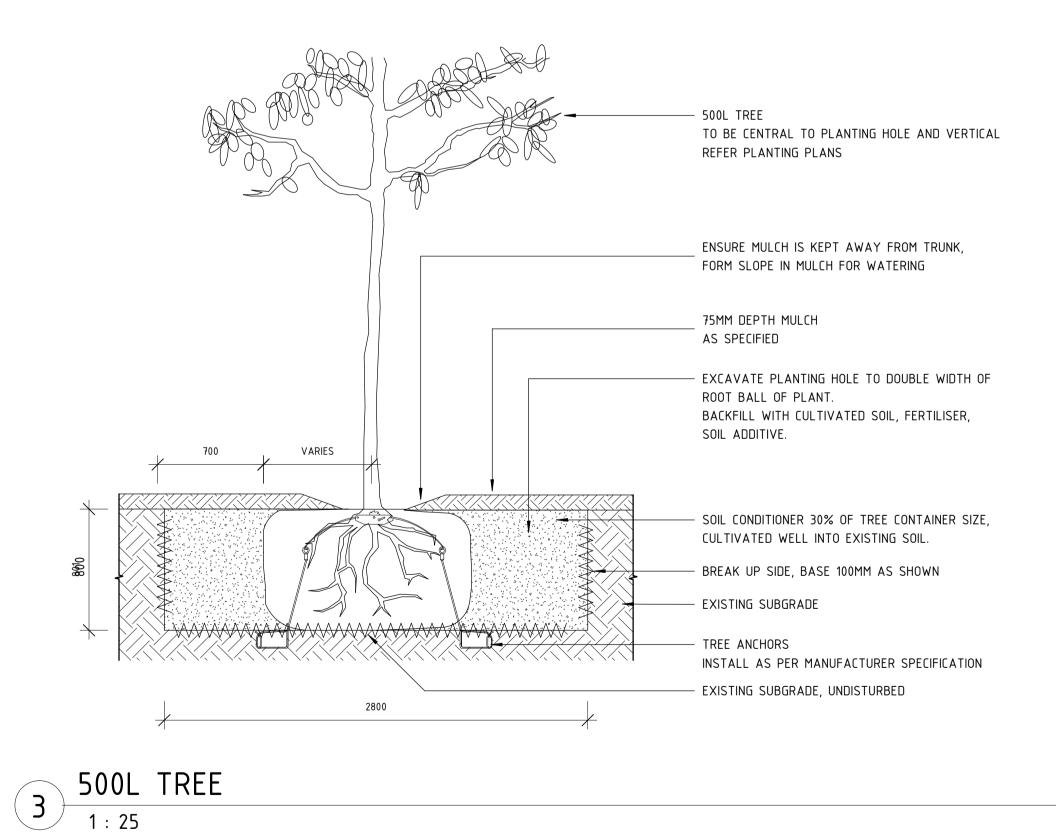
AT ORIGINAL PLOT SIZE to a third party nor be used for any unauthorised purpose.


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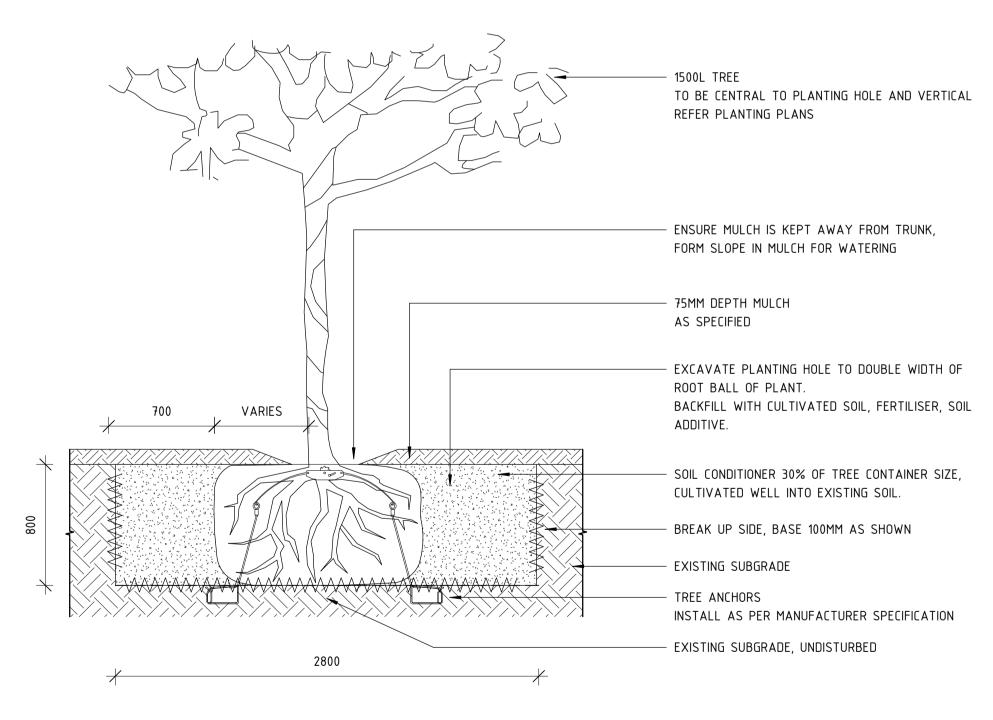
1 45L TREE

1: 20



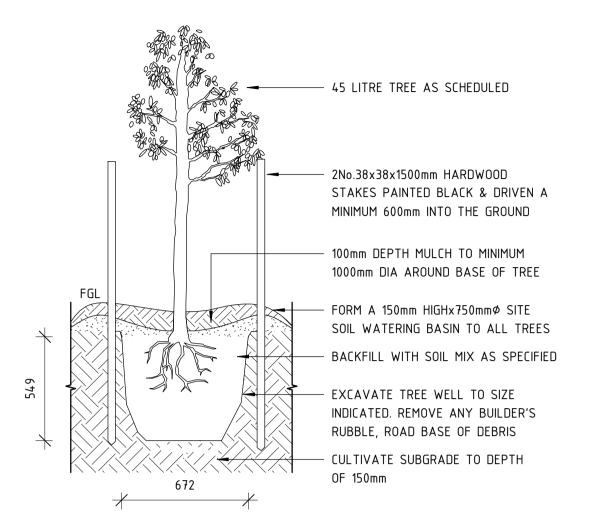

2 XANTHORREA PREISSII

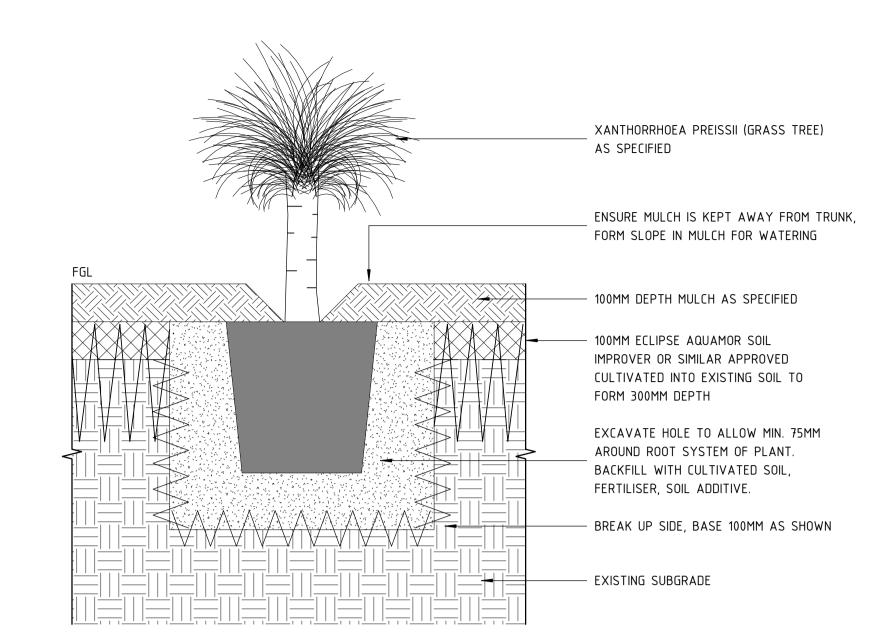

4 1500L TREE 1: 25

B.01 10.07.23 ISSUE FOR IDD-IDC

A 12.10.22 ISSUE FOR RD

CH YD MH AE

REV DATE

AMENDMENT

ORIG SIZE

AT ORIGINAL PLOT SIZE

AT ORIGINAL PLOT SIZE

Ontractor No: R30-UDL-DWG-LA-330-01010 Rev: B.01



REFERENCES	SCALE		DESIGNED	C.Holdsworth
	As indicated			C.Hotusworth
	A3 malcarca		DRAWN	Y.Demissie
			CHECKED	M 11 '
	DATUM			M.Harris
	HORIZONTAL:	PCG2020	APPROVED	J.Davis
	VERTICAL:	AHD71	DATE	10.07.23


DETAILED DESIGN
Government of Western Australia Public Transport Authority BYFORD RAIL EXTENSION
BYFORD STATION PRECINCT
LANDSCAPE
SOFTSCAPE DETAILS 01
PTA Drawing No: 11-A-109-LA0128 Rev: B.01

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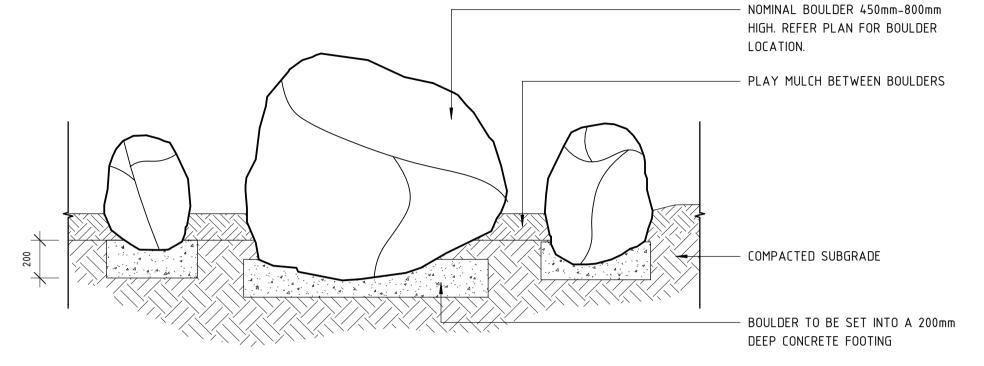
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CAD DRAWING PATHNAME Autodesk Docs://BRE BYFORD RAIL EXTENSION/R30-UDL-MDL-LA-330-00001.rvt




GRANITE BOULDERS TO BE SOURCED AND INSTALLED. MIN HEIGHT SIZE 450mm-MAX SIZE 800mm. GENERALLY BOULDERS TO BE BURIED APPROX. 1/3 OF EXPOSED HEIGHT AND INSTALLED WITH MORTAR BED.

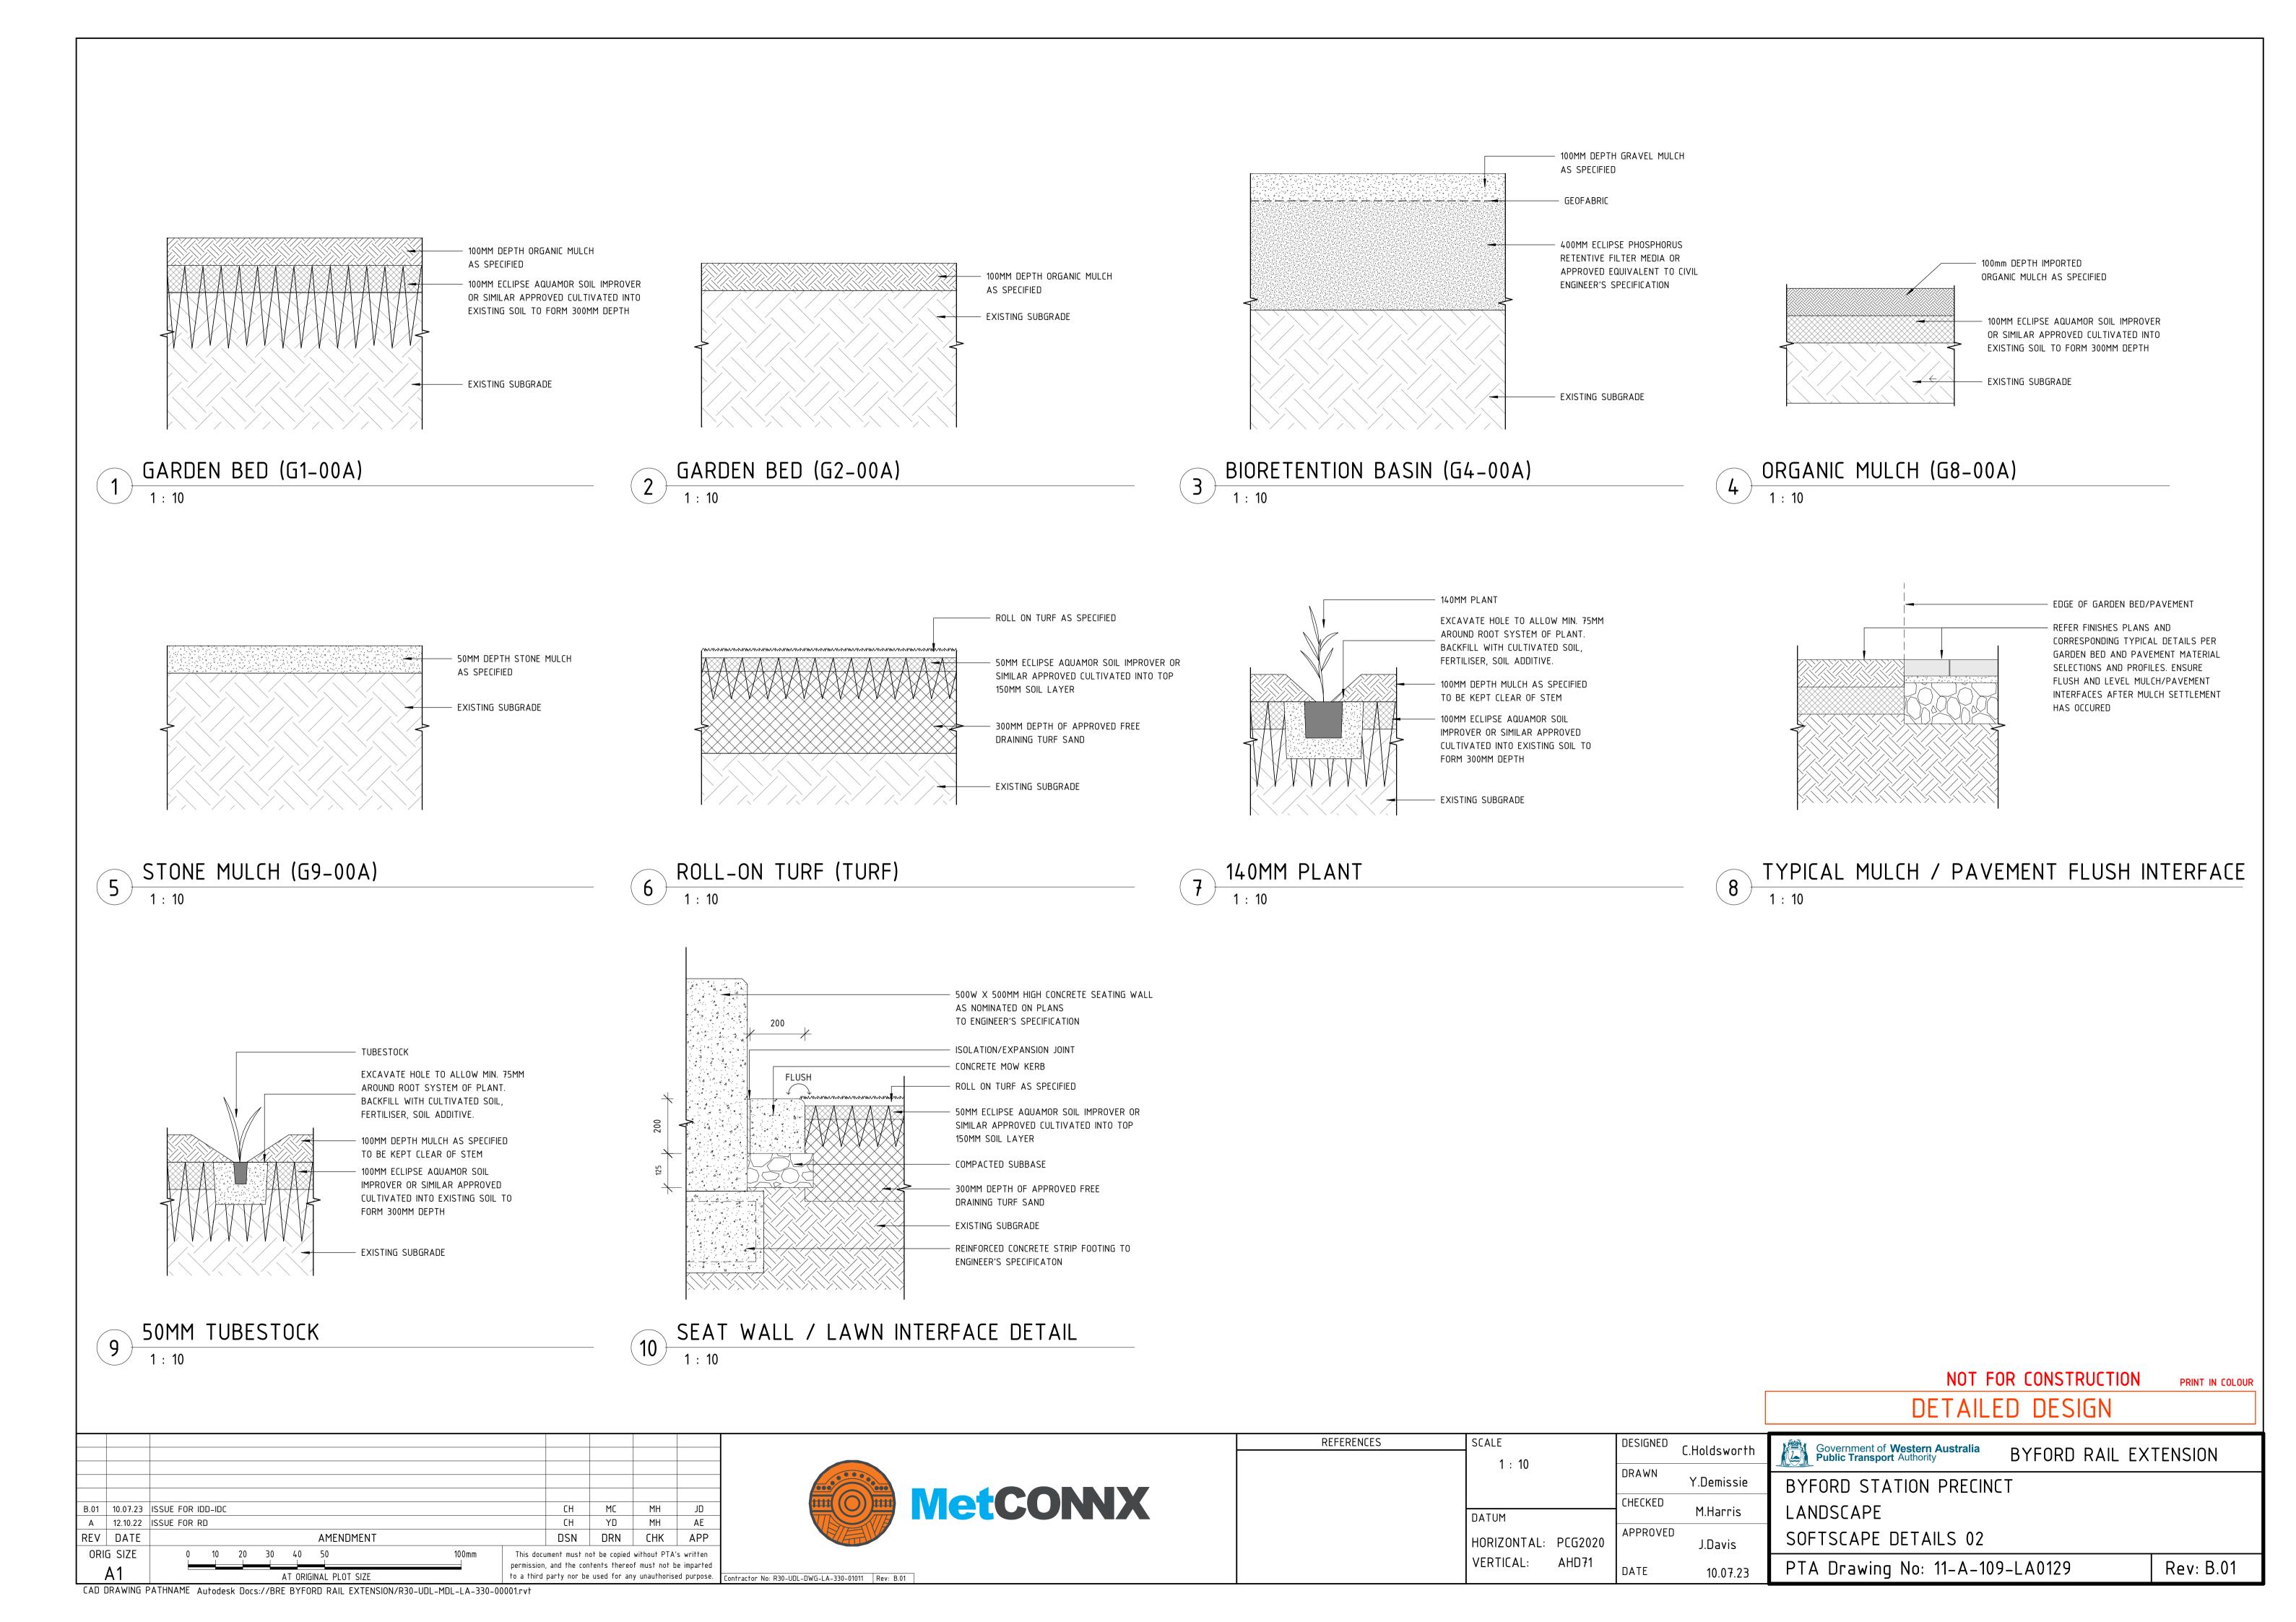

1 FEATURE BOULDERS
1: 20

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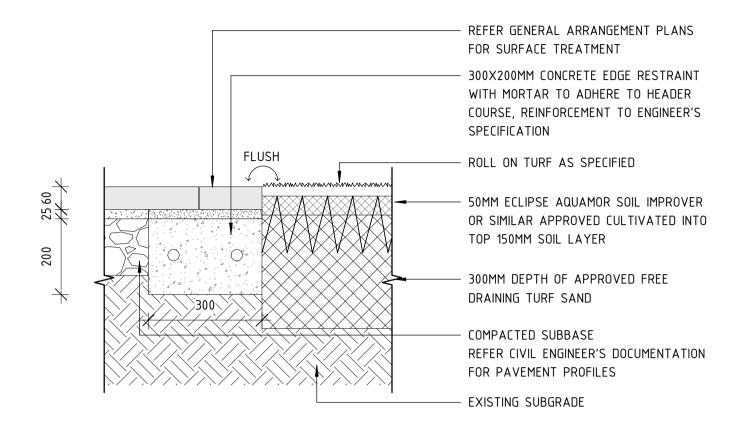


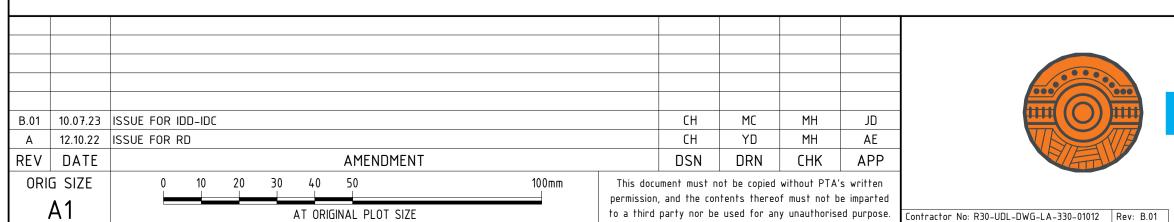	SCALE	DESIGNED	C.Holdsworth	
	1: 20		C.Hotusworth	
		DRAWN	Y.Demissie	
		CHECKED	M.Harris	
	DATUM		т.паптѕ	
	HORIZONTAL: PCG2020 VERTICAL: AHD71	APPROVED	J.Davis	
		DATE	10.07.23	

REFERENCES


Government of Western Australia Public Transport Authority BYFORD RAIL EXTENSION BYFORD STATION PRECINCT LANDSCAPE SOFTSCAPE DETAILS 03 PTA Drawing No: 11-A-109-LA0130 Rev: B.01

CAD DRAWING PATHNAME Autodesk Docs://BRE BYFORD RAIL EXTENSION/R30-UDL-MDL-LA-330-00001.rvt



UNIT PAVEMENT / TURF INTERFACE DETAIL

NOTE: ALL SUBSOIL DRAINAGE AS FOLLOW UNLESS NOTED OTHERWISE. 100mm Ø 'VINIDEX DRAINCOIL' SLOTTED AG PIPE WRAPPED IN GEOTEXTILE FABRIC. LAY IN 300mm DEEP TRENCH BACKFILLED WITH STONE AGGREGATE(14mm) WITH MINIMUM100mm COVER IN TURF AREAS. MIN GRADE 1:400. GEOTEXTILE FABRIC TO BE BIDIM A14 OR SIMILARLY APPROVED MATERIAL.

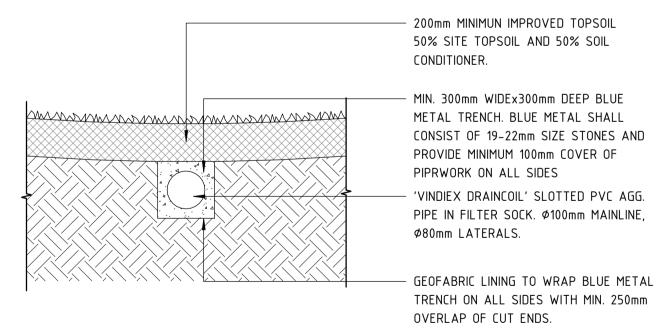


SUBSOIL DRAIN IN TURF

REFER GENERAL ARRANGEMENT PLANS FOR SURFACE TREATMENT 300X200MM CONCRETE EDGE RESTRAINT WITH MORTAR TO ADHERE TO HEADER COURSE, REINFORCEMENT TO ENGINEER'S SPECIFICATION 75MM DEPTH MULCH AS SPECIFIED 100MM ECLIPSE AQUAMOR SOIL IMPROVER OR SIMILAR APPROVED CULTIVATED INTO EXISTING SOIL TO FORM 300MM DEPTH COMPACTED SUBBASE REFER CIVIL ENGINEER'S DOCUMENTATION FOR PAVEMENT PROFILES - EXISTING SUBGRADE

2 UNIT PAVEMENT / GARDEN INTERFACE DETAIL
1: 10

NOTE: ALL SUBSOIL DRAINAGE AS FOLLOW UNLESS NOTED OTHERWISE. 100mm Ø 'VINIDEX DRAINCOIL' SLOTTED AG PIPE WRAPPED IN GEOTEXTILE FABRIC. LAY IN 300mm DEEP TRENCH BACKFILLED WITH STONE AGGREGATE(14mm) WITH MINIMUM100mm COVER IN TURF AREAS. MIN GRADE 1:400. GEOTEXTILE FABRIC TO BE BIDIM A14 OR SIMILARLY APPROVED MATERIAL.

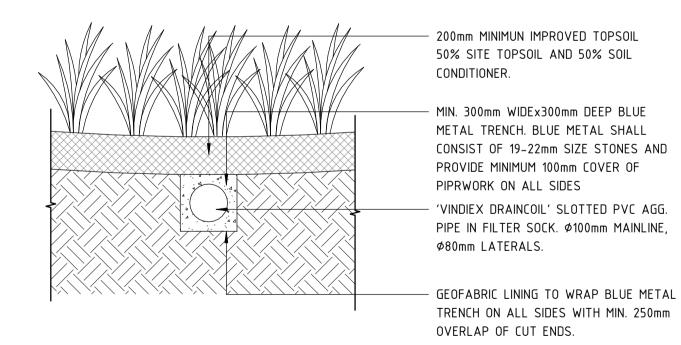

SUBSOIL DRAIN IN PLANTING

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Contractor No: R30-UDL-DWG-LA-330-01013 Rev: B.01

REFERENCES	SCALE	DESIGNED	C.Holdsworth
	As indicated	DRAWN	Y.Demissie
	DATUM	CHECKED	M.Harris
	HORIZONTAL: PCG2020	APPROVED	J.Davis
	VERTICAL: AHD71	DATE	10.07.23

DETAILED DESIGN Government of Western Australia
Public Transport Authority BYFORD RAIL EXTENSION BYFORD STATION PRECINCT LANDSCAPE SOFTSCAPE DETAILS 04 PTA Drawing No: 11-A-109-LA0131 Rev: B.01

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